#### SHEET LIST TABLE SHEET SHEET SHEET TITLE DESCRIPTION CV01 COVER SHEET NT01 NOTES EXISTING CONDITIONS & DEMOLITION PLAN EX01 OVERALL SITE PLAN OU01 OVERALL UTILITY PLAN EC01 INITIAL EROSION CONTROL INITIAL EROSION CONTROL INTERIM EROSION CONTROL INTERIM EROSION CONTROL FINAL EROSION CONTROL FINAL EROSION CONTROL OVERALL GRADING PLAN GR01 OVERLOT GRADING PLAN GR02 OVERLOT GRADING PLAN ASPEN ST. - OWEN AVE. PLAN & PROFILE 1 ASPEN ST. - OWEN AVE. PLAN & PROFILE 2 ASPEN ST. – OWEN AVE. PLAN & PROFILE 3 ASPEN ST. - OWEN AVE. PLAN & PROFILE 4 SPRUCE ST. PLAN & PROFILE 1 RD06 | SPRUCE ST. PLAN & PROFILE 2 MAPLE ST. PLAN & PROFILE 1 MAPLE ST. PLAN & PROFILE 2 MAPLE ST. PLAN & PROFILE 3 W. NELSON AVE. PLAN & PROFILE W MORGAN AVE. PLAN & PROFILE OAK ST PLAN & PROFILE W SHEPARD PLAN & PROFILE 1 W SHEPARD PLAN & PROFILE 2 CEDAR ST PLAN & PROFILE 1 CEDAR ST PLAN & PROFILE 2 RD17 | CEDAR ST PLAN & PROFILE 3 CURB RETURN PROFILE 1 CR02 CURB RETURN PROFILE 2 CURB RETURN PROFILE 3 ST01 STORM ALIGNMENT 1 ST02 STORM ALIGNMENT 1 ST03 STORM ALIGNMENT 2&9 ST04 STORM ALIGNMENT 3 ST05 STORM ALIGNMENT 3&4 DETENTION POND PLAN DETENTION POND DETAILS SANITARY PLAN & PROFILE SHEPARD AVE 1 SANITARY PLAN & PROFILE SHEPARD AVE 2 WATER PLAN & PROFILE SHEPARD AVE 1 WATER PLAN & PROFILE SHEPARD AVE 2 UTILITY PLAN & PROFILE MAPLE ST 1 UTILITY PLAN & PROFILE MAPLE ST 2 UTILITY PLAN & PROFILE NELSON ST UTILITY PLAN & PROFILE CEDAR ST UTILITY PLAN & PROFILE CEDAR ST UT10 UTILITY PLAN & PROFILE SPRUCE ST 1 UT11 UTILITY PLAN & PROFILE SPRUCE ST 2 UT12 UTILITY PLAN & PROFILE ASPEN ST 1 UT13 UTILITY PLAN & PROFILE ASPEN ST 2 UT14 UTILITY PLAN & PROFILE ASPEN ST 3 UTILITY PLAN & PROFILE ASPEN ST 4 DT01 DETAIL 1 DT02 DETAIL 2 DT03 DETAIL 2 CD01 DETAIL 1 CD02 DETAIL 2 CD03 DETAIL 3 L01 LANDSCAPE PLAN LANDSCAPE PLAN LANDSCAPE ENLARGEMENTS PLANT SCHEDULE & NOTES L05 DETAILS 01

PROPERTY DESCRIPTION:

A PARCEL OF LAND LOCATED IN THE SOUTHWEST QUARTER OF SECTION 26, TOWNSHIP 2 NORTH, RANGE 64 WEST OF THE 6TH PRINCIPAL MERIDIAN, COUNTY OF WELD, STATE OF COLORADO, BEING MORE PARTICULARLY DESCRIBED AS FOLLOWS:

LO6 DETAILS 02 AND AMENITIES

CONSIDERING THE SOUTH LINE OF SAID SECTION 26 TO BEAR SOUTH 89°24'19" WEST, A DISTANCE OF 2632.40 FEET BETWEEN A FOUND 3-1/4" ALUMINUM CAP MARKED "ALPHA ENGINEERING, 1/4, S26, S35, R64W, 1994, LS 25937" AT THE SOUTH QUARTER CORNER OF SAID SECTION 26 AND A FOUND 3-1/4" ALUMINUM CAP MARKED "T2N, R64W, S27, S26, S34, S35, 1999, PLS 13155" AT THE SOUTHWEST CORNER OF SAID SECTION 26 AS SHOWN HEREON, WITH ALL BEARINGS CONTAINED HEREIN RELATIVE THERETO.

BEGINNING AT THE SOUTHWEST CORNER OF SAID SECTION 26; THENCE ALONG THE WEST LINE OF THE SOUTHWEST QUARTER OF SAID SECTION 26 NORTH 00°23'34" WEST, A DISTANCE OF 1022.57 FEET TO A POINT ON THE SOUTH RIGHT-OF-WAY LINE OF THE BURLINGTON NORTHERN SANTA FE RAILROAD; THENCE ALONG SAID SOUTH RIGHT-OF-WAY LINE, NORTH 47°07'15" EAST, A DISTANCE OF 462.49 FEET TO A POINT ON THE SOUTH LINE EXTENDED OF STEWART SUBDIVISION, RECORDED IN THE RECORDS OF WELD COUNTY ON JULY 7, 1999 AT RECEPTION

NO. 2704562; THENCE ALONG SAID SOUTH LINE EXTENDED AND SOUTH LINE OF STEWART SUBDIVISION NORTH 89°24'00" EAST, A DISTANCE OF 721.21 FEET TO A POINT ON THE WEST RIGHT-OF-WAY LINE EXTENDED OF CEDAR STREET, AS DESCRIBED IN RIGHT-OF-WAY DEED RECORDED IN THE RECORDS OF WELD COUNTY ON MARCH 28, 1960 IN BOOK 1554, PAGE 356; THENCE ALONG SAID RIGHT-OF-WAY LINE EXTENDED, SOUTH 01°03'59" EAST, A DISTANCE OF 47.81 FEET TO THE NORTHWEST CORNER OF SAID CEDAR STREET RIGHT-OF-WAY; THENCE ALONG THE WEST RIGHT-OF-WAY LINE OF CEDAR STREET, SOUTH 01°03'59" EAST, A DISTANCE OF 1286.02 FEET TO A POINT ON THE SOUTH LINE OF THE SOUTHWEST QUARTER OF SAID SECTION 26; THENCE ALONG SAID SOUTH LINE, SOUTH 89°24'19" WEST, A DISTANCE OF 1077.95 FEET, MORE OR LESS, TO THE SOUTHWEST CORNER OF SAID SECTION 26 AND THE POINT OF BEGINNING.


CONTAINING 31.547 ACRES MORE OR LESS.

#### BASIS OF BEARINGS

ASSUMING THE SOUTH LINE OF THE SOUTHWEST QUARTER OF SECTION 26, TOWNSHIP 2 NORTH, RANGE 64 WEST OF THE SIXTH PRINCIPAL MERIDIAN, AS MONUMENTED BY A NO. 6 REBAR WITH 3-1/4 INCH ALUMINUM CAP MARKED "PLS 13155" AT THE SOUTHWEST CORNER OF SAID SECTION 26 AND A NO. 6 REBAR WITH A 3-1/2 INCH ALUMINUM CAP STAMPED PLS 25937 AT THE SOUTH QUARTER CORNER OF SAID SECTION 26 TO BEAR SOUTH 89°24'23" WEST, BEING A GRID BEARING OF THE COLORADO STATE PLANE COORDINATE SYSTEM, NORTH ZONE, NORTH AMERICAN DATUM 1983/2007, A DISTANCE OF 2632.46 FEET WITH ALL BEARINGS CONTAINED HEREIN RELATIVE THERETO.

# CONSTRUCTION DOCUMENTS VISTA WEST SUBDIVISION

LOCATED IN THE SOUTHWEST 1/4 OF SECTION 26, TOWNSHIP 2 NORTH, RANGE 64 WEST OF THE 6th PRINCIPAL MERIDIAN

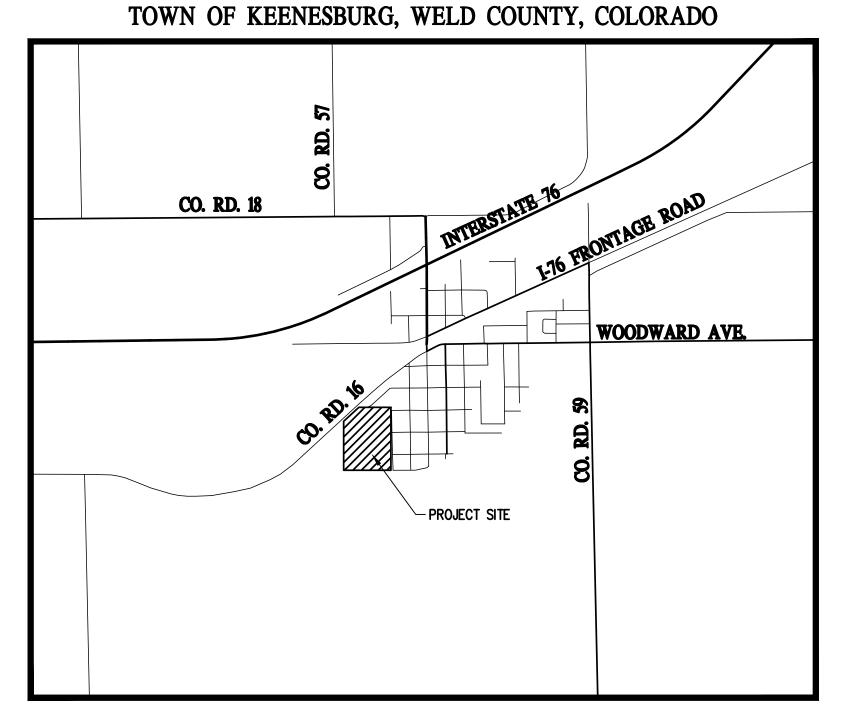

## VICINITY MAP SCALE: 1" = 2000'

60' ROW

#### 36' ₺ - ₺ 18' [[–Ը 18՝ Ն–โ 5' WALK 2.0%\_ 2.0% MOUNTABLE CURB - & GUTTER (TYP.) TYPICAL SECTION - LOCAL SECTION LINE ROW 10' TRACT 30' ROW VARIES MEANDERING 6'ROAD 24'EOA−@ WALK SIDE DITCH -PROPOSED GRADE — EXISTING GRADE - MATCH EXISTING GRADE -FUTURE GRADE 2.0%\_ - COMPACTED SUBGRADE

TYPICAL SECTION - W SHEPARD AVE.

(TEMPORARY HALF SECTION)

## **CONTACTS:**

MUNICIPALITY
TOWN OF KEENESBURG
91 W. BROADWAY AVENUE
KEENESBURG, CO 80643
TELEPHONE: (303) 732–4281



APPLICANT:
MSP INVESTMENT CO, LLP

MSP INVESTMENT CO, LLP
SUITE 940 NORTH TOWER
720 S. COLORADO BLVD.
DENVER, CO 80246
TELEPHONE: (303)399-9804
EMAIL: CHAD@MSPCOMPANIES.COM
CONTACT: CHAD RODRIGUEZ



PLANNING, CIVIL ENGINEER, & LANDSCAPE ARCHITECTURE


BASELINE ENGINEERING

112 N. RUBEY DRIVE, #210

GOLDEN, CO 80403

TELEPHONE: (303) 940–9966

TELEPHONE: (303) 940-9966
CONTACTS:
PLANNING - JESSIE STONBERG
ENGINEERING - MICHAEL LUJAN
LANDSCAPE ARCHITECTURE - JESSIE STONBERG

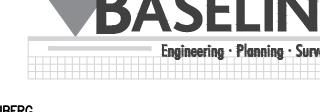

FIRE DISTRICT


SOUTHEAST WELD FIRE PROTECTION DISTRICT 95 W BROADWAY STREET KEENSBURG, CO 80643 TELEPHONE: (303) 732-4203 CONTACTS: THOMAS BEACH



WATER & SANITATION DISTRICT

TOWN OF KEENSBURG 91 W BROADWAY AVENUE KEENSBURG, CO 80643 TELEPHONE: (303) 732-4281



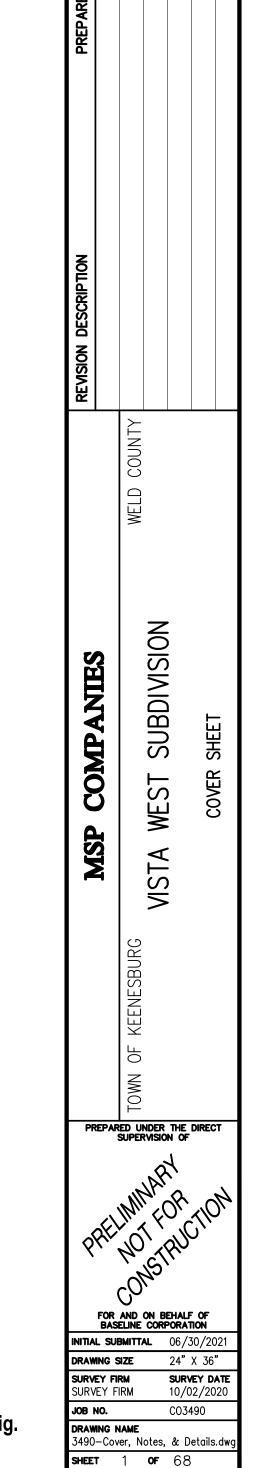

CV01



#### TOWN OF KEENESBURG GENERAL NOTES:

- ALL WORK WITHIN THE PUBLIC ROW OR EASEMENT SHALL CONFORM TO THE TOWN OF KEENESBURG CONSTRUCTION DESIGN SPECIFICATIONS.
- 2. THE CONTRACTOR IS RESPONSIBLE FOR OBTAINING ALL REQUIRED PERMITS PRIOR TO COMMENCEMENT OF ANY WORK ON THE PROJECT. A PERMIT FROM PUBLIC WORKS IS REQUIRED FOR ALL CONSTRUCTION IN PUBLIC ROW OR EASEMENTS. A PRECONSTRUCTION CONFERENCE SHALL BE HELD WITH TOWN REPRESENTATIVES BEFORE A PERMIT WILL BE ISSUED.
- 3. THE CONTRACTOR SHALL NOTIFY THE TOWN PROJECT REPRESENTATIVE AT LEAST 24 HOURS PRIOR TO DESIRED INSPECTION.
- 4. IT IS THE CONTRACTOR'S RESPONSIBILITY TO NOTIFY THE OWNER/DEVELOPER, AND THE TOWN, OF ANY PROBLEMS IN CONFORMING TO THE ACCEPTED PLANS FOR ANY ELEMENT OF THE PROPOSED IMPROVEMENTS, PRIOR TO ITS CONSTRUCTION.
- 5. IT IS THE RESPONSIBILITY OF THE DEVELOPER DURING THE CONSTRUCTION OR DESIGN ERRORS ENCOUNTERED BY THE CONTRACTOR DURING THE PROGRESS OF ANY PORTION OF THE PROJECT. IF, IN THE OPINION OF THE TOWN, THE MODIFICATIONS PROPOSED BY THE DEVELOPER, TO THE ACCEPTED PLANS, INVOLVE SIGNIFICANT CHANGES TO THE CHARACTER OF THE WORK, OR TO THE FUTURE CONTIGUOUS PUBLIC OR PRIVATE IMPROVEMENTS, THE DEVELOPER SHALL BE RESPONSIBLE FOR RESUBMITTING THE REVISED PLANS TO THE TOWN OF KEENESBURG FOR ACCEPTANCE PRIOR TO ANY FURTHER CONSTRUCTION RELATED TO THAT PORTION OF THE PROJECT. ANY IMPROVEMENTS NOT CONSTRUCTED IN ACCORDANCE WITH THE ACCEPTED PLANS, OR THE ACCEPTED REVISED PLANS, SHALL BE REMOVED AND RECONSTRUCTED ACCORDING TO THE APPROVED PLAN.
- 6. THE CONTRACTOR SHALL BE SOLELY AND COMPLETELY RESPONSIBLE FOR THE CONDITIONS AT AND ADJACENT TO THE JOB SITE, INCLUDING SAFETY OF ALL PERSONS AND PROPERTY, DURING THE PERFORMANCE OF THE WORK. THIS REQUIREMENT SHALL APPLY CONTINUOUSLY AND SHALL NOT BE LIMITED TO NORMAL WORKING HOURS. THE DUTY OF THE TOWN TO CONDUCT CONSTRUCTION REVIEW OF THE CONTRACTOR'S PERFORMANCE IS NOT INTENDED TO INCLUDE REVIEW OF THE ADEQUACY OF THE CONTRACTOR'S SAFETY MEASURES IN, ON, OR NEAR THE CONSTRUCTION SITE.
- THE CONTRACTOR SHALL PROVIDE ALL LIGHTS, SIGNS, BARRICADES, FLAG PERSONS, OR OTHER DEVICES NECESSARY TO PROVIDE FOR PUBLIC SAFETY IN ACCORDANCE WITH THE CURRENT MANUAL ON UNIFORM TRAFFIC CONTROL DEVICES.
- 8. THE CONTRACTOR IS RESPONSIBLE FOR THE PROTECTION OF ALL SURVEY MONUMENTS. ANY MONUMENT THAT MUST BE DESTROYED FOR CONSTRUCTION SHALL BE REPLACED BY A REGISTERED LAND SURVEYOR. THE CONTRACTOR SHALL ENGAGE THE SERVICES OF A LICENSED SURVEYOR PRIOR TO DISTURBING ANY MONUMENTS.
- 9. PRIOR TO FINAL PLACEMENT OF SURFACE PAVEMENT, ALL UNDERGROUND UTILITY MAINS SHALL BE INSTALLED, TESTED AND ACCEPTED, AND SERVICE CONNECTIONS STUBBED OUT BEYOND THE PROPERTY LINE, WHEN ALLOWED BY THE UTILITY. SERVICE FROM PUBLIC UTILITIES AND FROM SANITARY SEWERS SHALL BE MADE AVAILABLE FOR EACH LOT IN SUCH A MANNER THAT WILL NOT BE NECESSARY TO DISTURB THE STREET PAVEMENT, CURB, GUTTER, AND SIDEWALK WHEN CONNECTIONS ARE MADE.
- 10. COPIES OF RECORD DRAWING PLANS SHALL BE SUBMITTED TO THE TOWN OF KEENESBURG PRIOR TO INITIAL ACCEPTANCE OF THE PUBLIC IMPROVEMENTS.
- 11. BASIS OF BEARINGS: ASSUMING THE SOUTH LINE OF THE SOUTHWEST QUARTER OF SECTION 26, TOWNSHIP 2 NORTH, RANGE 64 WEST OF THE SIXTH PRINCIPAL MERIDIAN, AS MONUMENTED BY A NO. 6 REBAR WITH 3-1/4 INCH ALUMINUM CAP MARKED "PLS 13155" AT THE SOUTHWEST CORNER OF SAID SECTION 26 AND A NO. 6 REBAR WITH A 3-1/2 INCH ALUMINUM CAP STAMPED PLS 25937 AT THE SOUTH QUARTER CORNER OF SAID SECTION 26 TO BEAR SOUTH 89°24'23" WEST, BEING A GRID BEARING OF THE COLORADO STATE PLANE COORDINATE SYSTEM, NORTH ZONE, NORTH AMERICAN DATUM 1983/2007, A DISTANCE OF 2632.46 FEET WITH ALL BEARINGS CONTAINED HEREIN RELATIVE THERETO.
- 12. BENCHMARK: A SET NO. 5 REBAR WITH A 2-1/2 INCH ALUMINUM CAP "CP WIND", ELEVATION = 4936.01'
- 13. FOR SURVEY CONTROL AND DATUM INFORMATION, CONTACT BASELINE CORPORATION.
- 14. COORDINATES SHOWN ON THIS DRAWING ARE MODIFIED COLORADO STATE PLANE NORTH ZONE. TO REDUCE TO STATE PLANE COORDINATES, SCALE AT 0.99972715 (1.0002729245) ABOUT THE ORIGIN (0,0).
- 15. ALIQUOT MONUMENTS DESTROYED DURING CONSTRUCTION TO BE REPLACED BY PROFESSIONAL LAND SURVEYOR.

### STANDARD EROSION AND SEDIMENT CONTROL NOTES:

- LANDOWNERS AND/OR CONTRACTORS ARE RESPONSIBLE FOR OBTAINING A PERMIT FOR STORMWATER DISCHARGES ASSOCIATED WITH CONSTRUCTION ACTIVITIES FROM THE COLORADO DEPARTMENT OF HEALTH & ENVIRONMENT (CDPHE), AT LEAST TEN (10) DAYS PRIOR TO THE START OF CONSTRUCTION ACTIVITIES IF CONSTRUCTION ACTIVITIES WILL DISTURB 1 (ONE) OR MORE ACRES OF LAND, OR IF THE PROJECT BELONGS TO A COMMON PLAN OF DEVELOPMENT THAT WILL DISTURB 1 (ONE) OR MORE ACRES. IN THE EVENT THAT LOT/PARCEL, WHICH BELONGS TO A COMMON PLAN OF DEVELOPMENT THAT DISTURBED 1 (ONE) OR MORE ACRES, IS SOLD THEN THE NEW LANDOWNER AND/OR CONTRACTOR IS RESPONSIBLE FOR OBTAINING PERMIT COVERAGE FOR THAT LOT/PARCEL.
- 2. LANDOWNERS AND/OR CONTRACTORS ARE RESPONSIBLE FOR OBTAINING A GRADING PERMIT FROM THE TOWN IF CONSTRUCTION ACTIVITIES WILL DISTURB 1 (ONE) OR MORE ACRES OF LAND, OR IF THE PROJECT BELONGS TO A COMMON PLAN OF DEVELOPMENT THAT WILL DISTURB 1 (ONE) OR MORE ACRES.
- 3. THE PERMITTED LANDOWNER AND/OR CONTRACTOR MUST KEEP A COPY OF THE CDPHE STORMWATER DISCHARGE PERMIT, STORMWATER MANAGEMENT PLAN (SWMP) AND INSPECTION LOG AVAILABLE ON-SITE THROUGHOUT THE DURATION OF THE PROJECT. AND FOR AN ADDITIONAL THREE (3) YEARS AFTER INACTIVATION FORM IS FILED WITH THE STATE.
- 4. THE PERMITTED LANDOWNER AND/OR CONTRACTOR MAY INACTIVATE THE STATE PERMIT WHEN FINAL STABILIZATION IS REACHED. AS LONG AS ALL SOIL DISTURBING ACTIVITIES AT THE SITE HAVE BEEN COMPLETED AND A UNIFORM VEGETATIVE COVER HAS BEEN ESTABLISHED WITH A DENSITY OF AT LEAST 70 PERCENT OF PRE-DISTURBANCE LEVELS, OR EQUIVALENT PERMANENT, PHYSICAL EROSION REDUCTION METHODS HAVE BEEN EMPLOYED.
- 5. THE PERMITTED LANDOWNER AND/OR CONTRACTOR MUST PERFORM INSPECTIONS OF ALL BMPS EVERY 14 DAYS AND ALSO AFTER ANY SIGNIFICANT STORM EVENT (RAIN OR SNOWMELT) THAT MAY CAUSE EROSION TO ENSURE THAT BMPS ARE FUNCTIONING PROPERLY. INSPECTION LOGS MUST BE KEPT WITH THE SWMP. ALL NECESSARY MAINTENANCE AND REPAIR SHALL BE COMPLETED IMMEDIATELY.
- 6. ALL CONSTRUCTION PROJECTS, WHETHER THEY DISTURB LESS OR MORE THAN 1 (ONE) ACRE SHALL INSTALL, MAINTAIN AND REPAIR EROSION AND SEDIMENT CONTROL BEST MANAGEMENT PRACTICES (BMPS) ACCORDING TO THE STORMWATER MANAGEMENT PLAN (SWMP) AND/OR EROSION CONTROL PLAN TO ASSURE CONTINUED PERFORMANCE OF THEIR INTENDED FUNCTION. EROSION & SEDIMENT CONTROL MEASURES (BMPS) MUST BE INSTALLED PRIOR TO GRADING OR LAND DISTURBING ACTIVITIES.
- 7. LANDOWNERS AND/OR CONTRACTORS MUST ENSURE THAT VEHICLES DO NOT TRACK EARTH MATERIALS ONTO STREETS AND MUST IMMEDIATELY REMOVE SUCH MATERIALS IF THIS OCCURS. EITHER SWEEPING BY HAND OR THE USE OF STREET SWEEPERS IS ACCEPTABLE. FLUSHING OFF PAVED SURFACES WITH WATER IS PROHIBITED.
- 8. ALL LOADS OF CUT AND FILL MATERIAL IMPORTED TO OR EXPORTED FROM THE SITE SHALL BE PROPERLY COVERED TO PREVENT LOSS OF THE MATERIAL DURING TRANSPORTATION ON PUBLIC ROW.
- 9. THE USE OF DIRT RAMPS IS PROHIBITED. A ROCK PAD ENTRANCE SHOULD BE INSTALLED WHERE CONSTRUCTION VEHICLES NEED TO ENTER OR EXIT FROM AN UNPAVED AREA INTO A PAVED ROAD.
- 10. LANDOWNERS AND/OR CONTRACTORS ARE RESPONSIBLE FOR CONTROLLING WASTE SUCH AS DISCARDING BUILDING MATERIALS, CONCRETE TRUCK WASHOUT, CHEMICALS, LITTER AND SANITARY WASTE, AS APPLICABLE.
- 11. WASTE COLLECTION AREAS SHOULD BE LOCATED AWAY FROM THE STORM DRAINAGE SYSTEM. CONSIDERATION SHOULD BE GIVEN TO COVERING WASTE STORAGE DUMPSTERS, TO BE ABLE TO CONTAIN WINDBLOWN MATERIALS.
- 12. THE DISCHARGE OF ANY WATER CONTAMINATED BY WASTE PRODUCTS FROM CUTTING OPERATIONS TO THE STORM SEWER SYSTEM IS PROHIBITED. ALL STORM SEWER FACILITIES ADJACENT TO ANY LOCATION WHERE PAVEMENT CUTTING OPERATIONS INVOLVING ROAD/CONCRETE CUTTING NEED TO BE PROTECTED. ALL WASTE PRODUCTS GENERATED DURING CUTTING ACTIVITIES MUST BE REMOVED ON A DAILY BASIS.
- 13. WATER USE TO CLEAN CEMENT/CONCRETE TRUCKS SHALL BE DISCHARGED INTO A CONCRETE WASHOUT AREA (CWA). THE PREDEFINED CONTAINMENT AREA MUST BE IDENTIFIED WITH A SIGN, AND SHALL ALLOW THE LIQUIDS TO INFILTRATE, EVAPORATE OR DRY OUT. DRIED CONCRETE WASTE SHALL BE REMOVED AND PROPERLY DISPOSED OF.
- 14. THE DISCHARGE OF SANITARY WASTE IN THE STORM SEWER SYSTEM IS PROHIBITED. PORTABLE TOILETS MUST BE PLACED ON PERMEABLE SURFACES, AWAY FROM THE CURBSIDE AND AWAY FROM STORM INLETS AND/OR DRAINAGE WAYS.
- 15. SPILL PREVENTION AND CONTAINMENT BMP'S FOR CONSTRUCTION MATERIALS, WASTE AND FUEL MUST BE PROVIDED. SPILLS THAT MAY REACH THE STORM SEWER SYSTEM MUST BE REPORTED ACCORDING TO FEDERAL, STATE AND COUNTY REGULATIONS.
- 16. STORM INLETS WITHIN AND/OR ADJACENT TO THE CONSTRUCTION SITE SHOULD BE PROTECTED. ANY PONDING OF STORMWATER AROUND INLET PROTECTION MUST NOT CAUSE EXCESSIVE INCONVENIENCE OR DAMAGE TO ADJACENT AREAS OR STRUCTURES.
- 17. RUNOFF FROM STOCKPILED AREA MUST BE CONTROLLED. SOILS THAT WILL BE STOCKPILED FOR MORE THAN 30 DAYS SHALL BE PROTECTED FROM WIND AND WATER EROSION WITHIN 14 DAYS OF STOCKPILE CONSTRUCTION (MULCH & SEEDING, EROSION CONTROL BLANKETS, ETC). ANY STOCKPILE LOCATED NEAR A DRAINAGE WAY, MUST BE PROVIDED WITH ADDITIONAL BMPS PROTECTION SUCH AS TEMPORARY DIKES OR SILT FENCE.

#### STANDARD EROSION AND SEDIMENT CONTROL NOTES (CONTINUED:

- 18. NATURAL VEGETATION SHALL BE PRESERVED AND PROTECTED WHENEVER POSSIBLE. REMOVAL OR DISTURBANCE OF EXISTING VEGETATION SHALL BE LIMITED TO THE AREA REQUIRED FOR IMMEDIATE CONSTRUCTION OPERATIONS. DISTURBED AREAS THAT MAY NOT BE AT FINAL GRADE BUT WILL REMAIN DORMANT (UNDISTURBED) FOR LONGER THAN 30 DAYS SHOULD BE STABILIZED WITHIN 14 DAYS.
- 19. FUGITIVE DUST EMISSIONS RESULTING FROM GRADING ACTIVITIES AND/OR WIND SHALL BE CONTROLLED.
- 20. ALL TEMPORARY EROSION AND SEDIMENT CONTROL MEASURES SHALL BE REMOVED AFTER THE SITE HAS ACHIEVED FINAL STABILIZATION AND THE PERMIT HAS BEEN INACTIVATED. THE STORMWATER VOLUME CAPACITY OF PONDS MUST BE RESTORED, AND STORM SEWER LINES AND/OR DRAINAGE INFRASTRUCTURE SHOULD BE CLEANED UPON COMPLETION OF PROJECT.
- 21. CONDITIONS IN THE FIELD MAY WARRANT EROSION AND SEDIMENT CONTROL MEASURES IN ADDITION TO WHAT IS SHOWN ON THE SWMP AND/OR EROSION CONTROL PLAN. THE LANDOWNER OR CONTRACTOR SHALL IMPLEMENT WHATEVER MEASURES ARE DETERMINED NECESSARY, AS DIRECTED BY THE COUNTY.
- 22. ALL AREAS NOT LANDSCAPED OR COVERED BY OTHER PERMANENT SURFACES SHALL BE RESEEDED PER TABLE RV-10 GRASS SEEDING TABLES BASED ON RANGE SITES FOR SANDY MEADOW AND SANDY PLAINS SITE CONDITIONS, AS CONTAINED IN WELD COUNTY CODE, CHAPTER 8, ARTICLE XI - STORM DRAINAGE CRITERIA, DIVISION I - GENERAL PROVISIONS, CHAPTER 12 - REVEGETATION.

#### **LEGEND**

EXISTING LINET	YPES	PROPOSED LINETYPES	
81 <u></u>		<del></del> 81	MINOR CONTOUR (1' INTERVAL)
<del></del>		5280	MAJOR CONTOUR (5' INTERVAL)
			PROPERTY BOUNDARY
			LOT LINE
			EASEMENT
			EDGE OF ASPHALT
			EDGE OF GRAVEL
			CURB AND GUTTER (SPILL/CATC
xxx	x	<del></del>	WIRE FENCE
<u> </u>	<b>&gt;</b> ··	$-\!$	DITCH FLOWLINE
——— W ———	- W	——— w ———	WATER LINE
——— WS —	- WS	WS	WATER SERVICE
SAN	- SAN	SAN	SANITARY SEWER MAIN
——— SS ————	- SS ———	SS	SANITARY SEWER SERVICE
——— ST ———	- ST ———		STORM SEWER
OHU	- OHU	——— OHU ———	OVERHEAD UTILITY
— т	т ———	T	UNDERGROUND TELEPHONE

SYMBOLS	SYMBOLS	
25.4±	<u>25.36</u>	SPOT ELEVATION
3:1	<b>3</b> :1	NOMINAL SLOPE ON CUT OR FILL
$\Rightarrow$	$\rightarrow$	FLOW DIRECTION, TYPICALLY ON PAVED SURFACE
-	<b>~</b>	FLOW DIRECTION, TYPICALLY IN GRASSED SWALE
770		FIRE HYDRANT
W	H	WATER VALVE
(\$)	<b>S</b>	SANITARY MANHOLE
		CONCRETE FLARED END SECTION
-\\	\$	LIGHT POLE
Ø	Ø	POWER POLE




COMPANIES

MSP

INITIAL SUBMITTAL 06/30/20 DRAWNG SIZE 24" X 36" SURVEY DATI

SURVEY FIRM SURVEY FIRM 10/02/202 JOB NO. CO3490 DRAWING NAME 3490—Cover, Notes, & Details.dw **SHEET** 2 **OF** 68


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:\co3490 — Summerfield — Keenesbura\Drawinas\Sketch Plan\3490 UTII.ITY.dwg. 6/30/2021 9:07:10 AM. Rvan Schultz

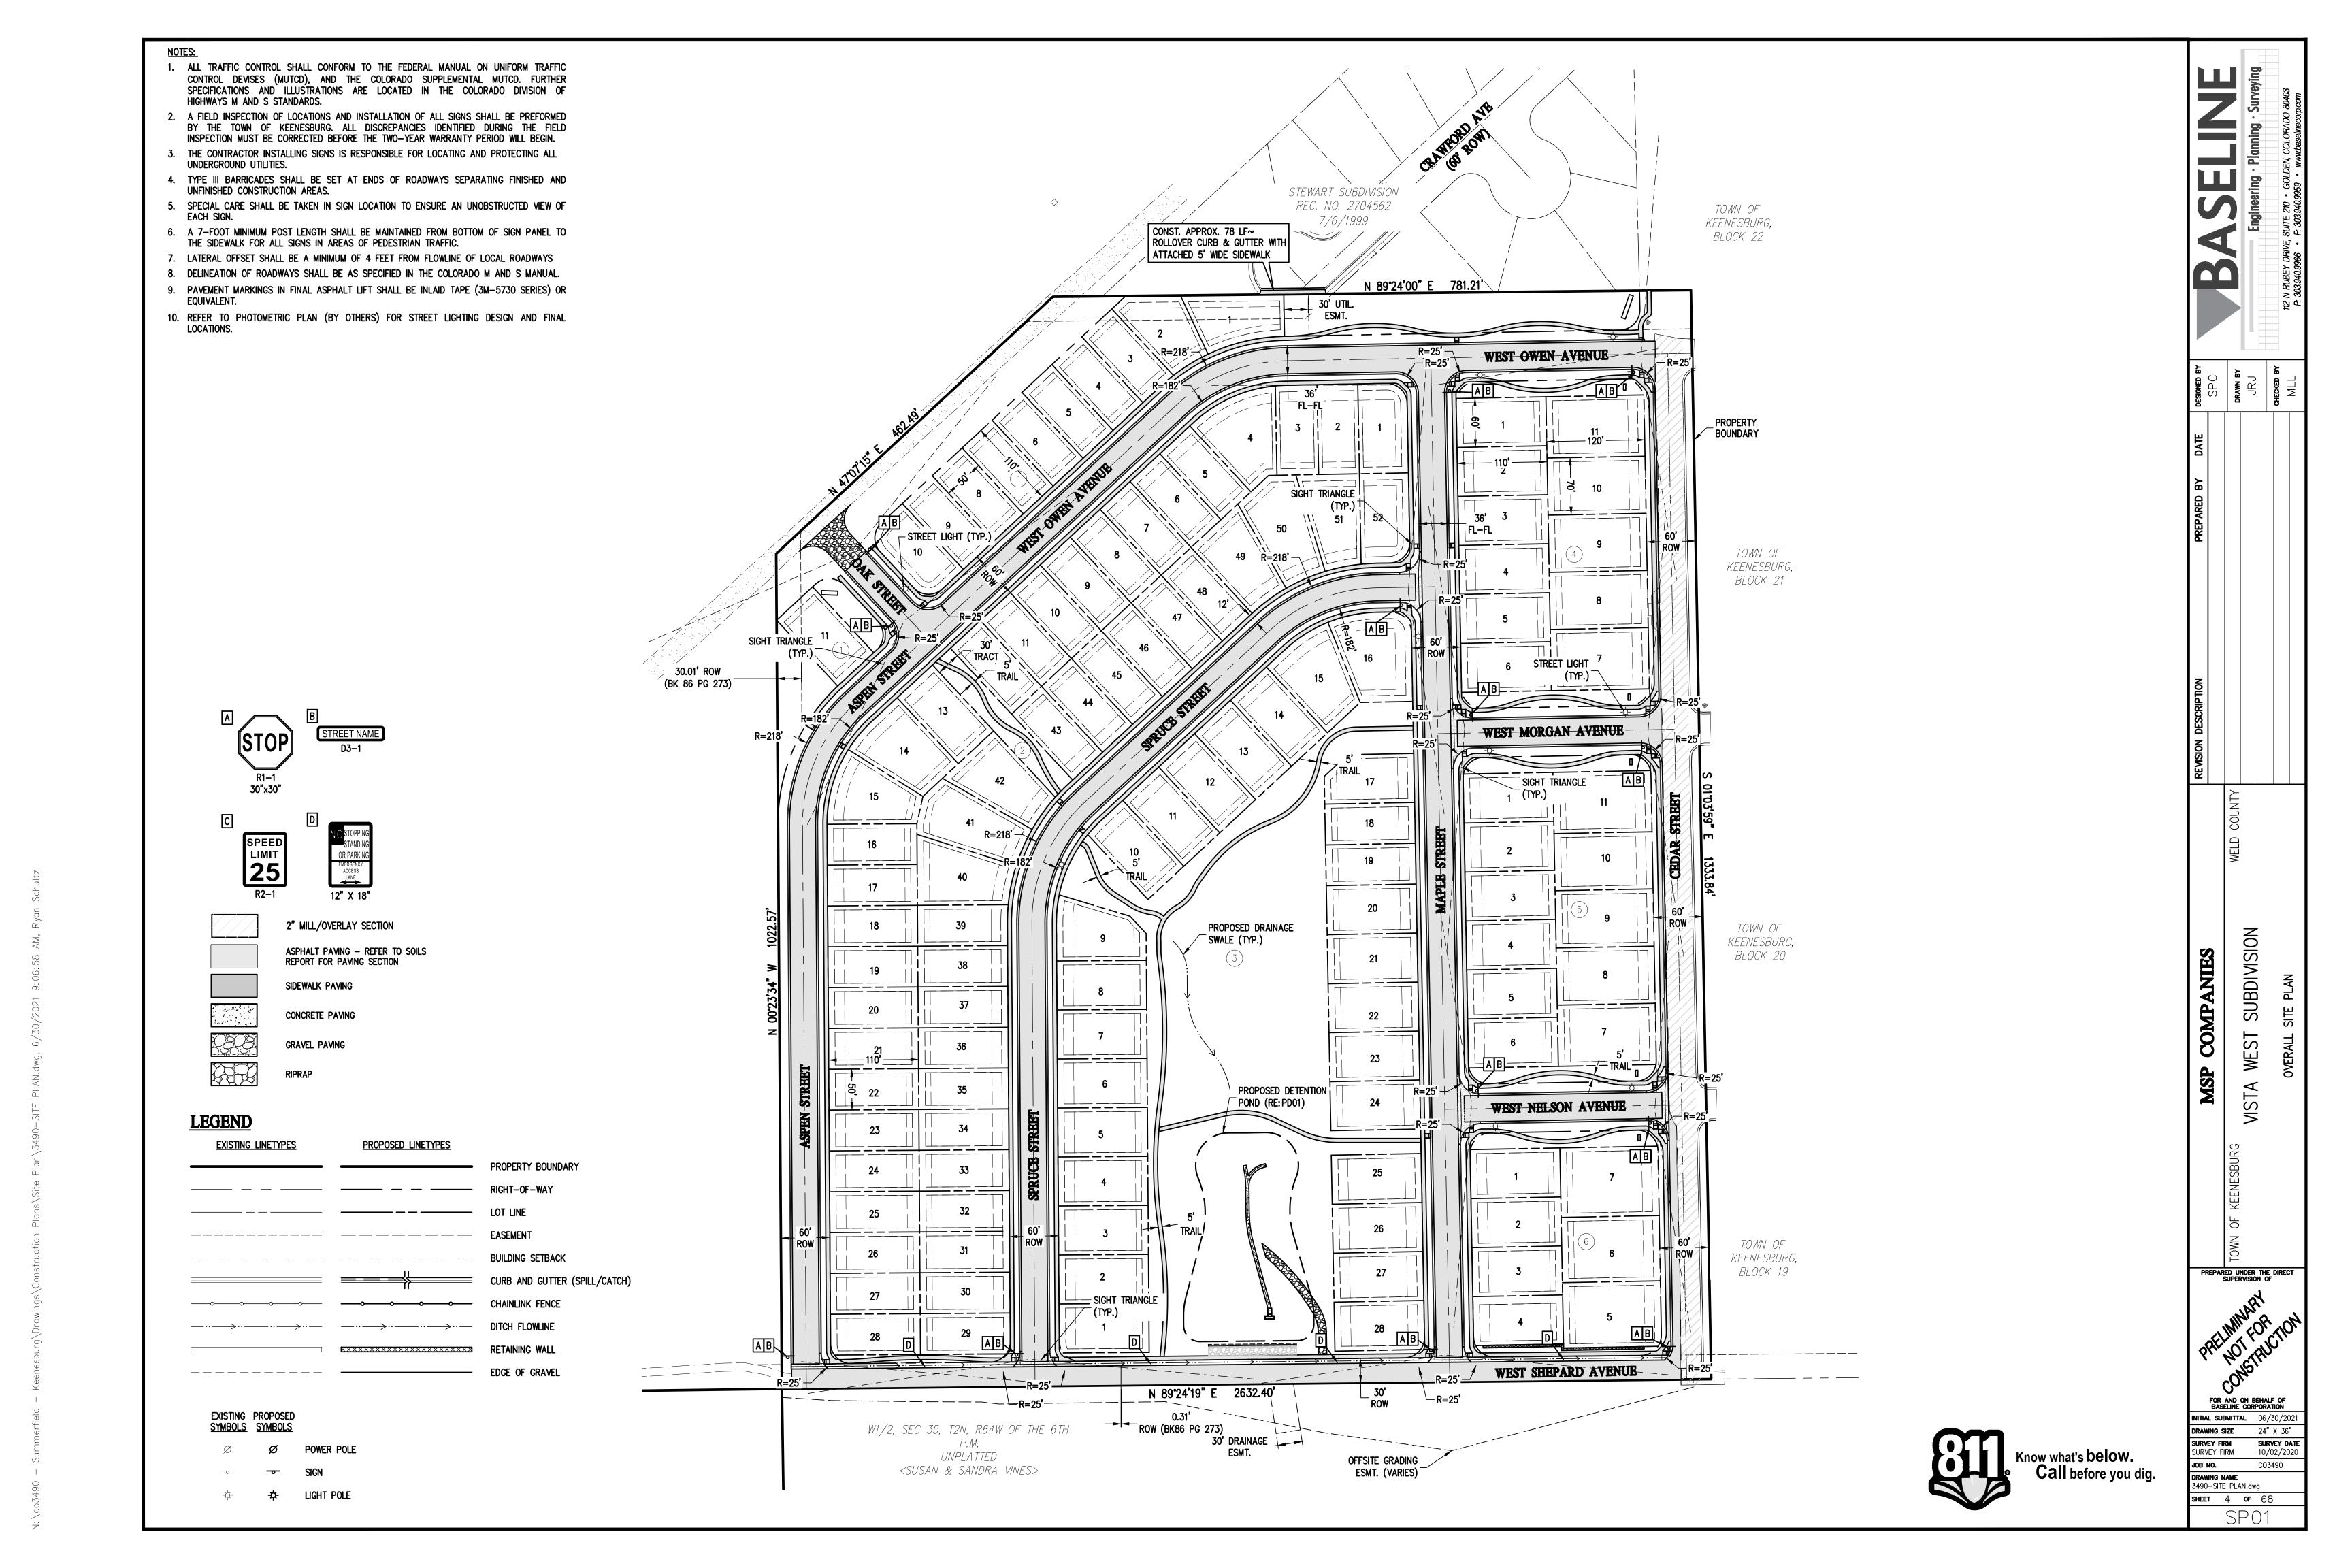INITIAL/INTERIM BMP'S TO BE REMOVED AFTER FINAL STABILIZATION


OF THE SITE IS COMPLETE



MATCHLINE SEE SHEET ECO1

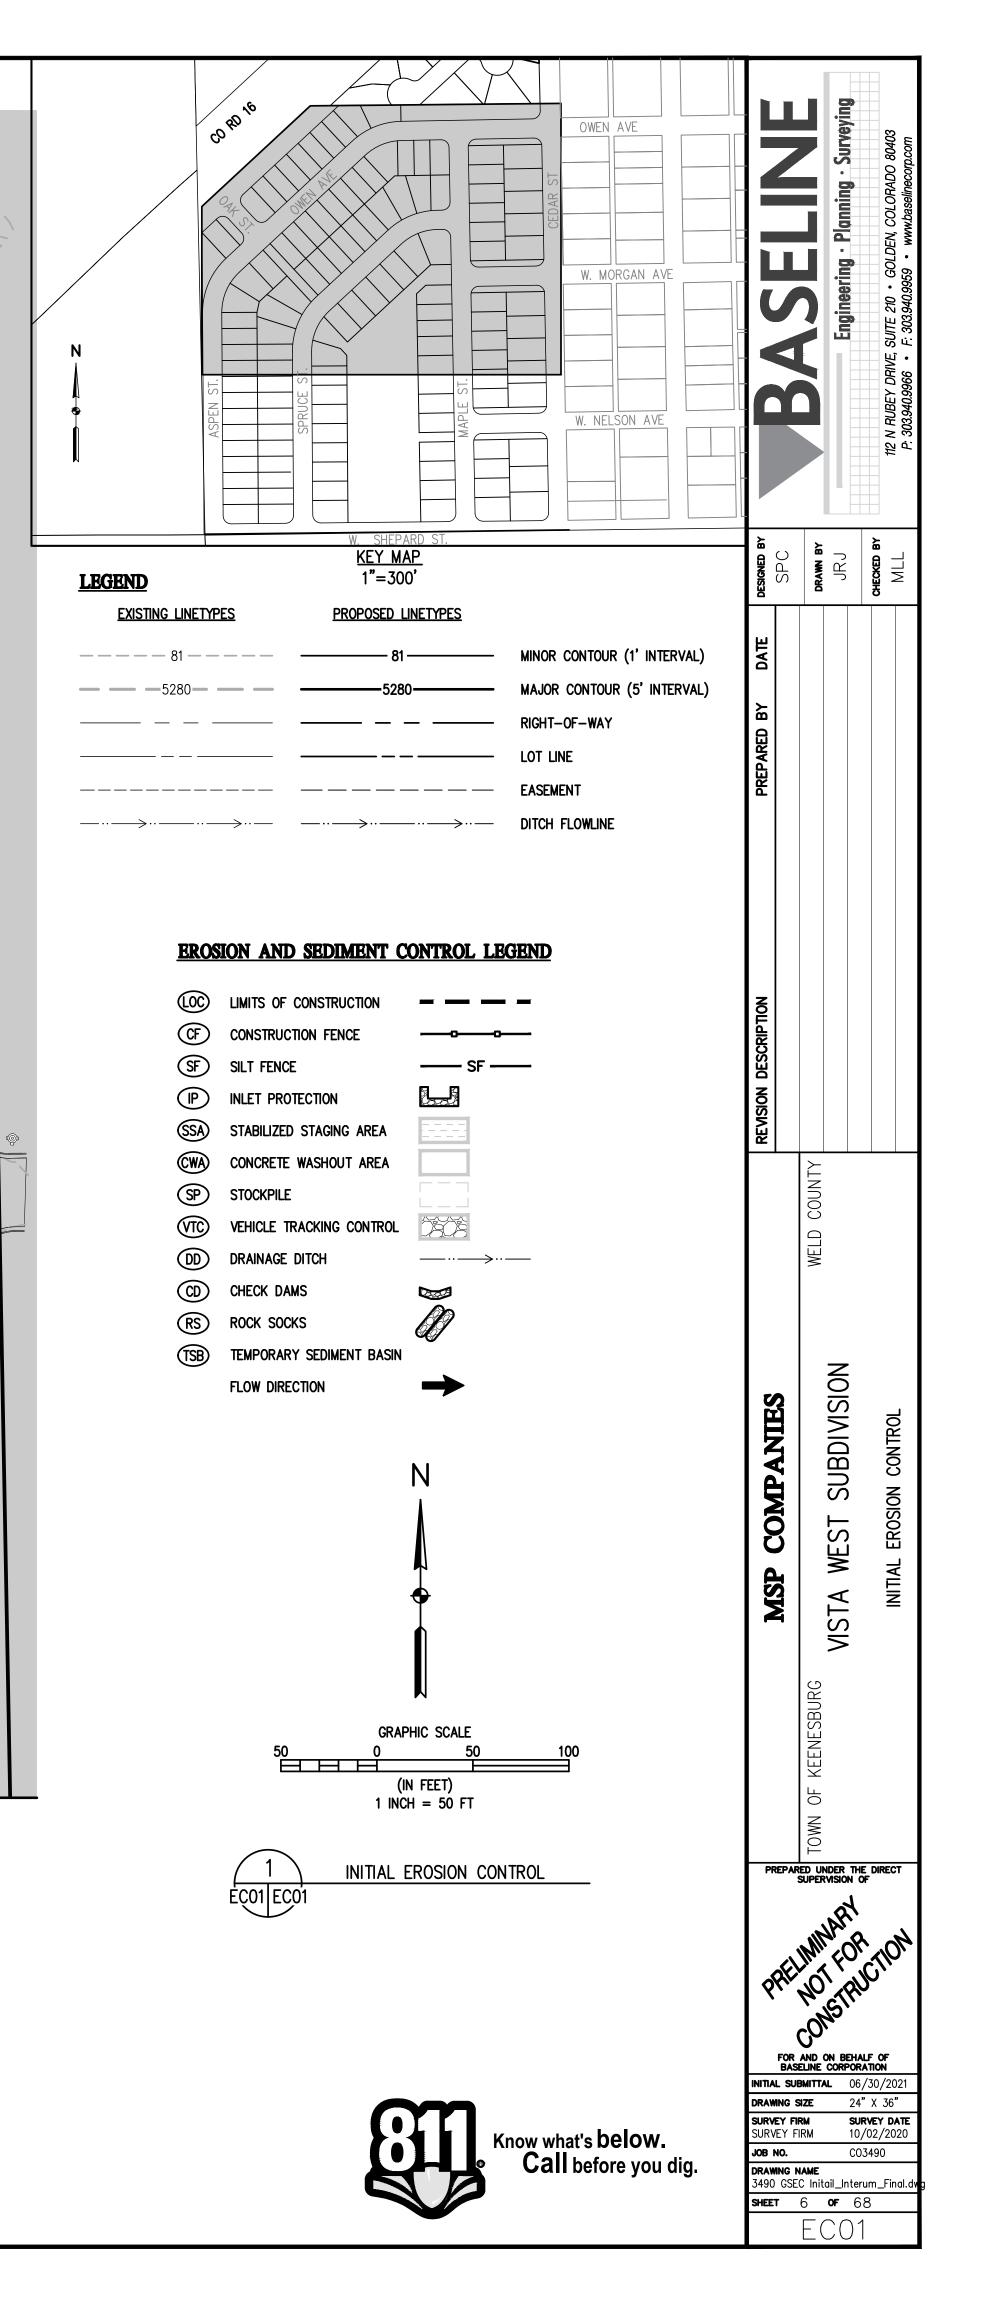
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CONSTRUCTION BOUNDARY

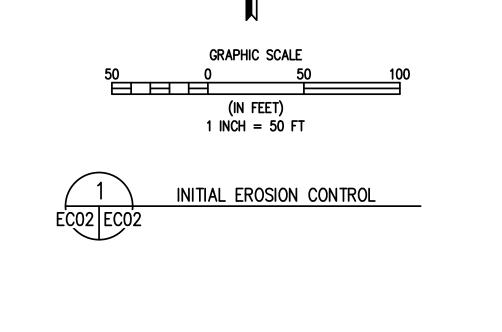

*──⋯* 



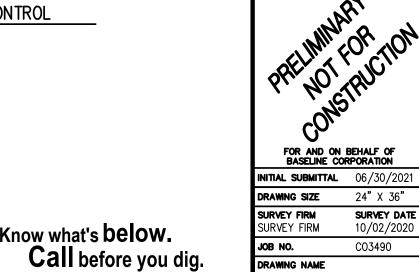

COMPANIES

MSP

SUBDIVISI

**VISTA** 

3490 GSEC Initail\_Interum\_Final.

SHEET 6 OF 68

OWEN AVE

W. MORGAN AVE

W. NELSON AVE

MINOR CONTOUR (1' INTERVAL)

MAJOR CONTOUR (5' INTERVAL)

KEY MAP 1"=300'

LIMITS OF CONSTRUCTION

CONSTRUCTION FENCE

SILT FENCE

STOCKPILE

CHECK DAMS

ROCK SOCKS

FLOW DIRECTION


TEMPORARY SEDIMENT BASIN


PROPOSED LINETYPES


**EXISTING LINETYPES** 

DD

(D)

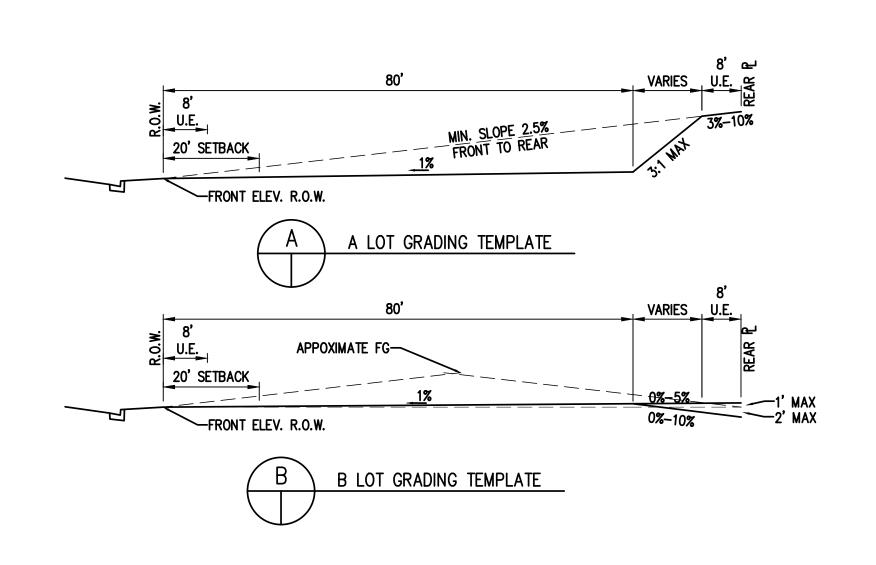

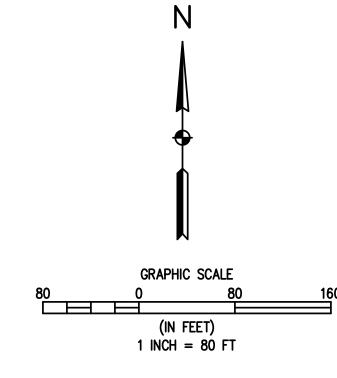

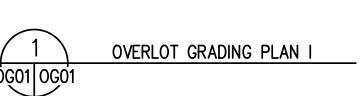

NOTES:

1. MAX SLOPE = 3:1
2. THESE PLANS DO NOT REFLECT STREET CORES.
3. SEE SHEETS EC01 — EC06 FOR EROSION CONTROL.



SUBDIVISION MSP COMPANIES **MSTA**  
 DRAWING SIZE
 24" X 36"

 SURVEY FIRM
 SURVEY DATE

 SURVEY FIRM
 10/02/2020
 SURVEY FIRM SURVEY FIRM JOB NO. C03490

DRAWING NAME
3490-GRADING.dwg

SHEET 12 OF 68 CO3490



5. ALL SPOT ELEVATIONS SHOWN ON THIS PLAN ARE FINISHED GRADE UNLESS NOTED OTHERWISE. 6. MAX SLOPE = 3:1

7. THESE PLANS DO NOT REFLECT STREET CORES.

APPROVAL IF ANY PORTION OF THE PROPOSED RETAINING WALL IS 48 INCHES OR GREATER (INCLUDING THE FOOTER). THE ENTIRE WALL MUST BE DESIGNED BY A PROFESSIONAL ENGINEER LICENSED IN THE STATE OF COLORADO AND SUBMITTED TO THE CITY FOR PRIOR TO CONSTRUCTION OF THE WALL.

3. TOE OF SLOPE (TOS) REFERS TO WHERE THE FINAL GRADE INTERSECTS WITH THE WALL. THIS ELEVATION DOES NOT REPRESENT THE BOTTOM COURSE OF BLOCKS OR FOOTER.

4. TOP OF WALL (TW).

Know what's below. Call before you dig.

SUBDIVISION

**VISTA** 

INITIAL SUBMITTAL 06/30/20

DRAWNG SIZE 24" X 36"

SHEET 13 OF 68

GR01

SURVEY FIRM SURVEY FIRM

DRAWING NAME 3490-GRADING.dwg

JOB NO.

SURVEY DATE 10/02/2020

CO3490

COMPANIES


MSP

OWEN AVE


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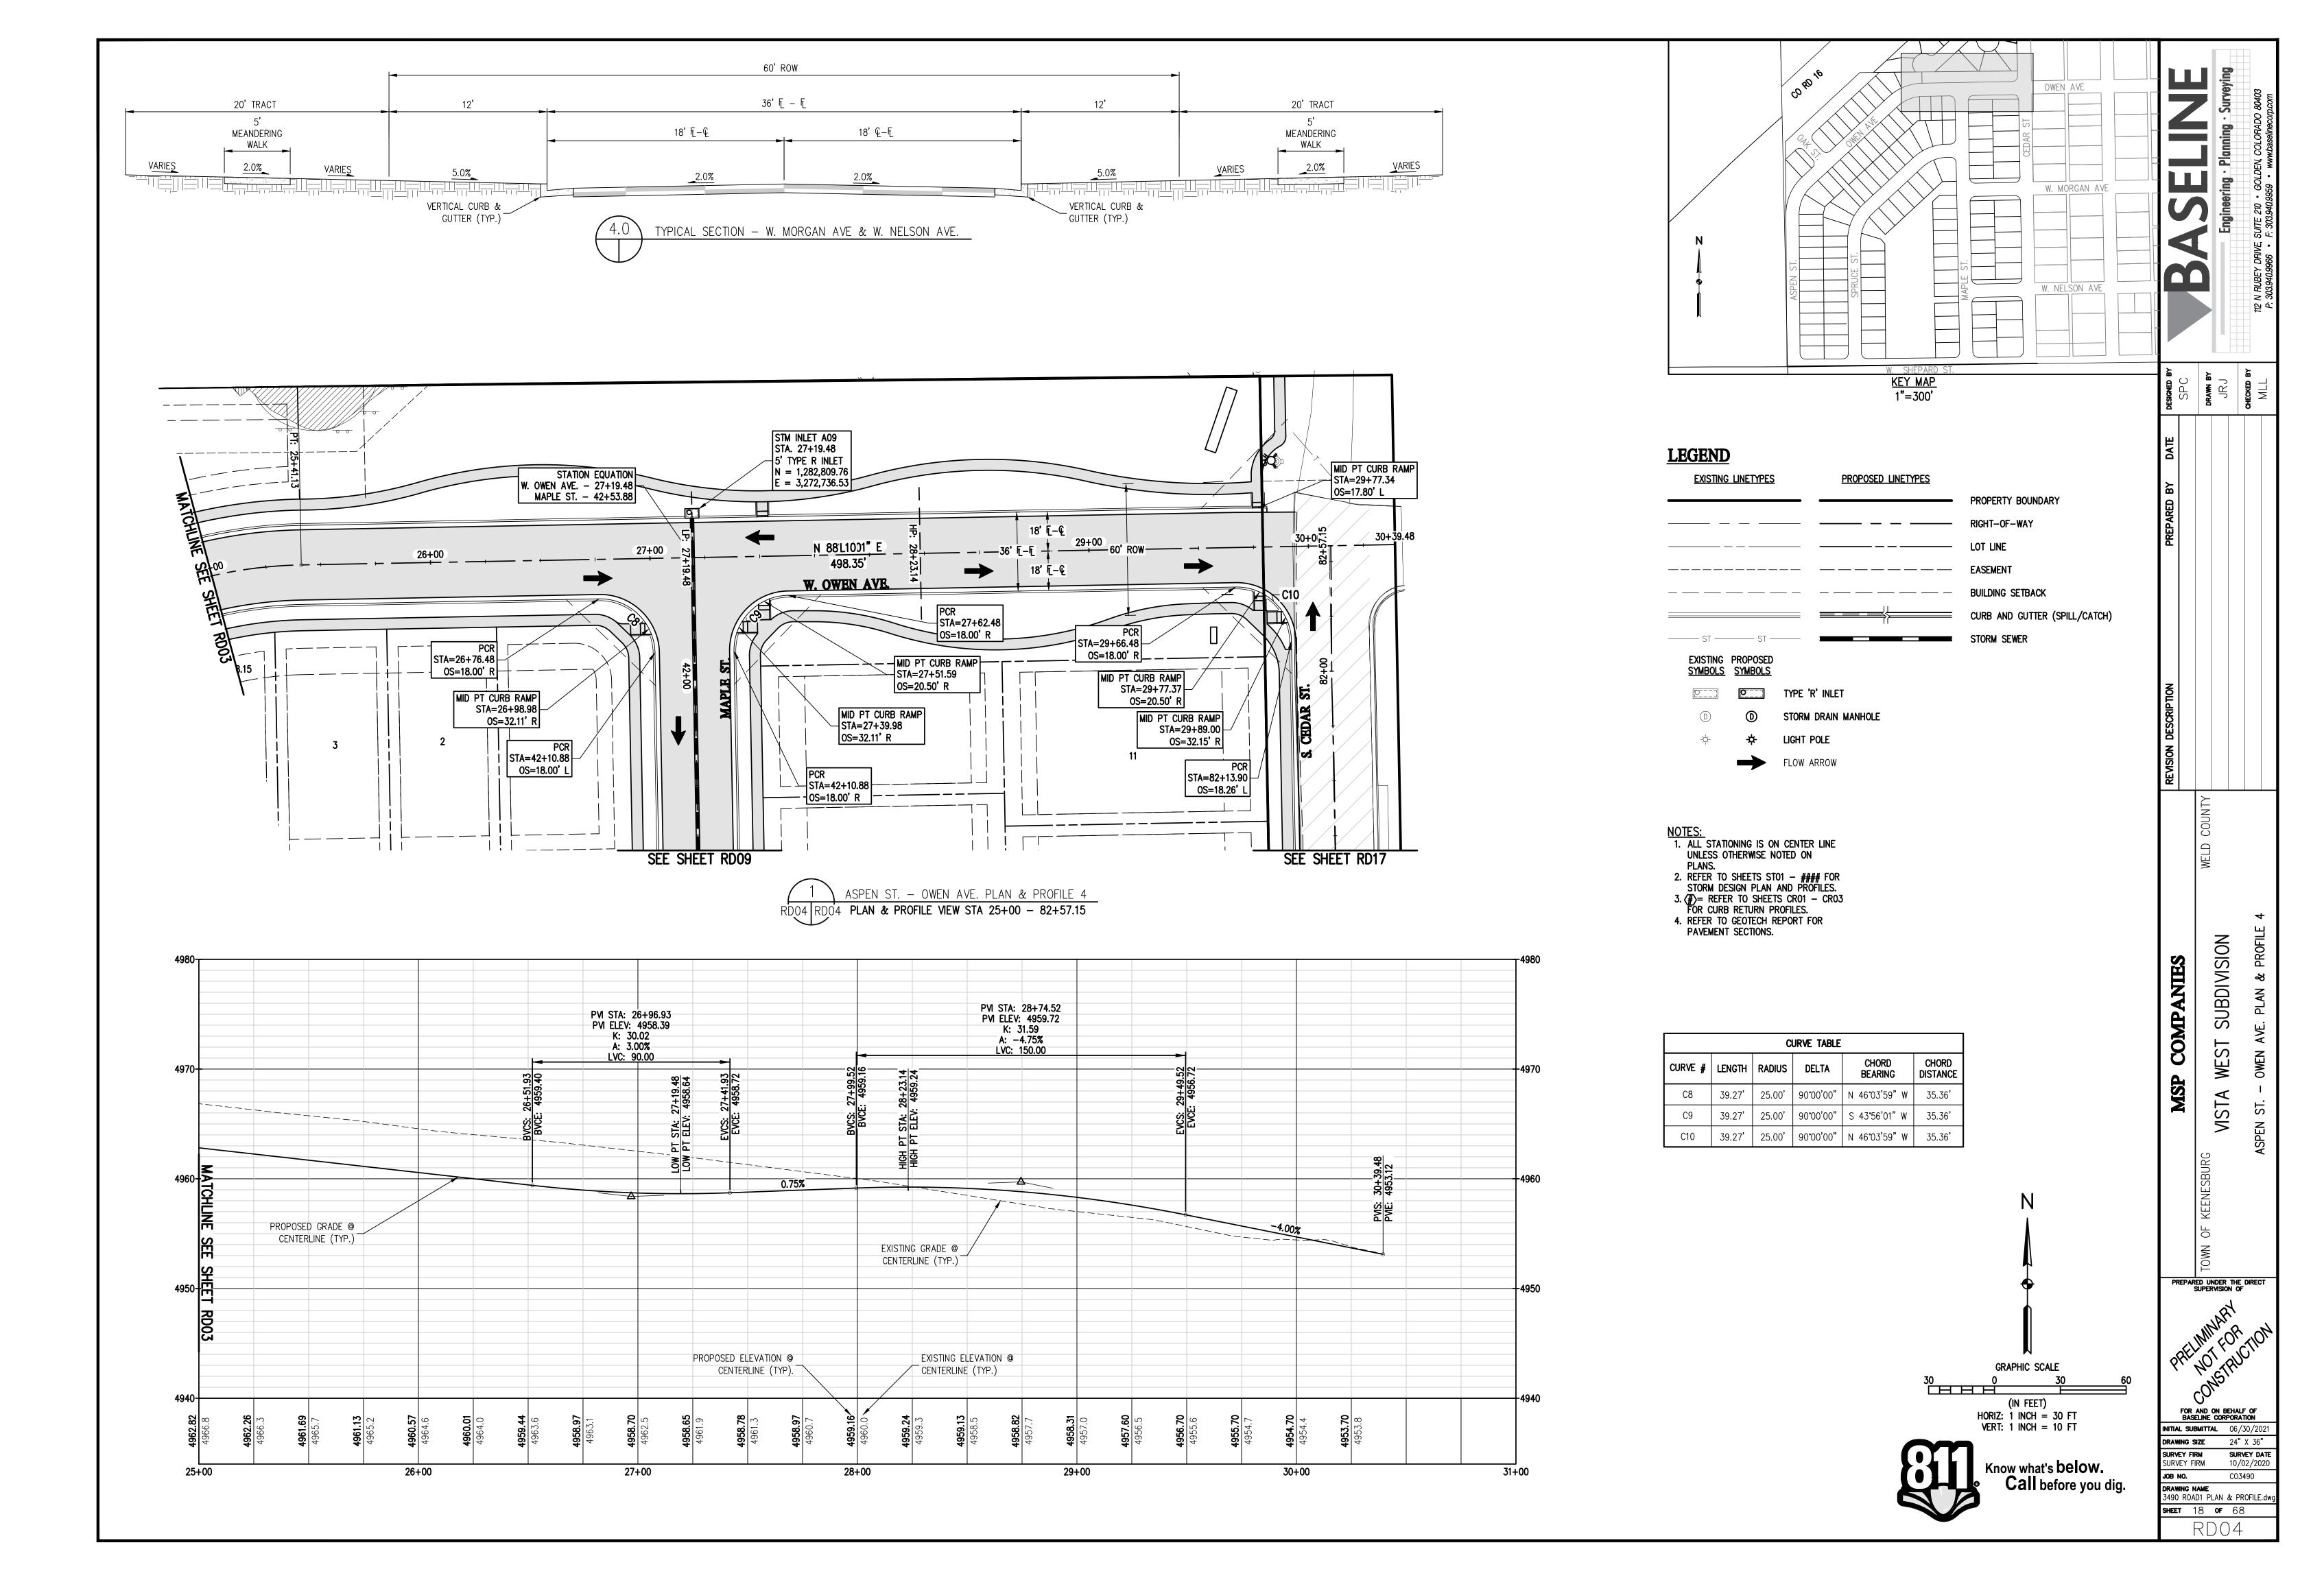
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**SHEET** 14 **OF** 68



RD01

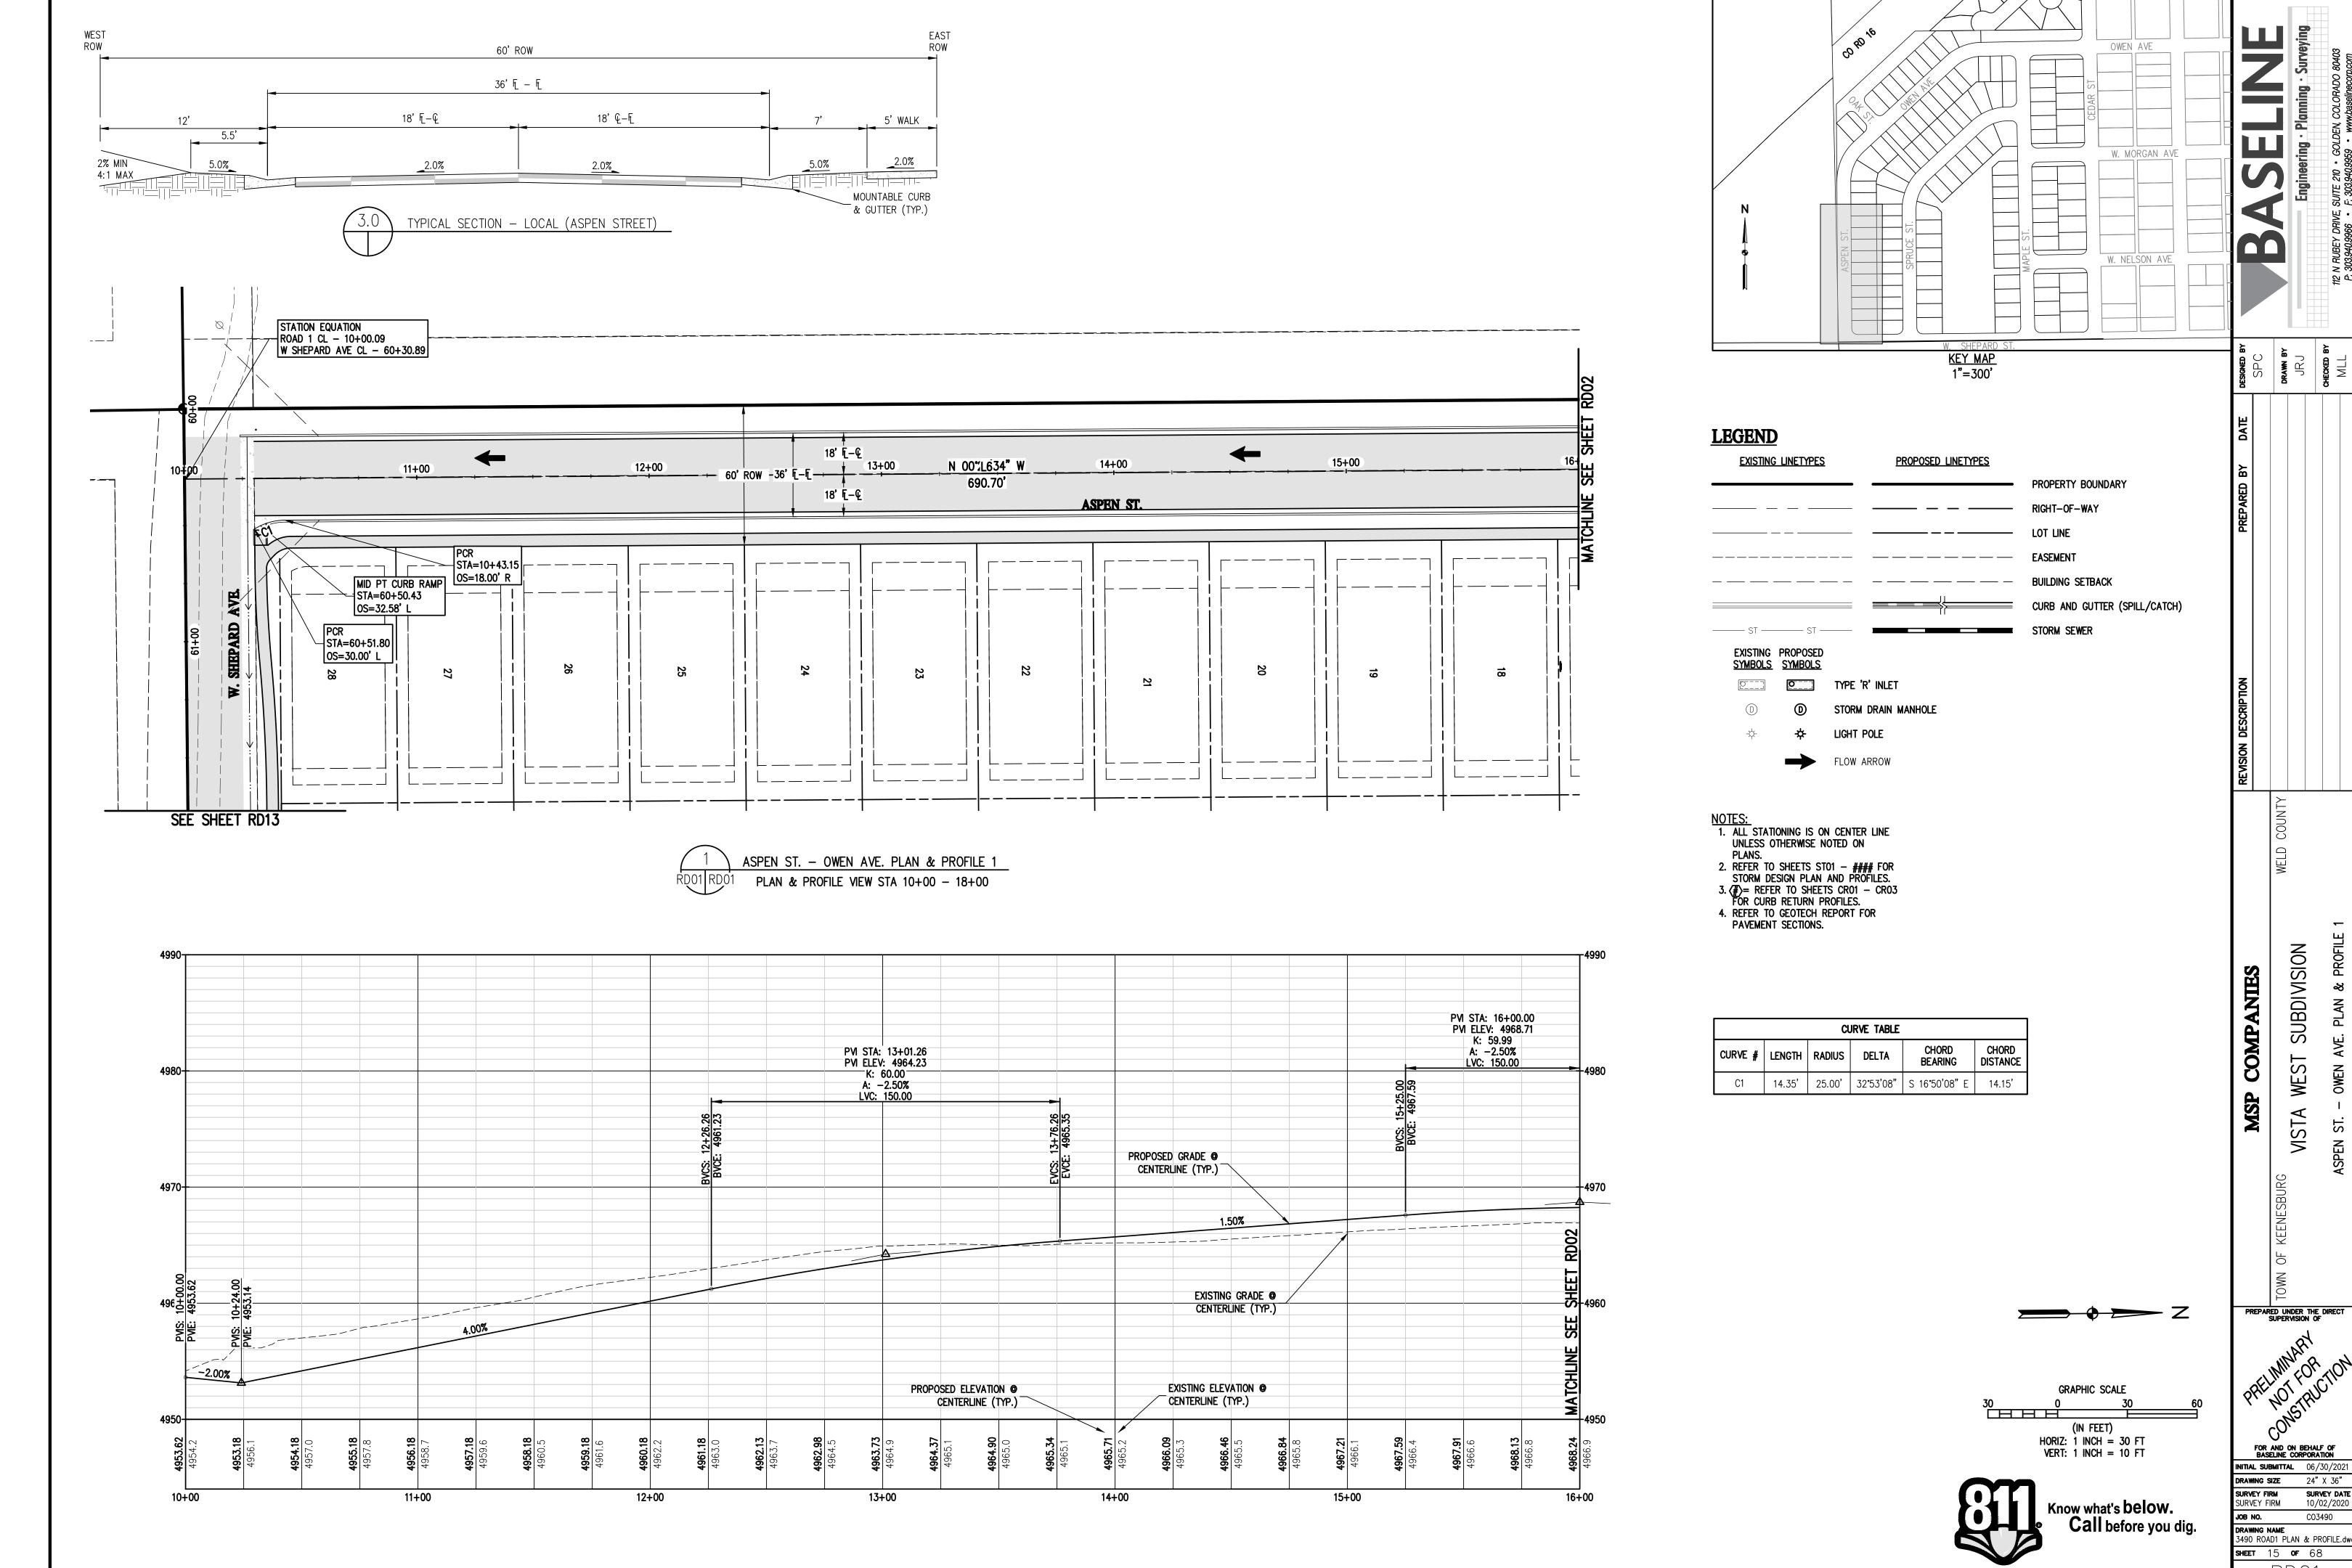


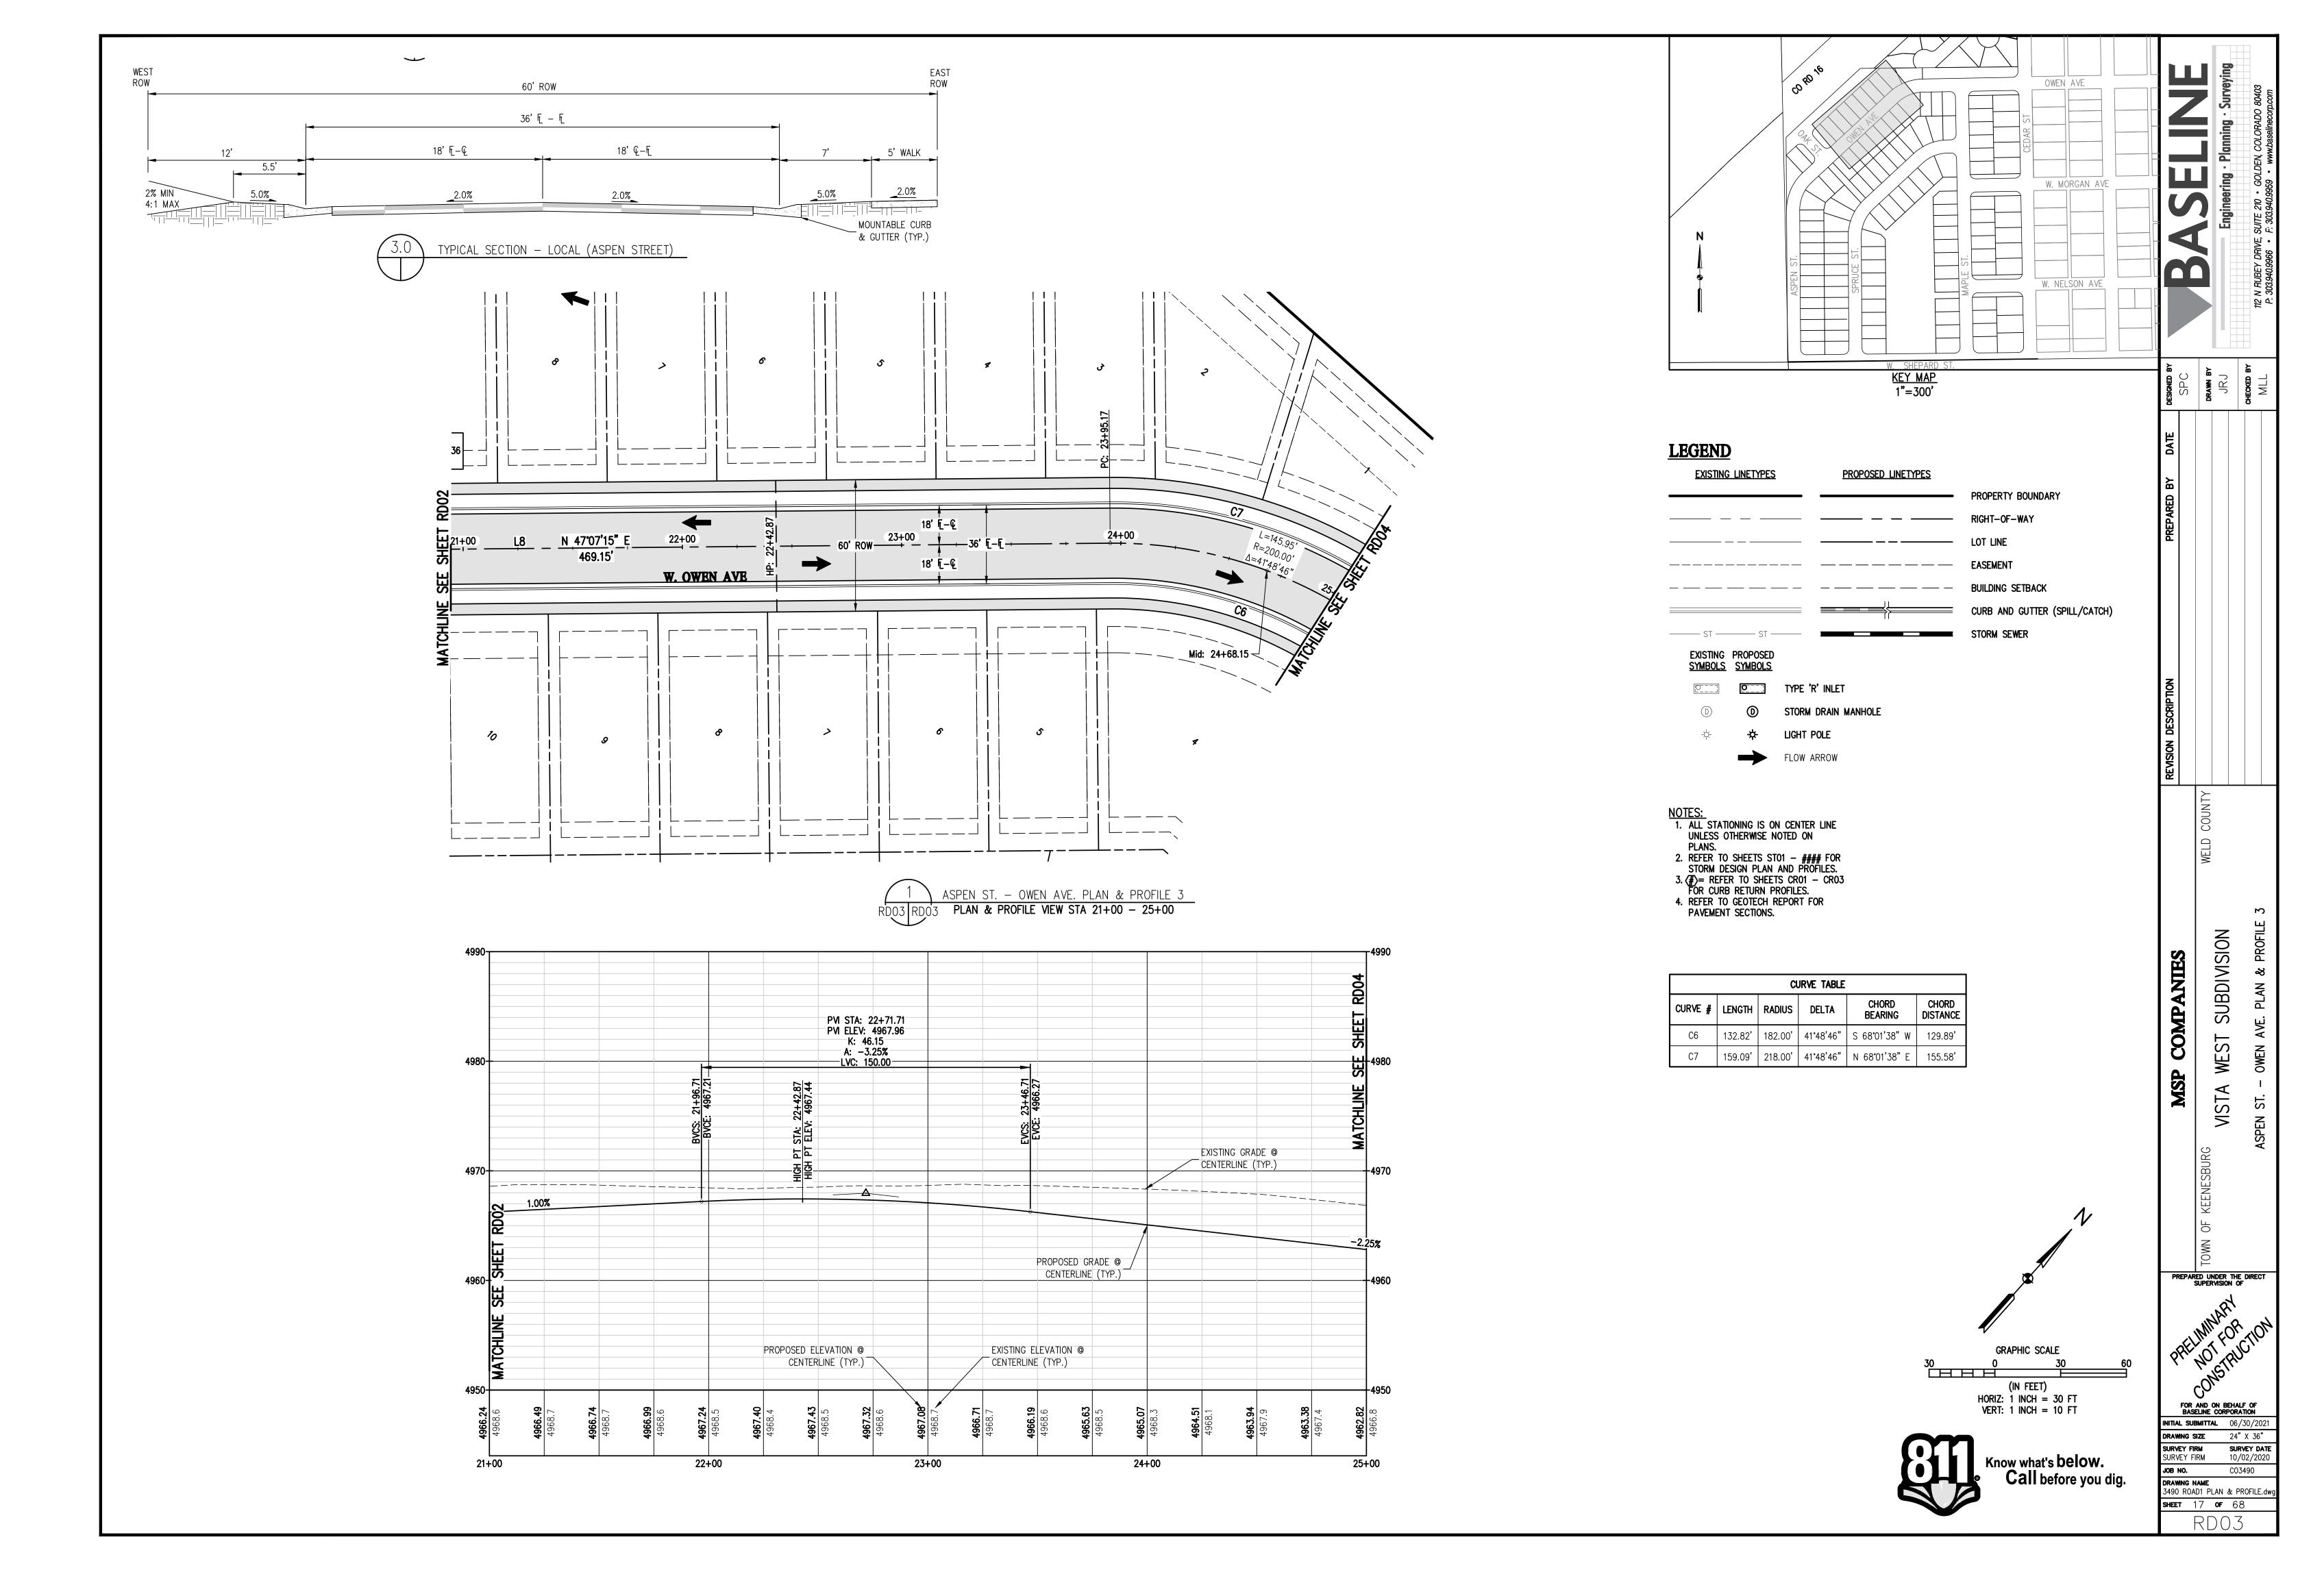

RD08


60'ROW


36' E – E

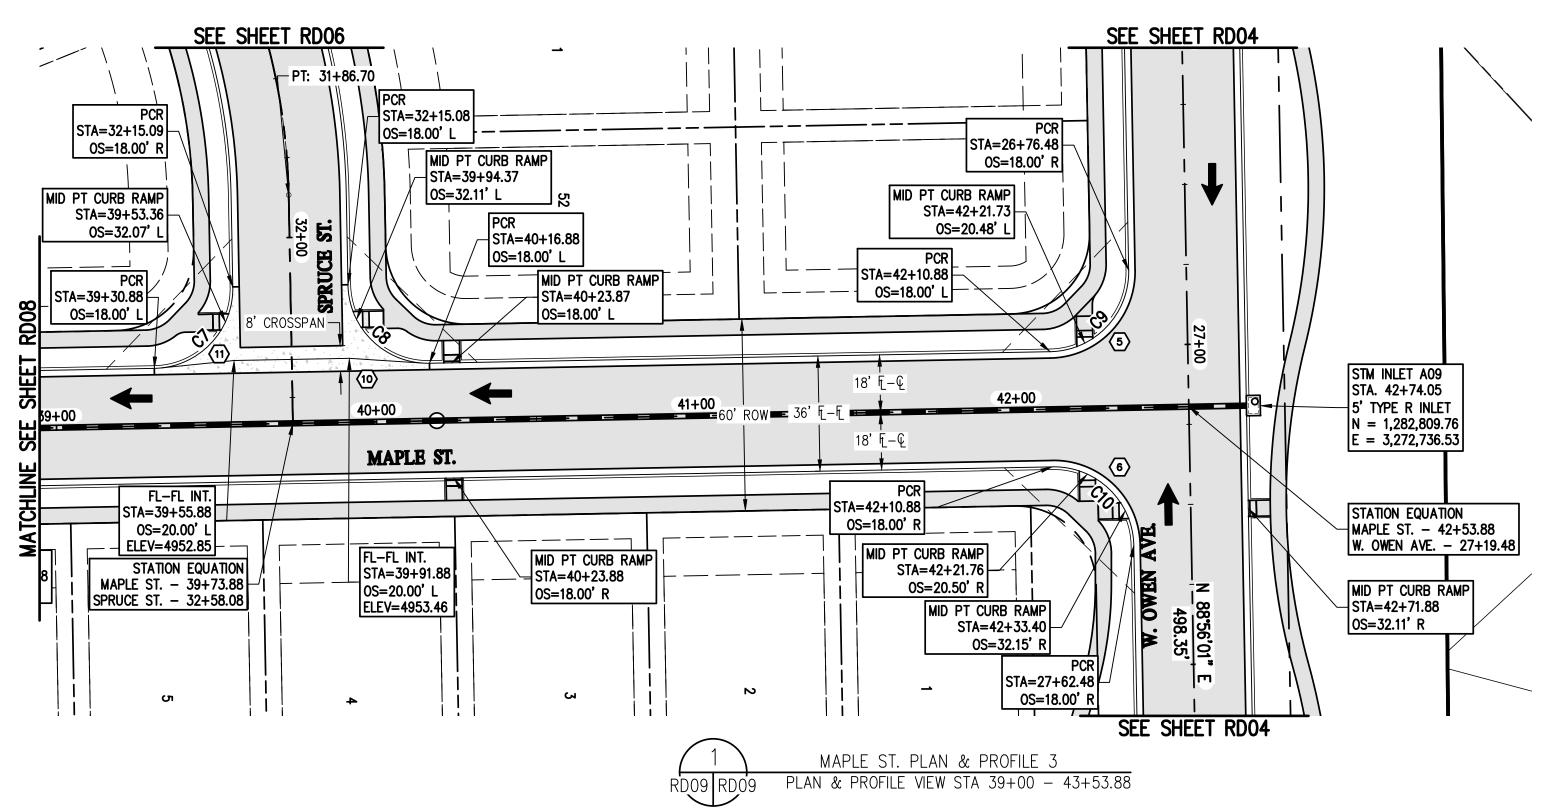

5' WALK

MOUNTABLE CURB & GUTTER (TYP.)

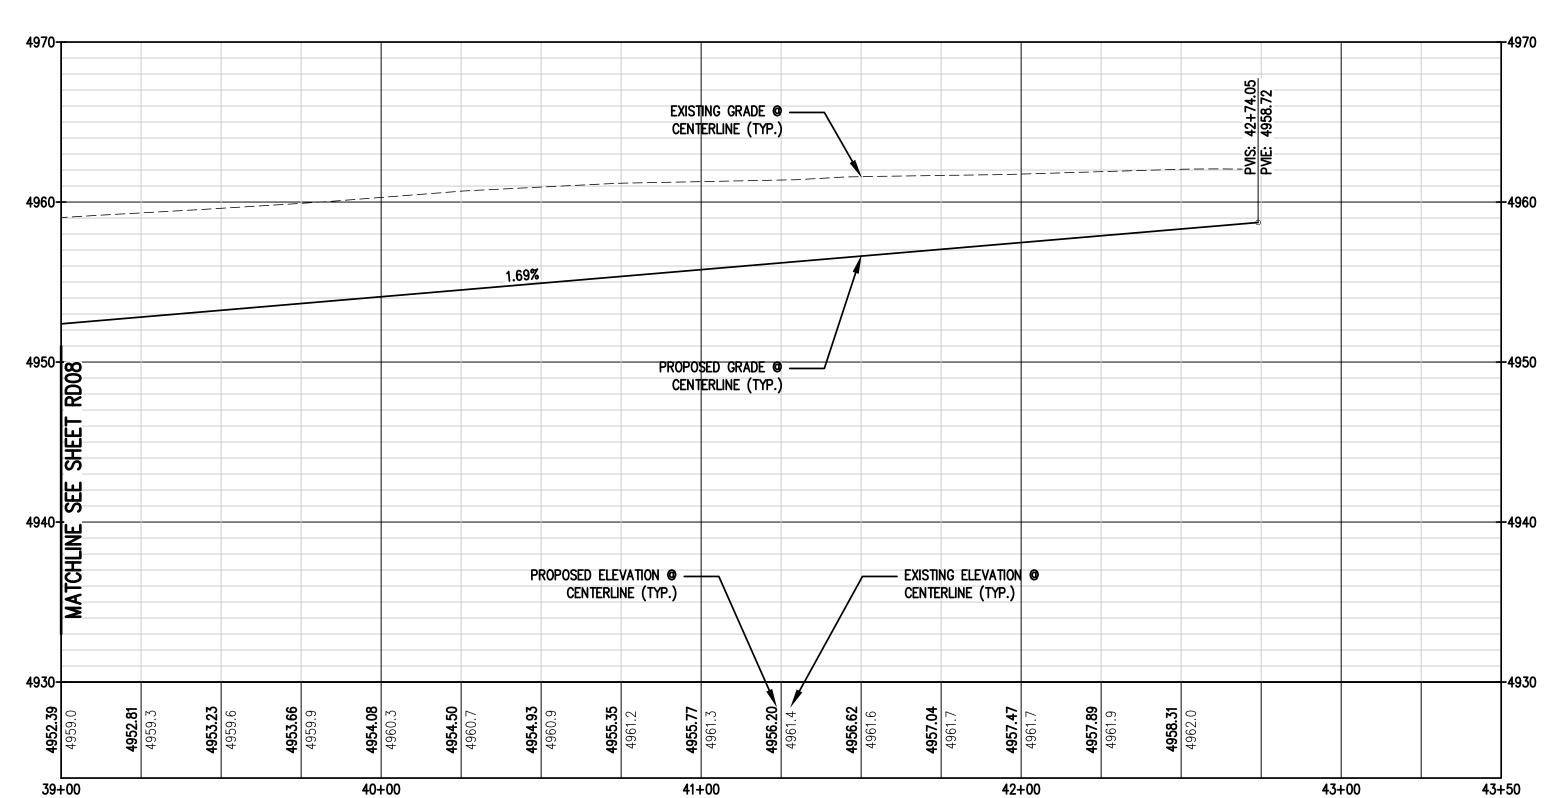

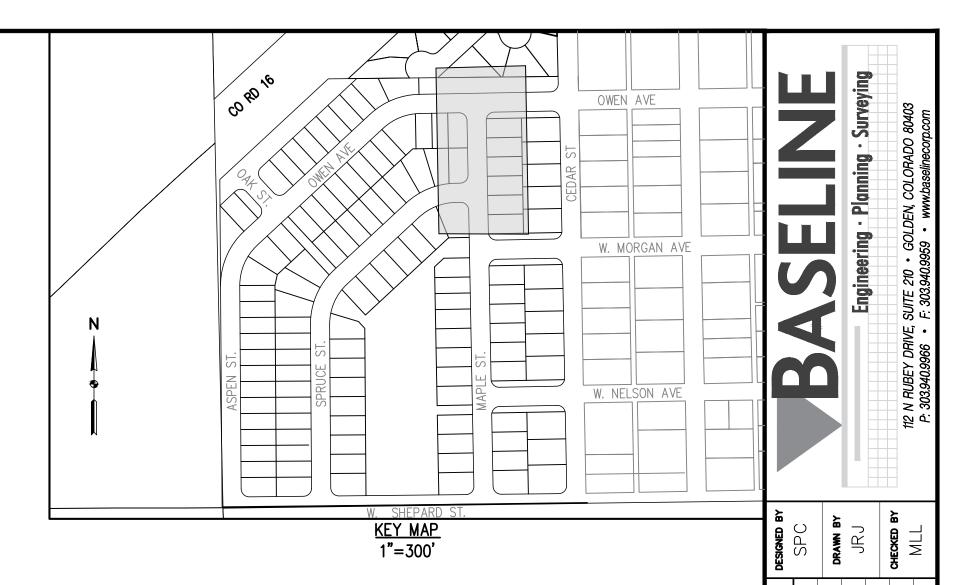

## **LEGEND**

<b>EXISTING LINETYPES</b>	PROPOSED LINETYPES	
		PROPERTY BOUNDARY
		RIGHT-OF-WAY
		LOT LINE
		EASEMENT
		BUILDING SETBACK
		CURB AND GUTTER (SPILL/CATCH)
ST ST		STORM SEWER

#### EXISTING PROPOSED SYMBOLS SYMBOLS

TYPE 'R' INLET

STORM DRAIN MANHOLE

LIGHT POLE

FLOW ARROW

NOTES:


1. ALL STATIONING IS ON CENTER LINE UNLESS OTHERWISE NOTED ON PLANS.

2. REFER TO SHEETS ST01 — #### FOR STORM DESIGN PLAN AND PROFILES.

3. # = REFER TO SHEETS CR01 — CR03 FOR CURB RETURN PROFILES.

4. REFER TO GEOTECH REPORT FOR PAVEMENT SECTIONS.

	CURVE TABLE					
CURVE #	LENGTH	RADIUS	DELTA	CHORD BEARING	CHORD DISTANCE	
C7	39.27	25.00'	90°00'00"	S 46°03'59" E	35.36'	
C8	39.27	25.00'	90°00'00"	N 43°56'01" E	35.36'	
С9	39.27	25.00'	90°00'00"	N 46°03'59" W	35.36'	
C10	39.27	25.00'	90°00'00"	S 43°56'01" W	35.36'	

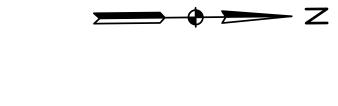

SUBDIVISION

WEST

**VISTA** 

FOR AND ON BEHALF OF BASELINE CORPORATION

INITIAL SUBMITTAL 06/30/202

DRAWING SIZE 24" X 36"

SURVEY FIRM SURVEY DATE 10/02/2020

JOB NO. CO3490

DRAWING NAME
3490 ROAD3 PLAN & PROFILE.dw

RD09

**SHEET** 23 **OF** 68

MSP COMPANIES

GRAPHIC SCALE (IN FEET) HORIZ: 1 INCH = 30 FT VERT: 1 INCH = 10 FT



SUBDIVISION


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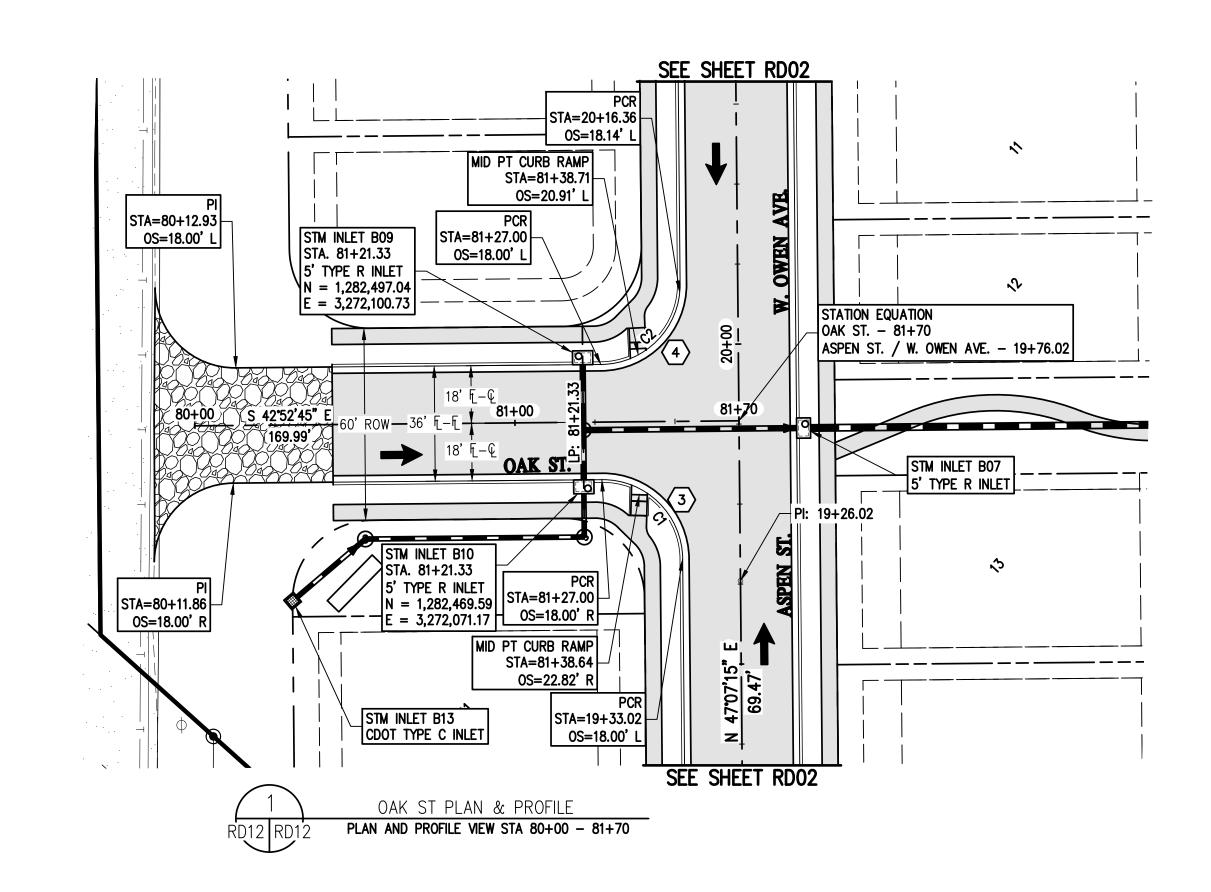
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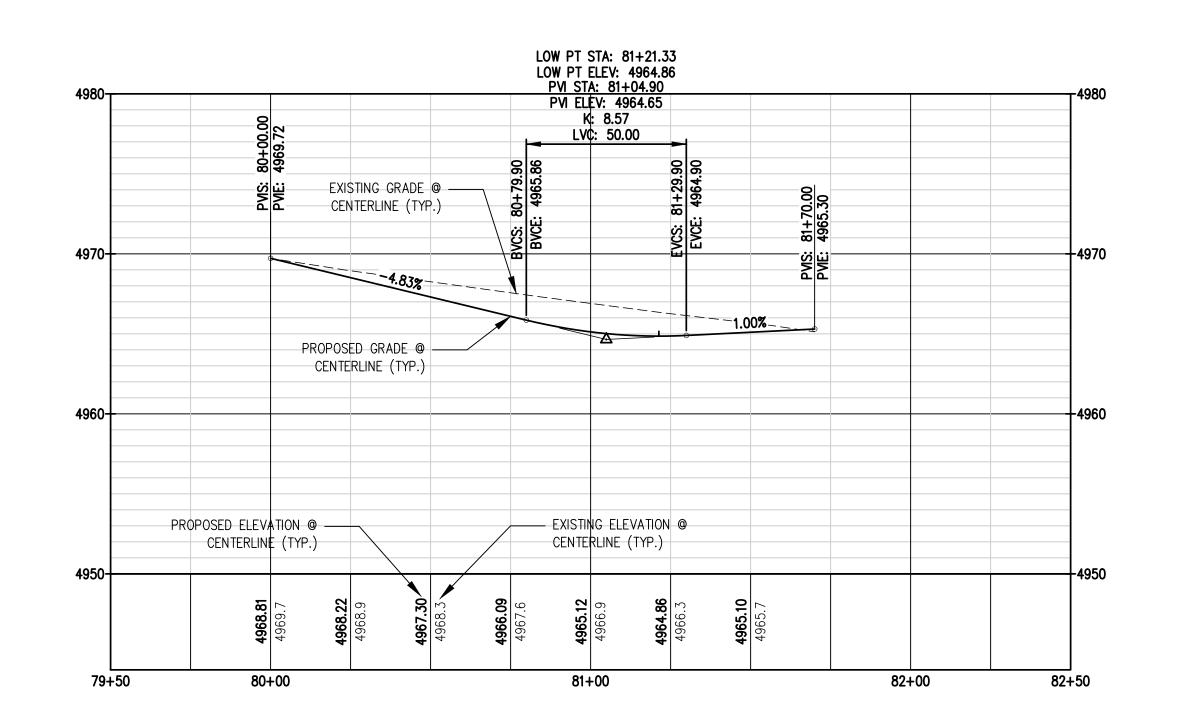
CO3490


RD10

60'ROW





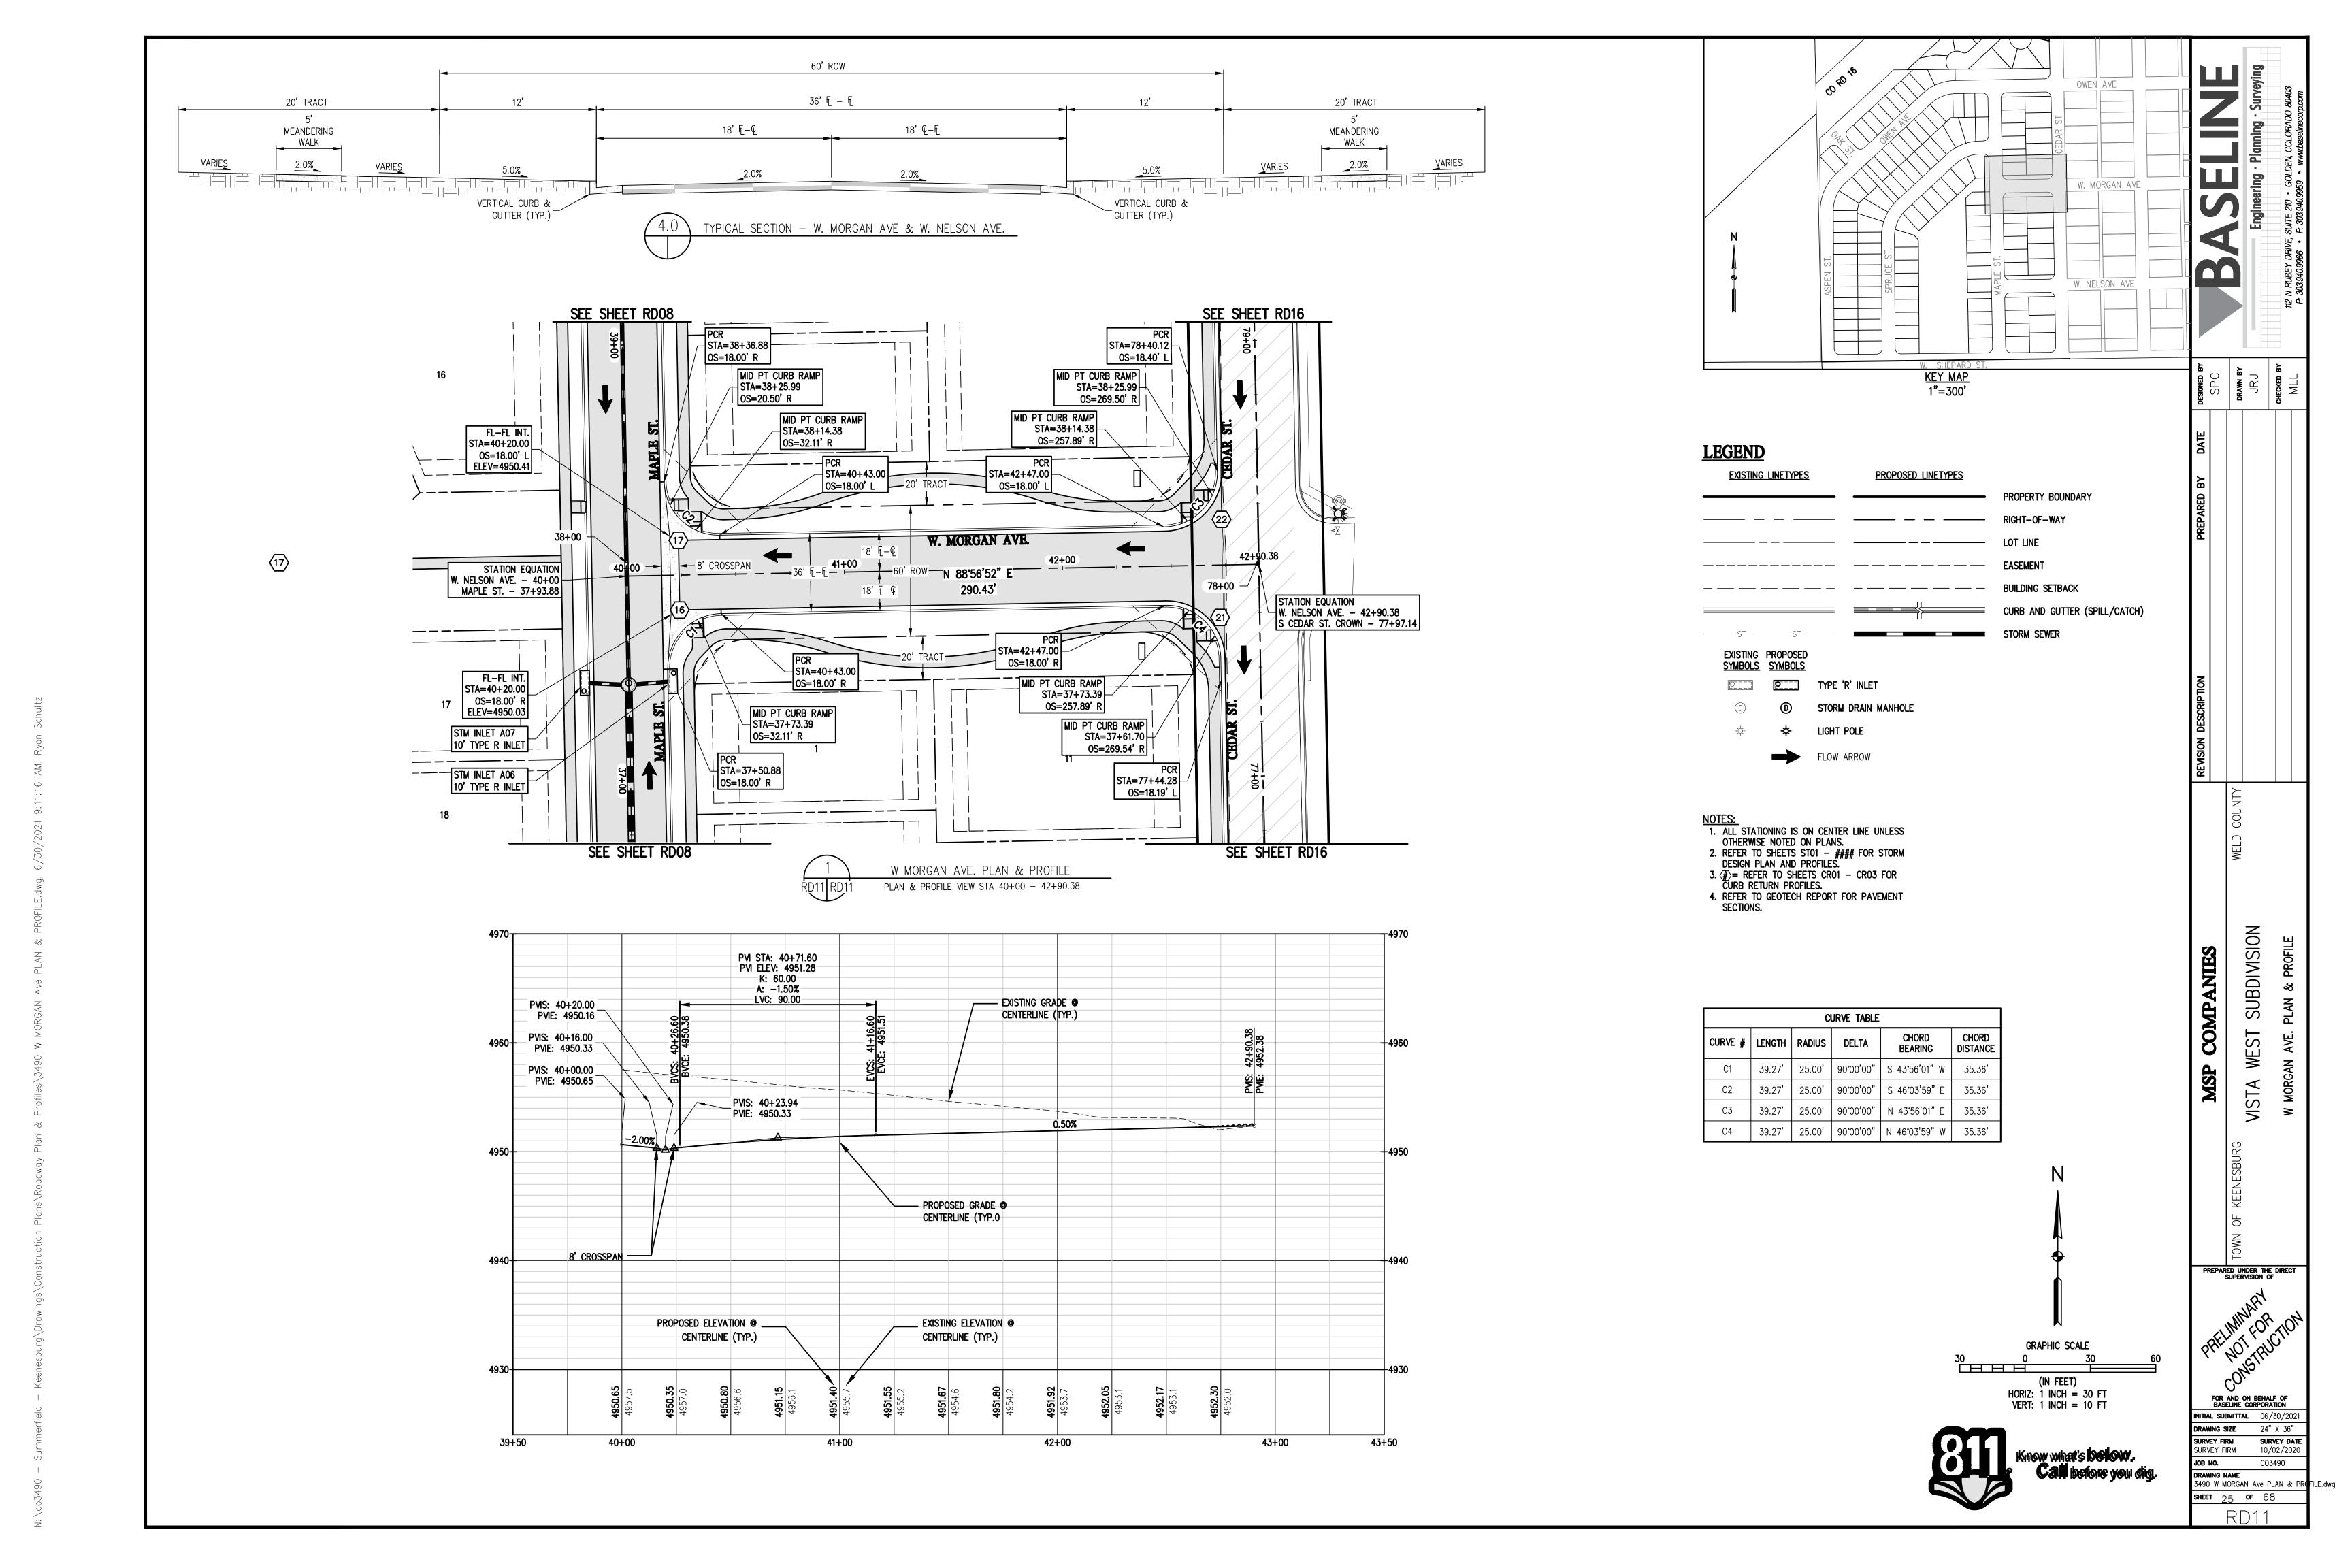

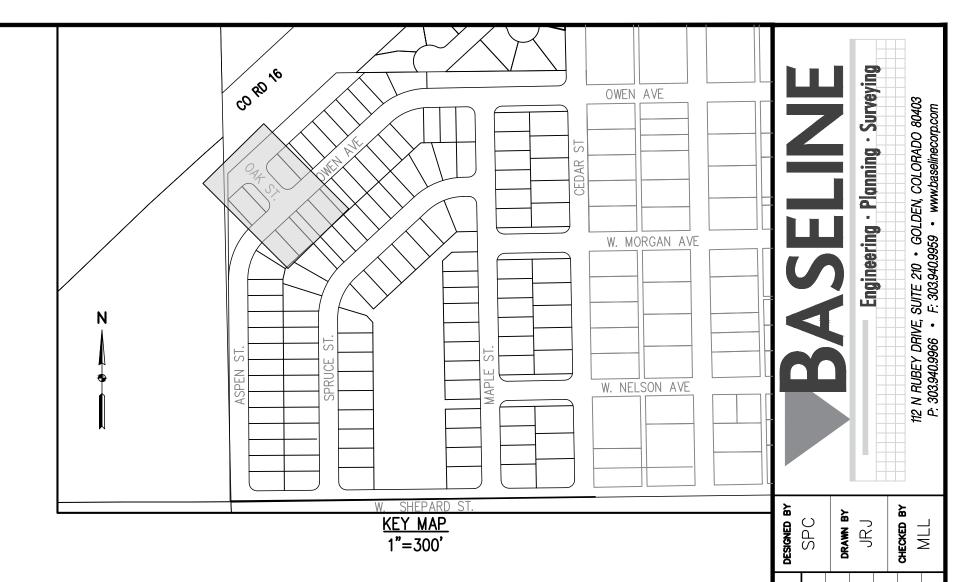

## **LEGEND**

<b>EXISTING LINETYPES</b>	PROPOSED LINETYPES	
		PROPERTY BOUNDARY
		RIGHT-OF-WAY
		LOT LINE
		EASEMENT
		BUILDING SETBACK
		CURB AND GUTTER (SPILL/CATCH)
ST ST		STORM SEWER

# EXISTING PROPOSED SYMBOLS SYMBOLS

	0	TYPE 'R' INLET		
(D)	<b>(D)</b>	STORM DRAIN MANHOL		
-\\(\phi\)-	*	LIGHT POLE		
	$\rightarrow$	FLOW ARROW		
		GRAVEL PAVING		

- NOTES:


  1. ALL STATIONING IS ON CENTER LINE UNLESS OTHERWISE NOTED ON PLANS.

  2. REFER TO SHEETS ST01 #### FOR STORM DESIGN PLAN AND PROFILES.

  3. (#)= REFER TO SHEETS CR01 CR03 FOR CURB RETURN PROFILES.

  4. REFER TO GEOTECH REPORT FOR PAVEMENT SECTIONS.

CURVE TABLE					
CURVE #	LENGTH	RADIUS	DELTA	CHORD BEARING	CHORD DISTANCE
C1	39.27	25.00'	90°00'00"	N 02°07'15" E	35.36'
C2	39.27	25.00'	90°00'00"	S 87°52'45" E	35.36'

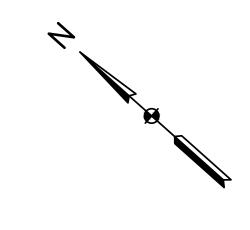

SUBDIVISION

WEST

**MSTA** 

FOR AND ON BEHALF OF BASELINE CORPORATION

INITIAL SUBMITTAL 06/30/202

DRAWNG SIZE 24" X 36" SURVEY FIRM SURVEY DATE SURVEY FIRM 10/02/2020

JOB NO. CO3490

DRAWING NAME
OAK ST PLAN & PROFILE.dwg


SHEET 26 OF 68


RD12


MSP COMPANIES


GRAPHIC SCALE (IN FEET) HORIZ: 1 INCH = 30 FT VERT: 1 INCH = 10 FT




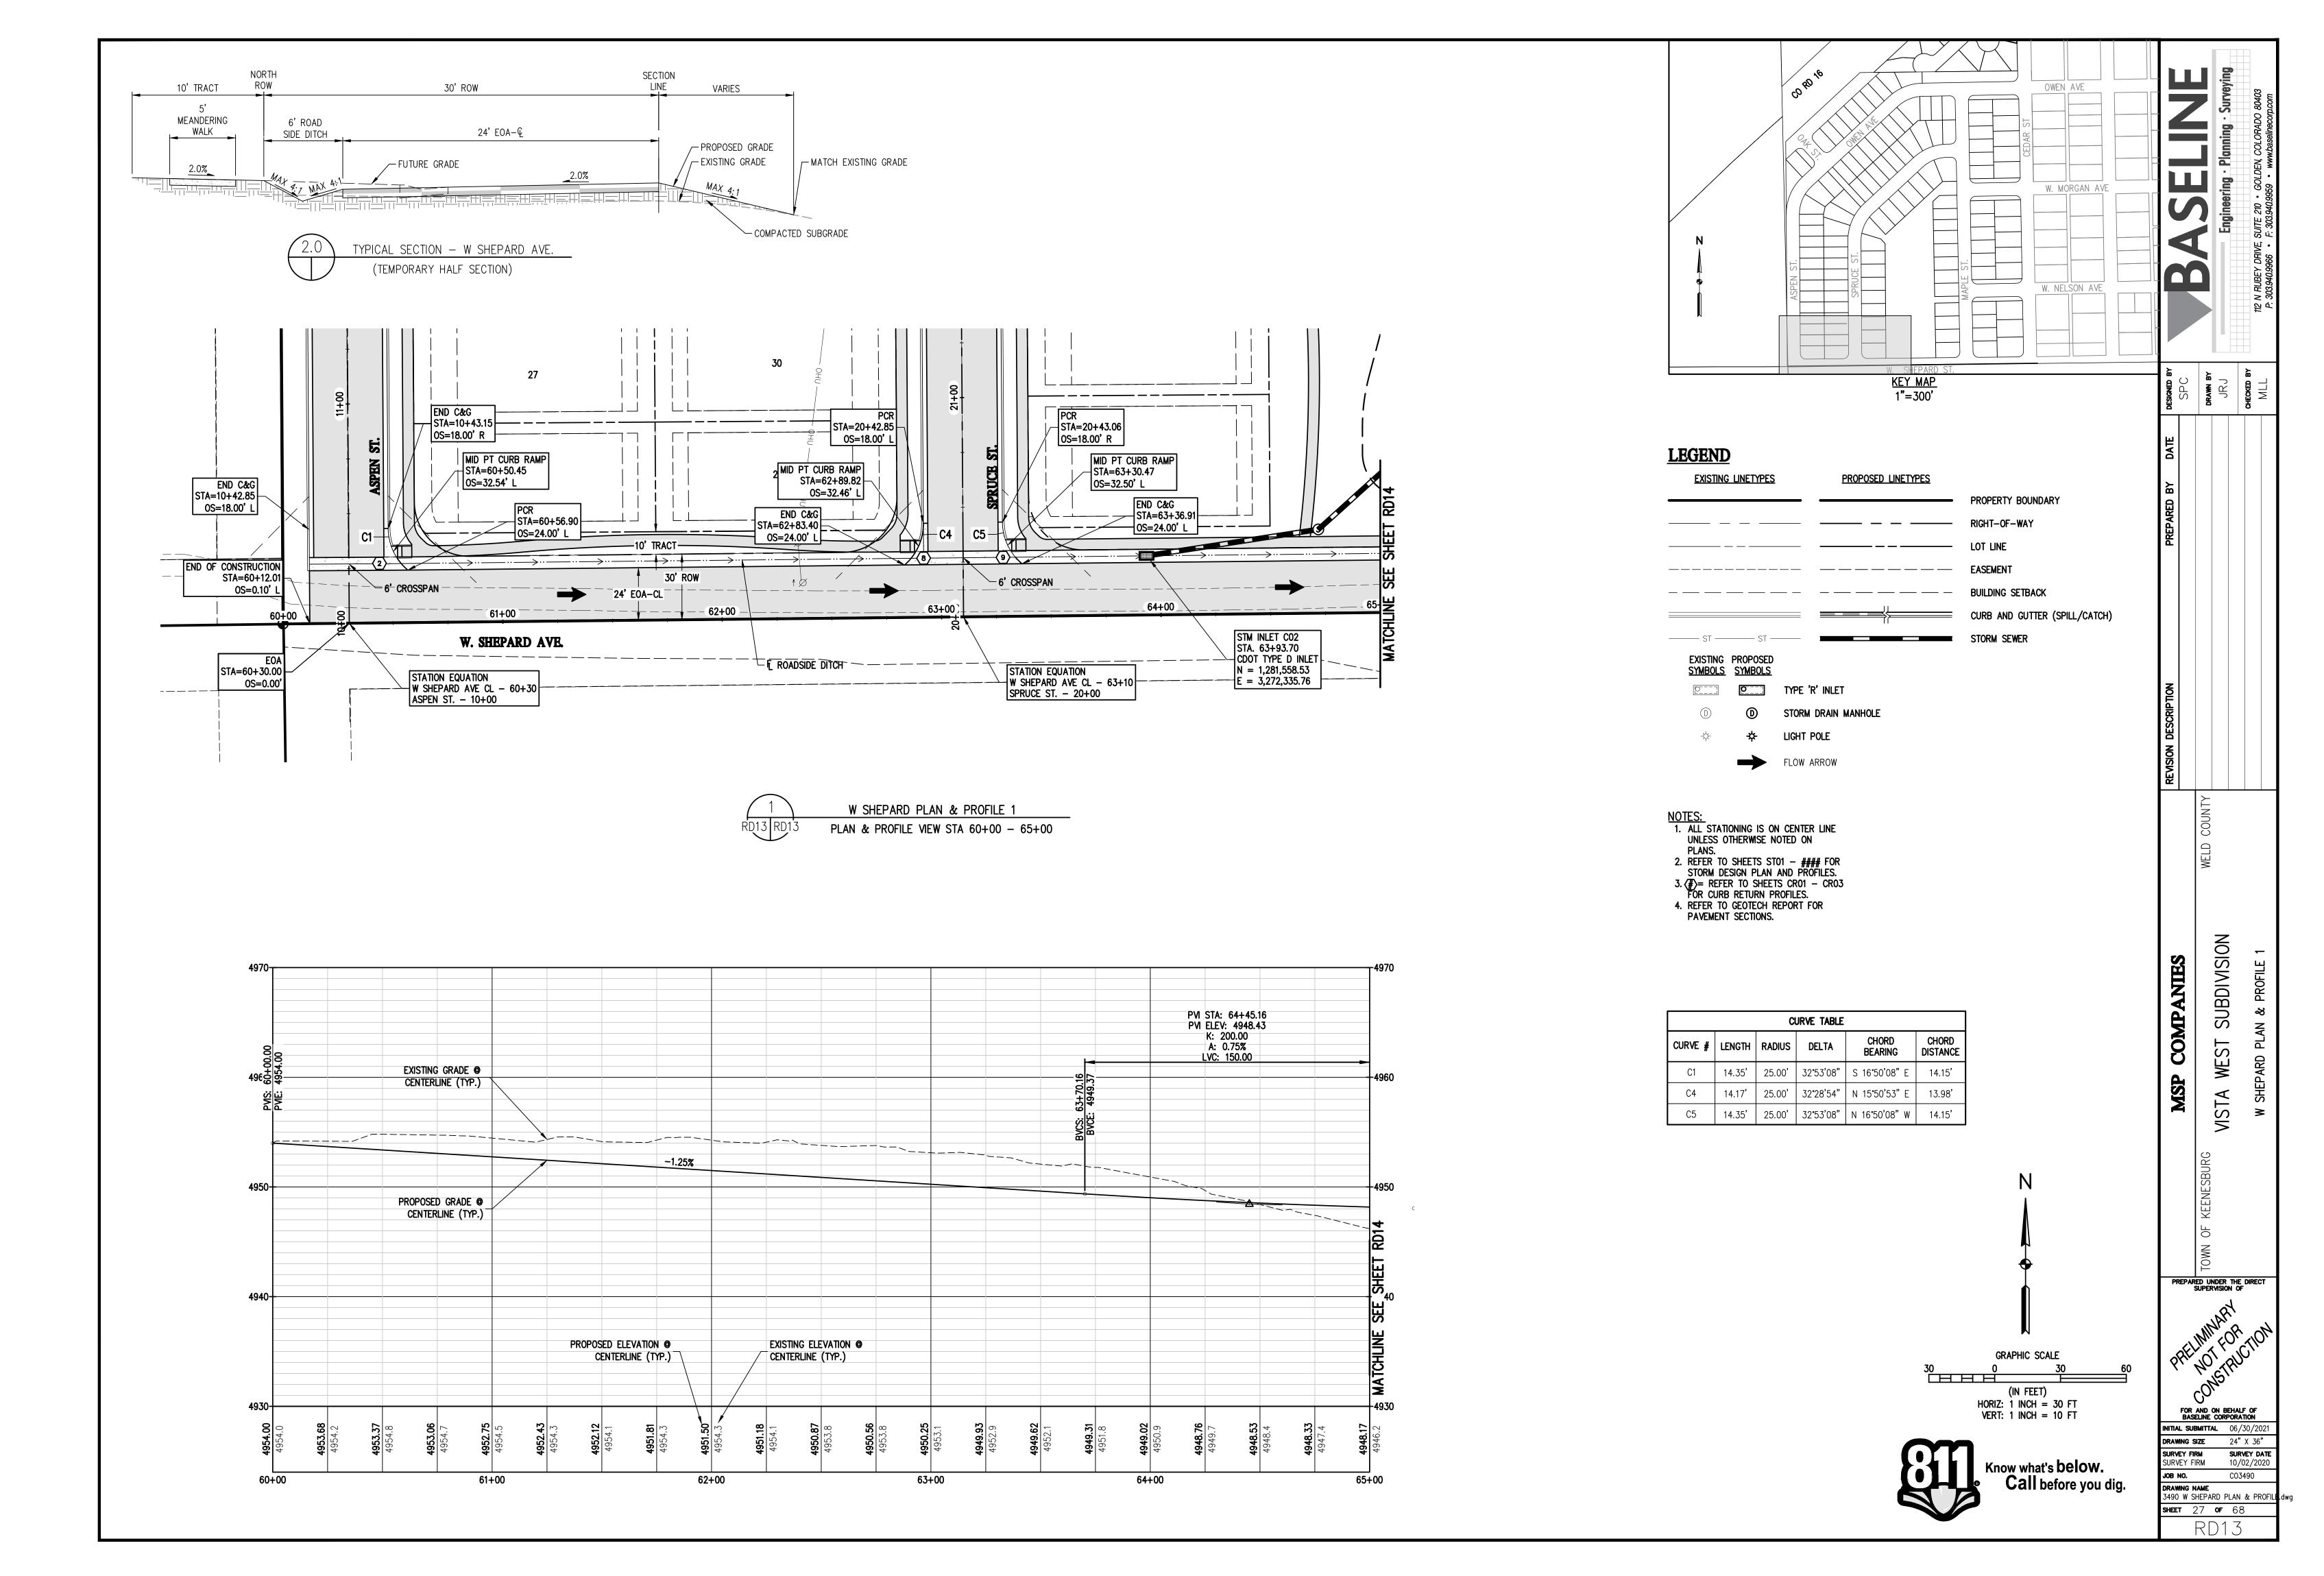

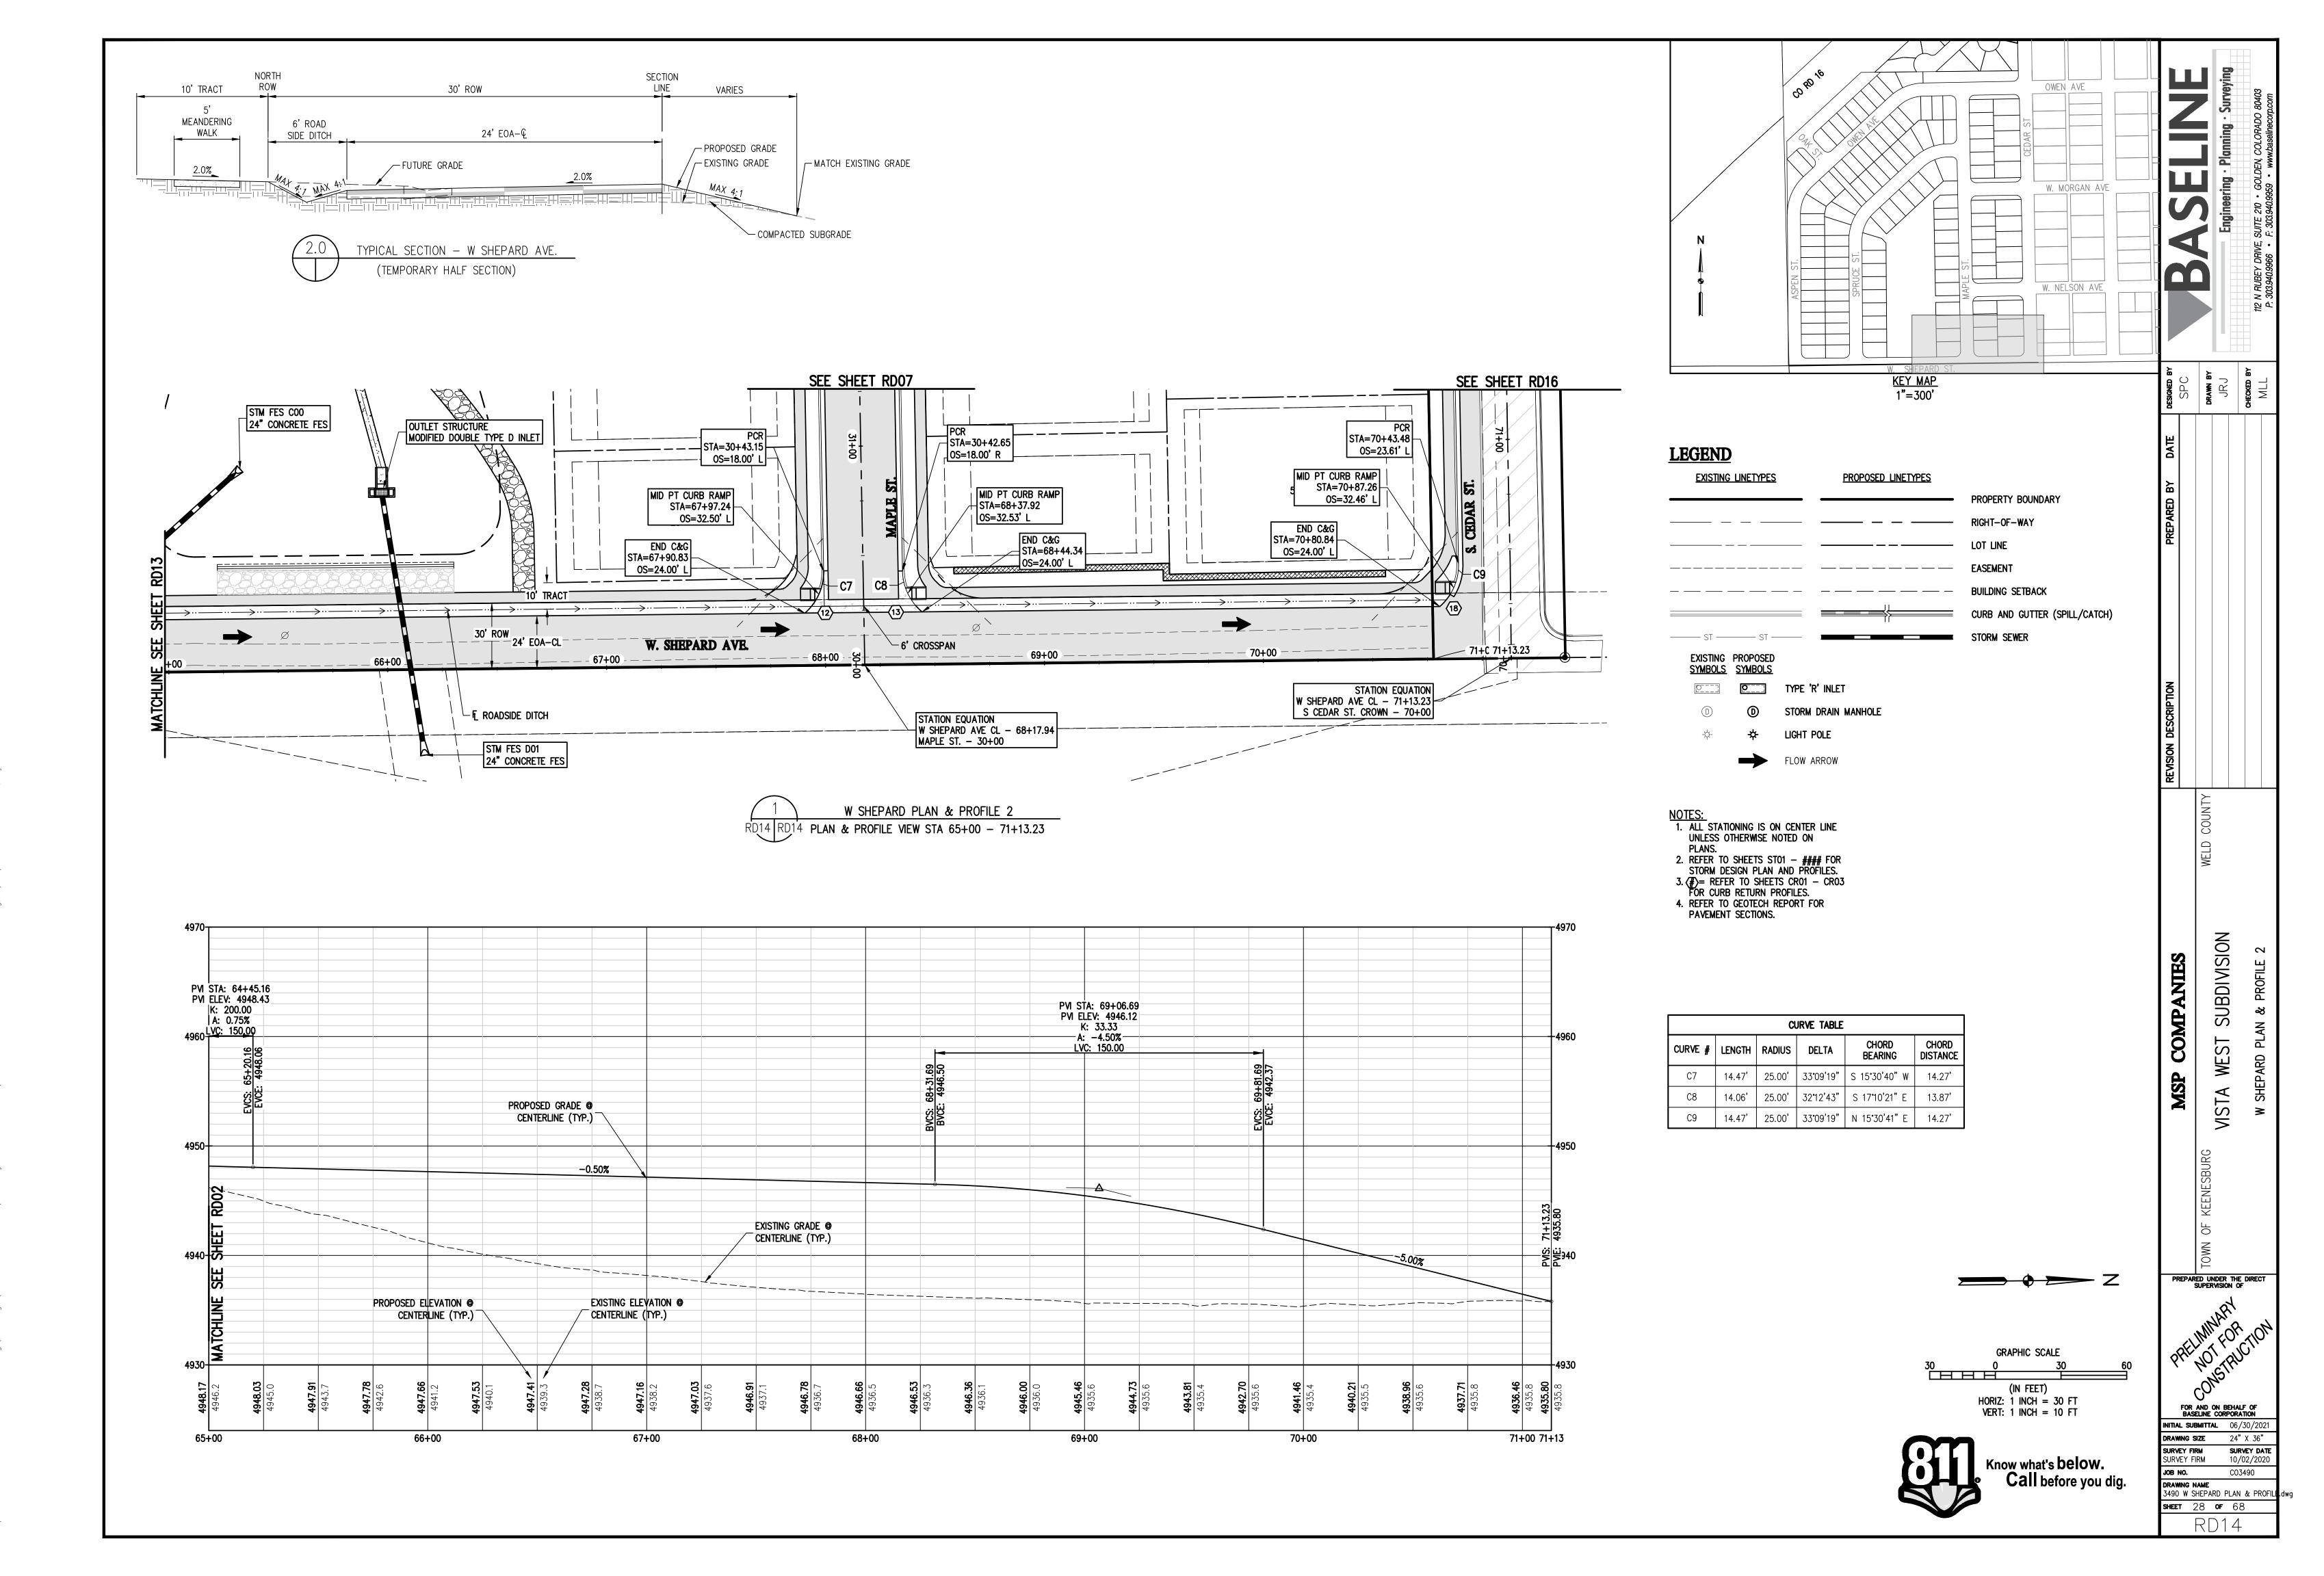


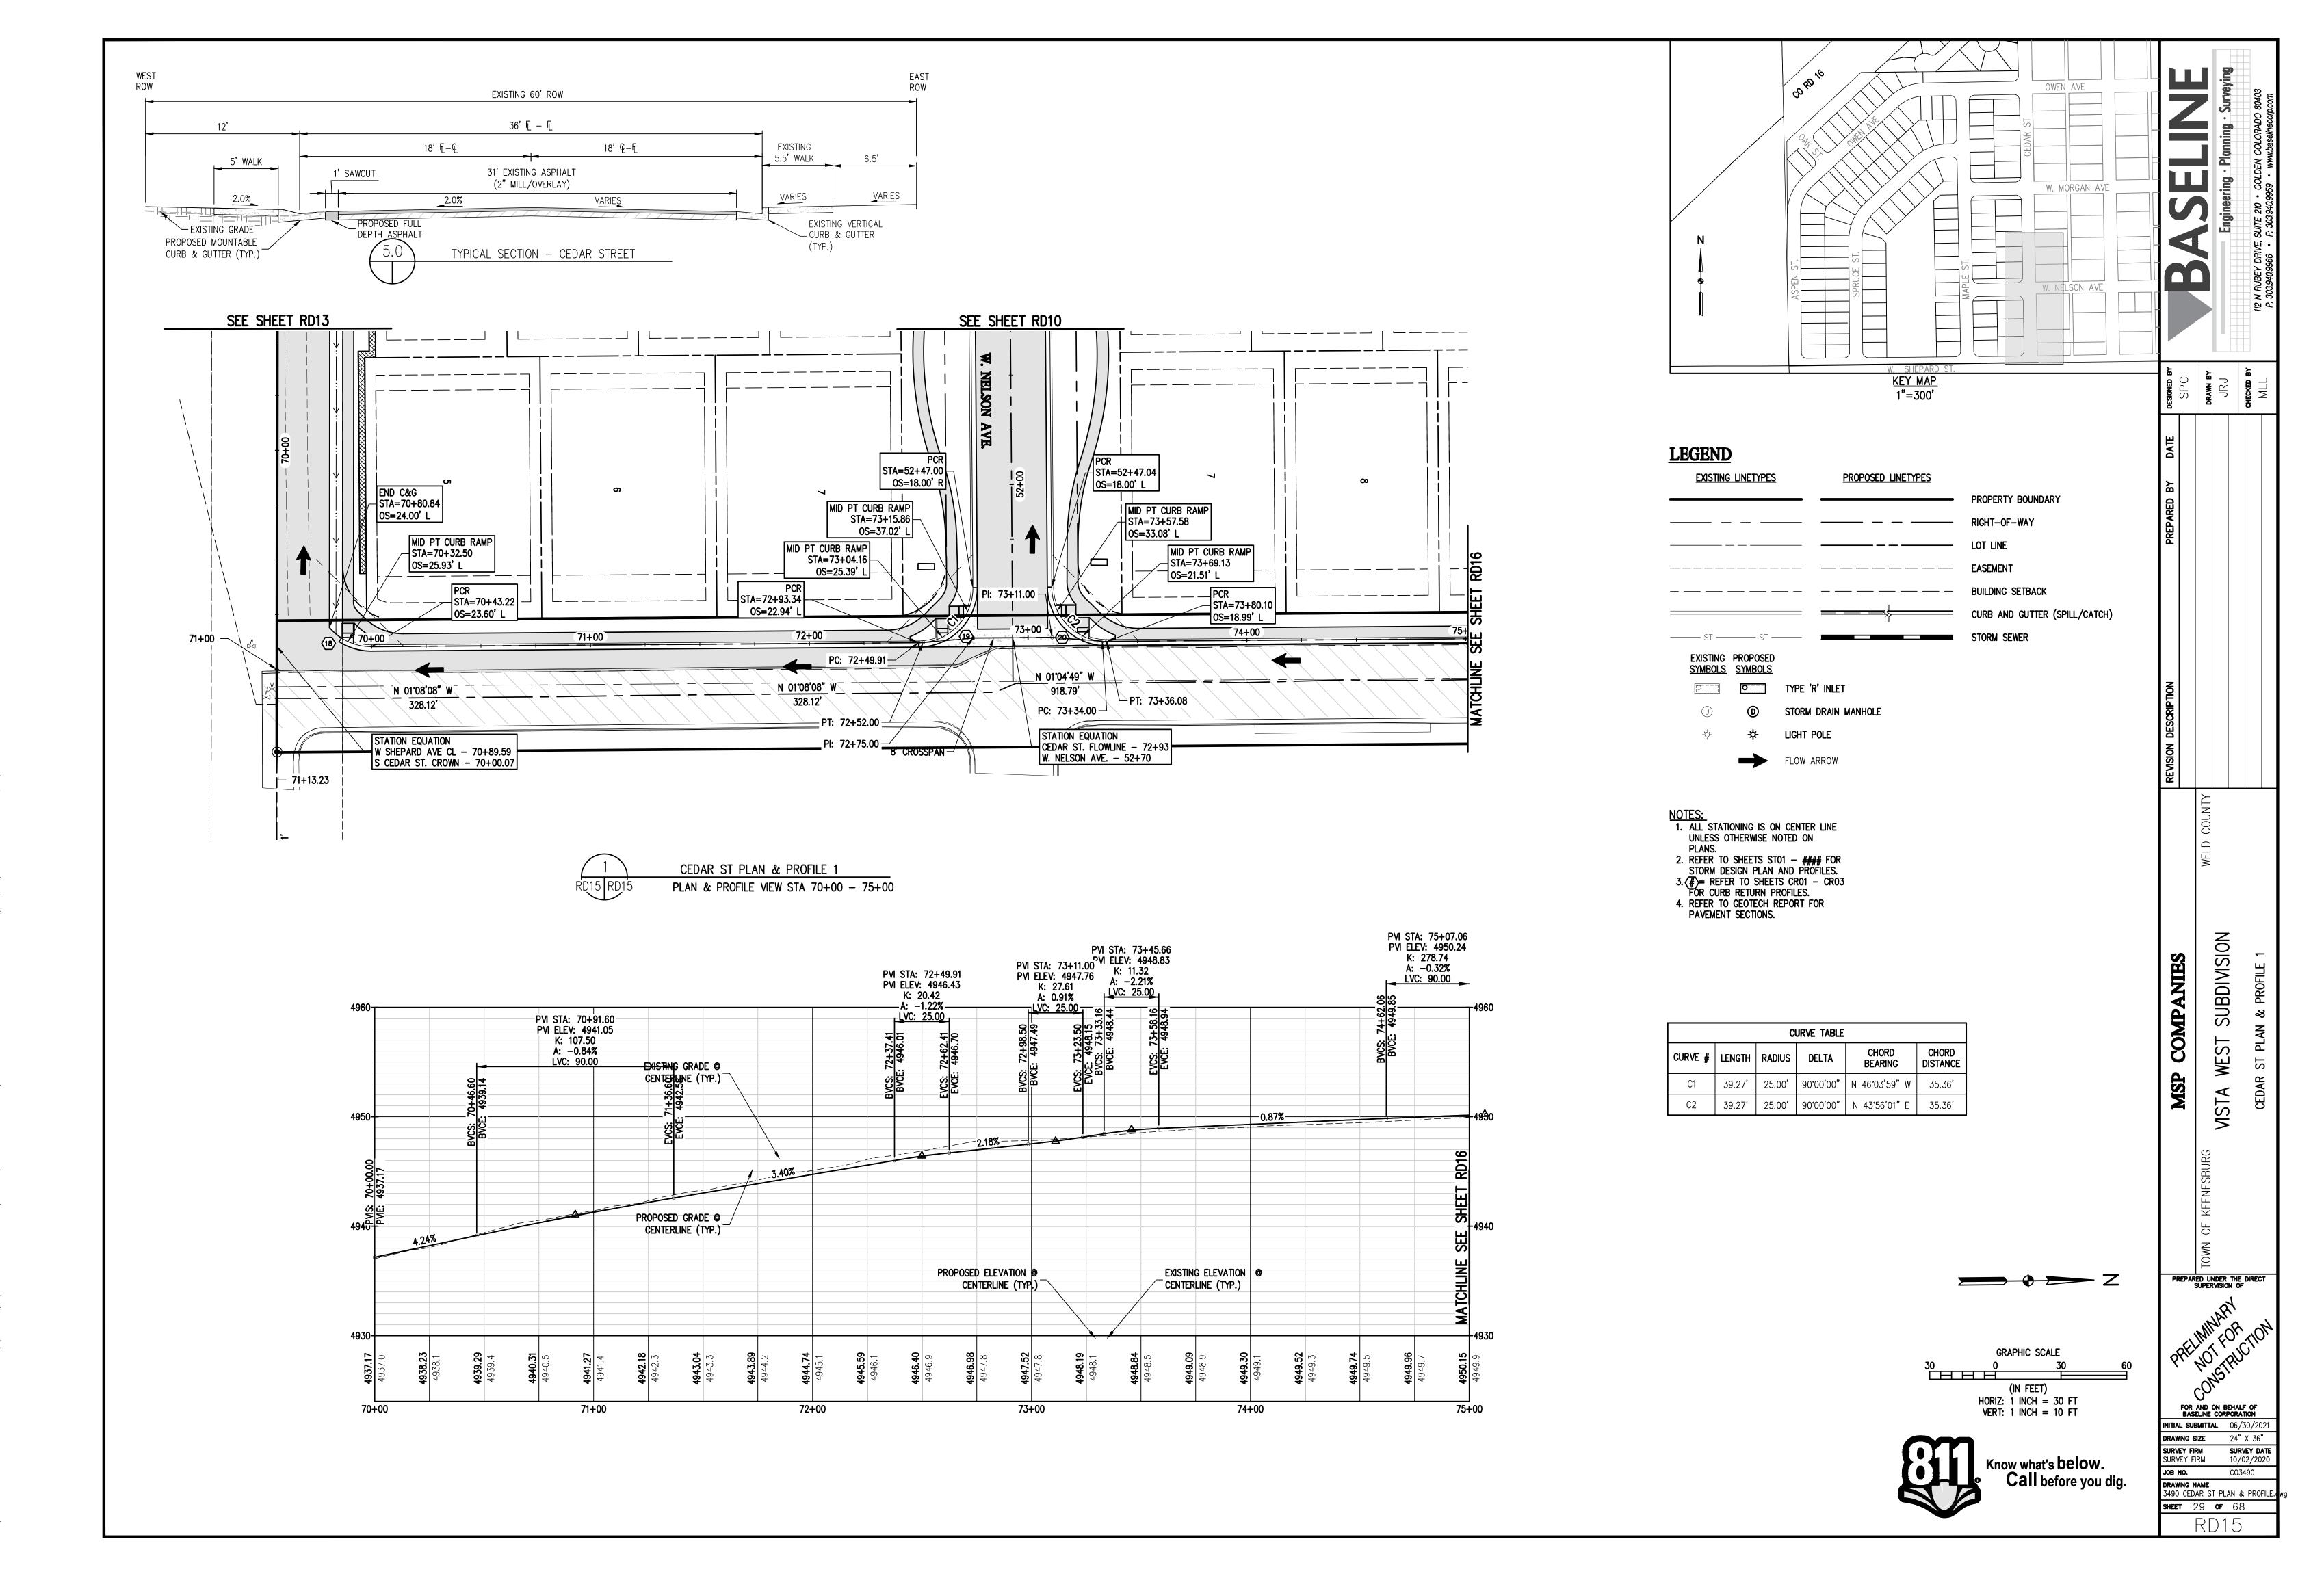

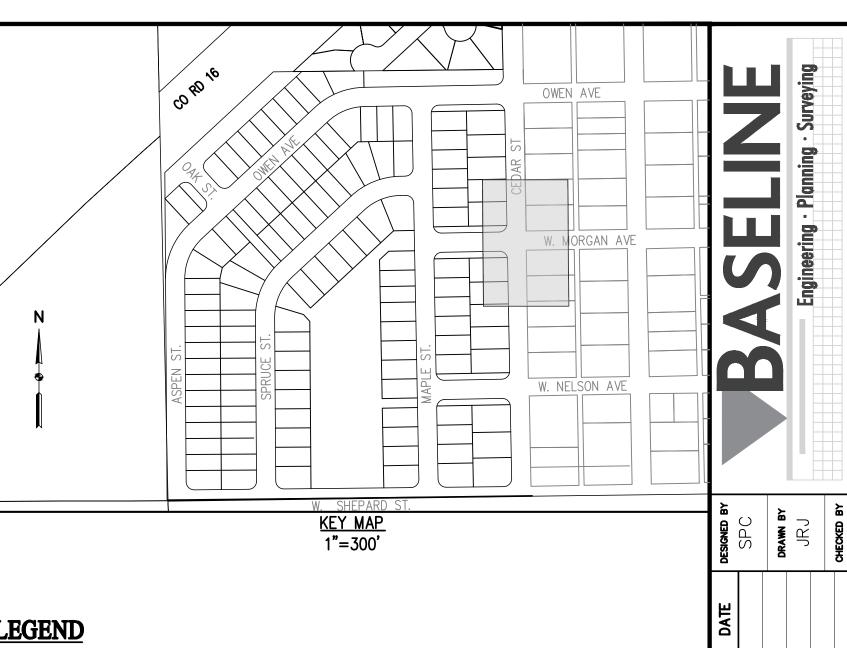


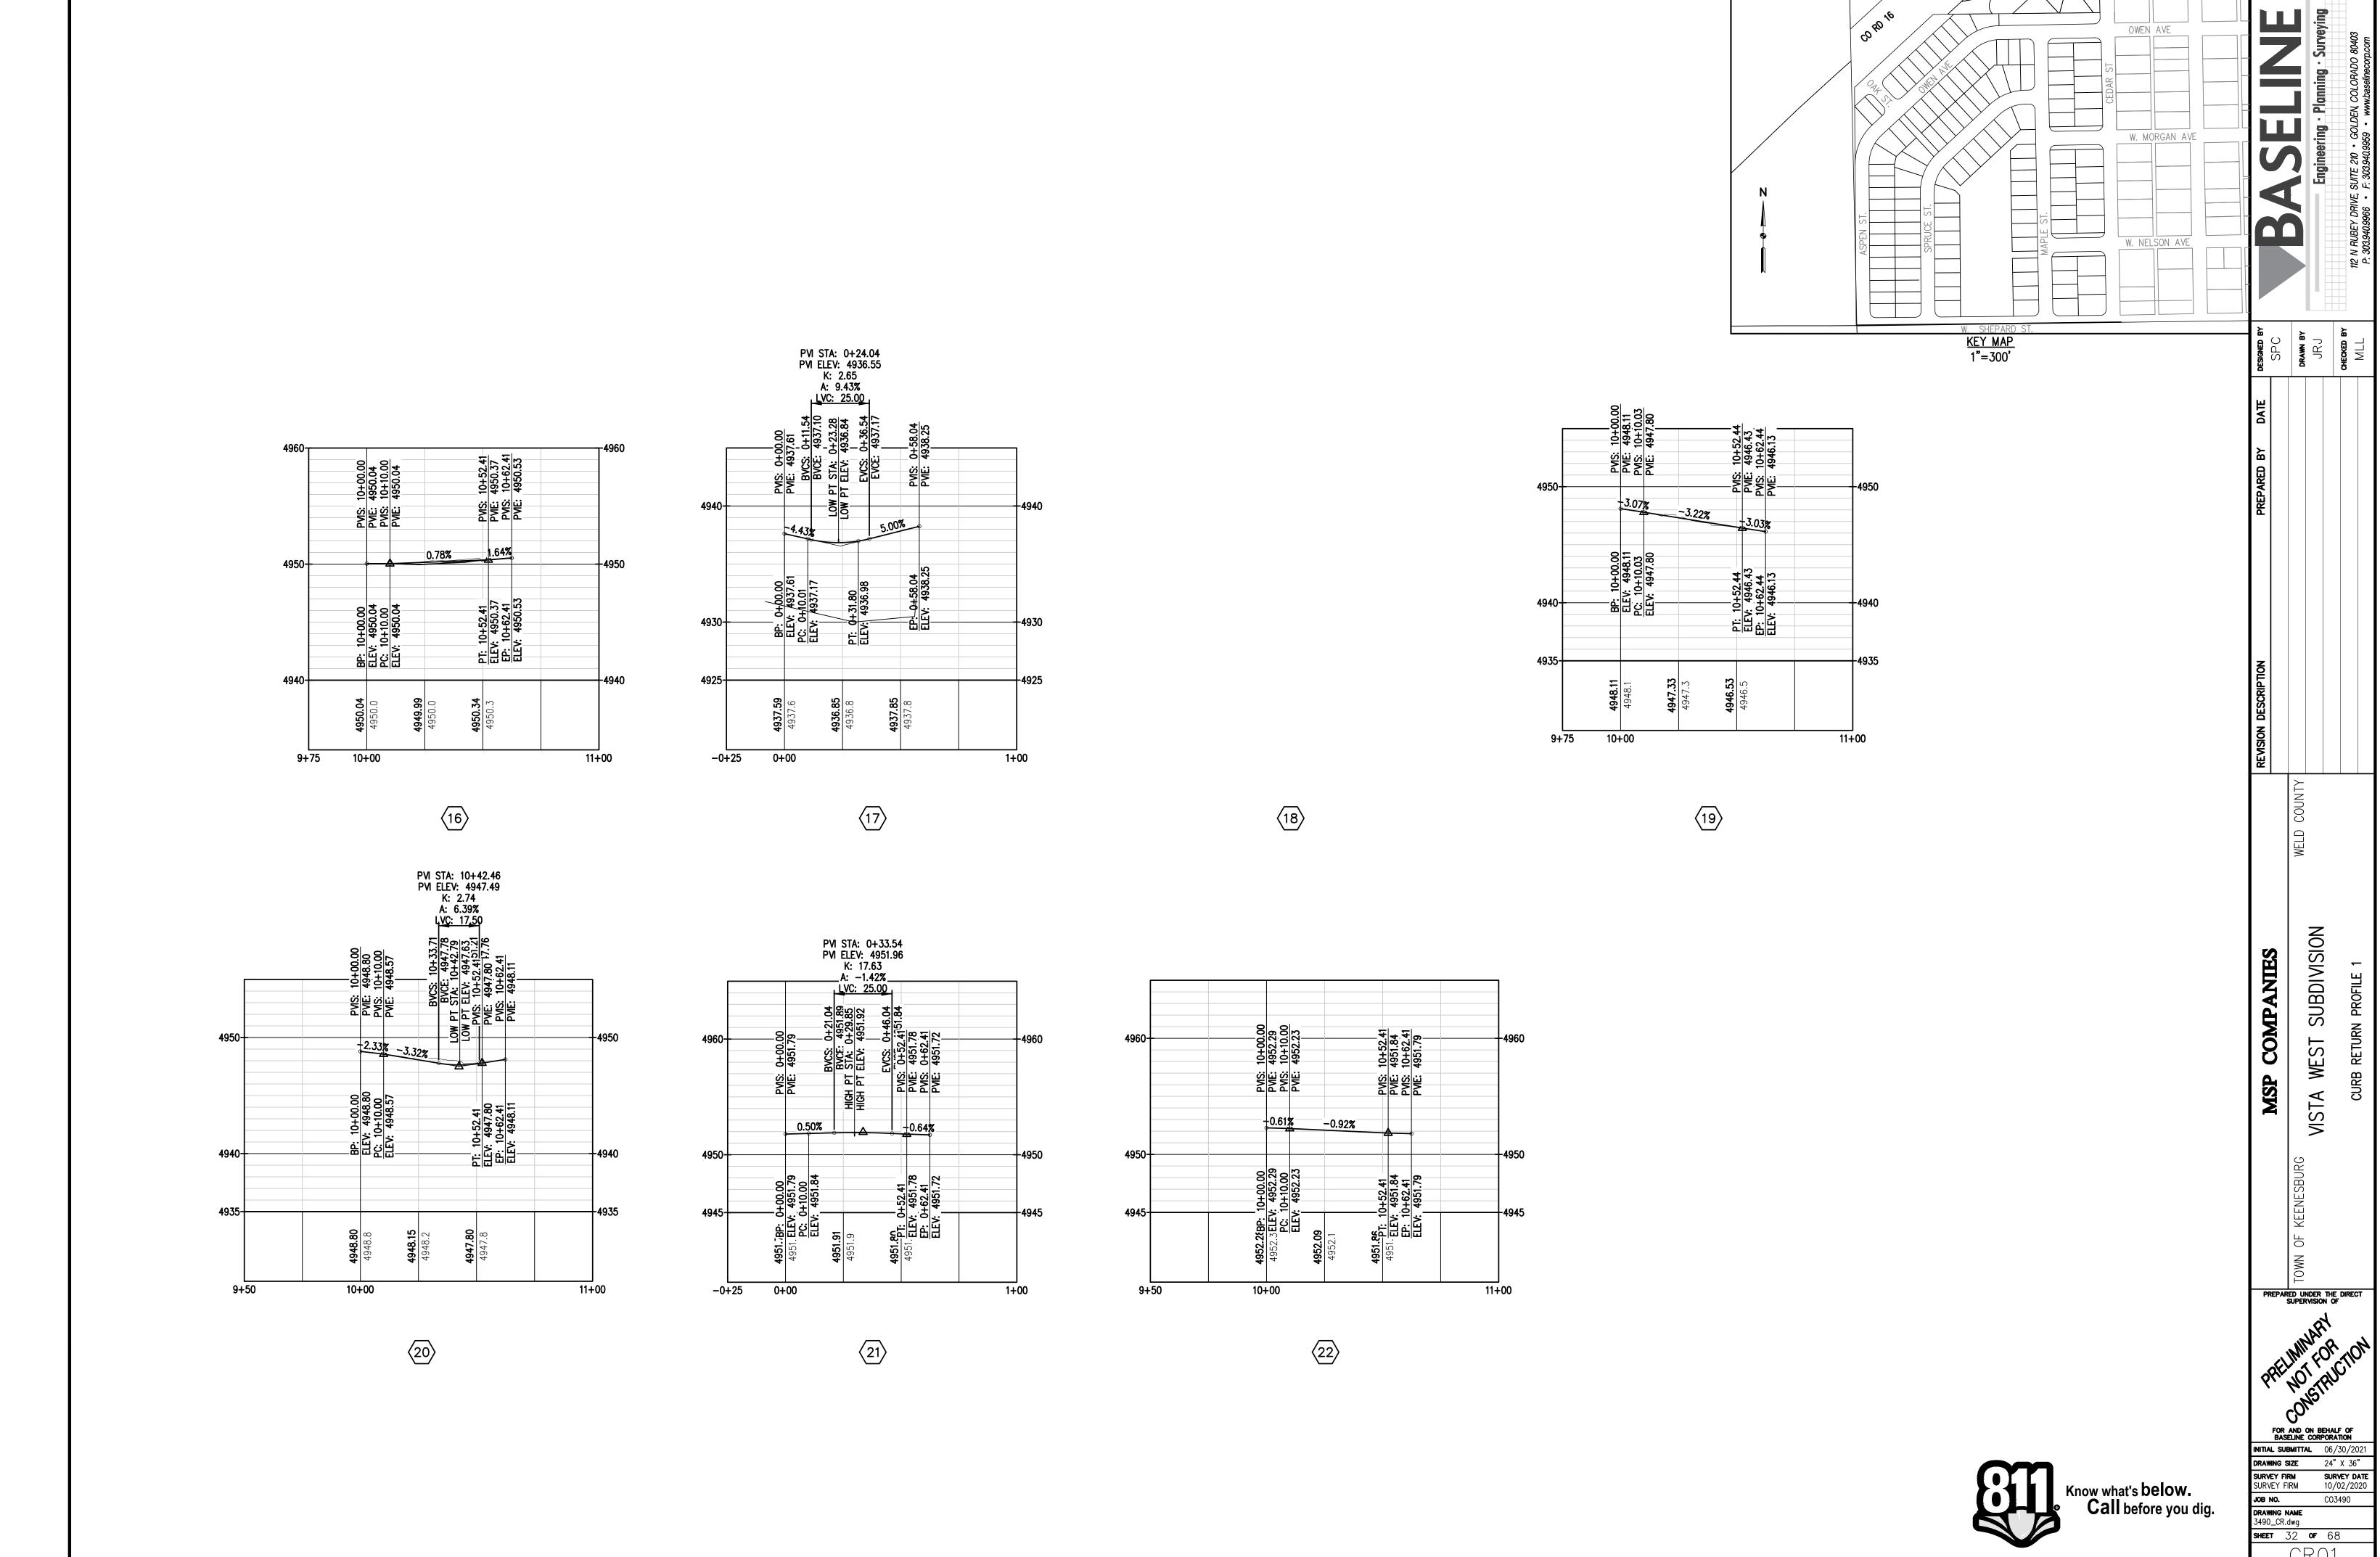

CR01

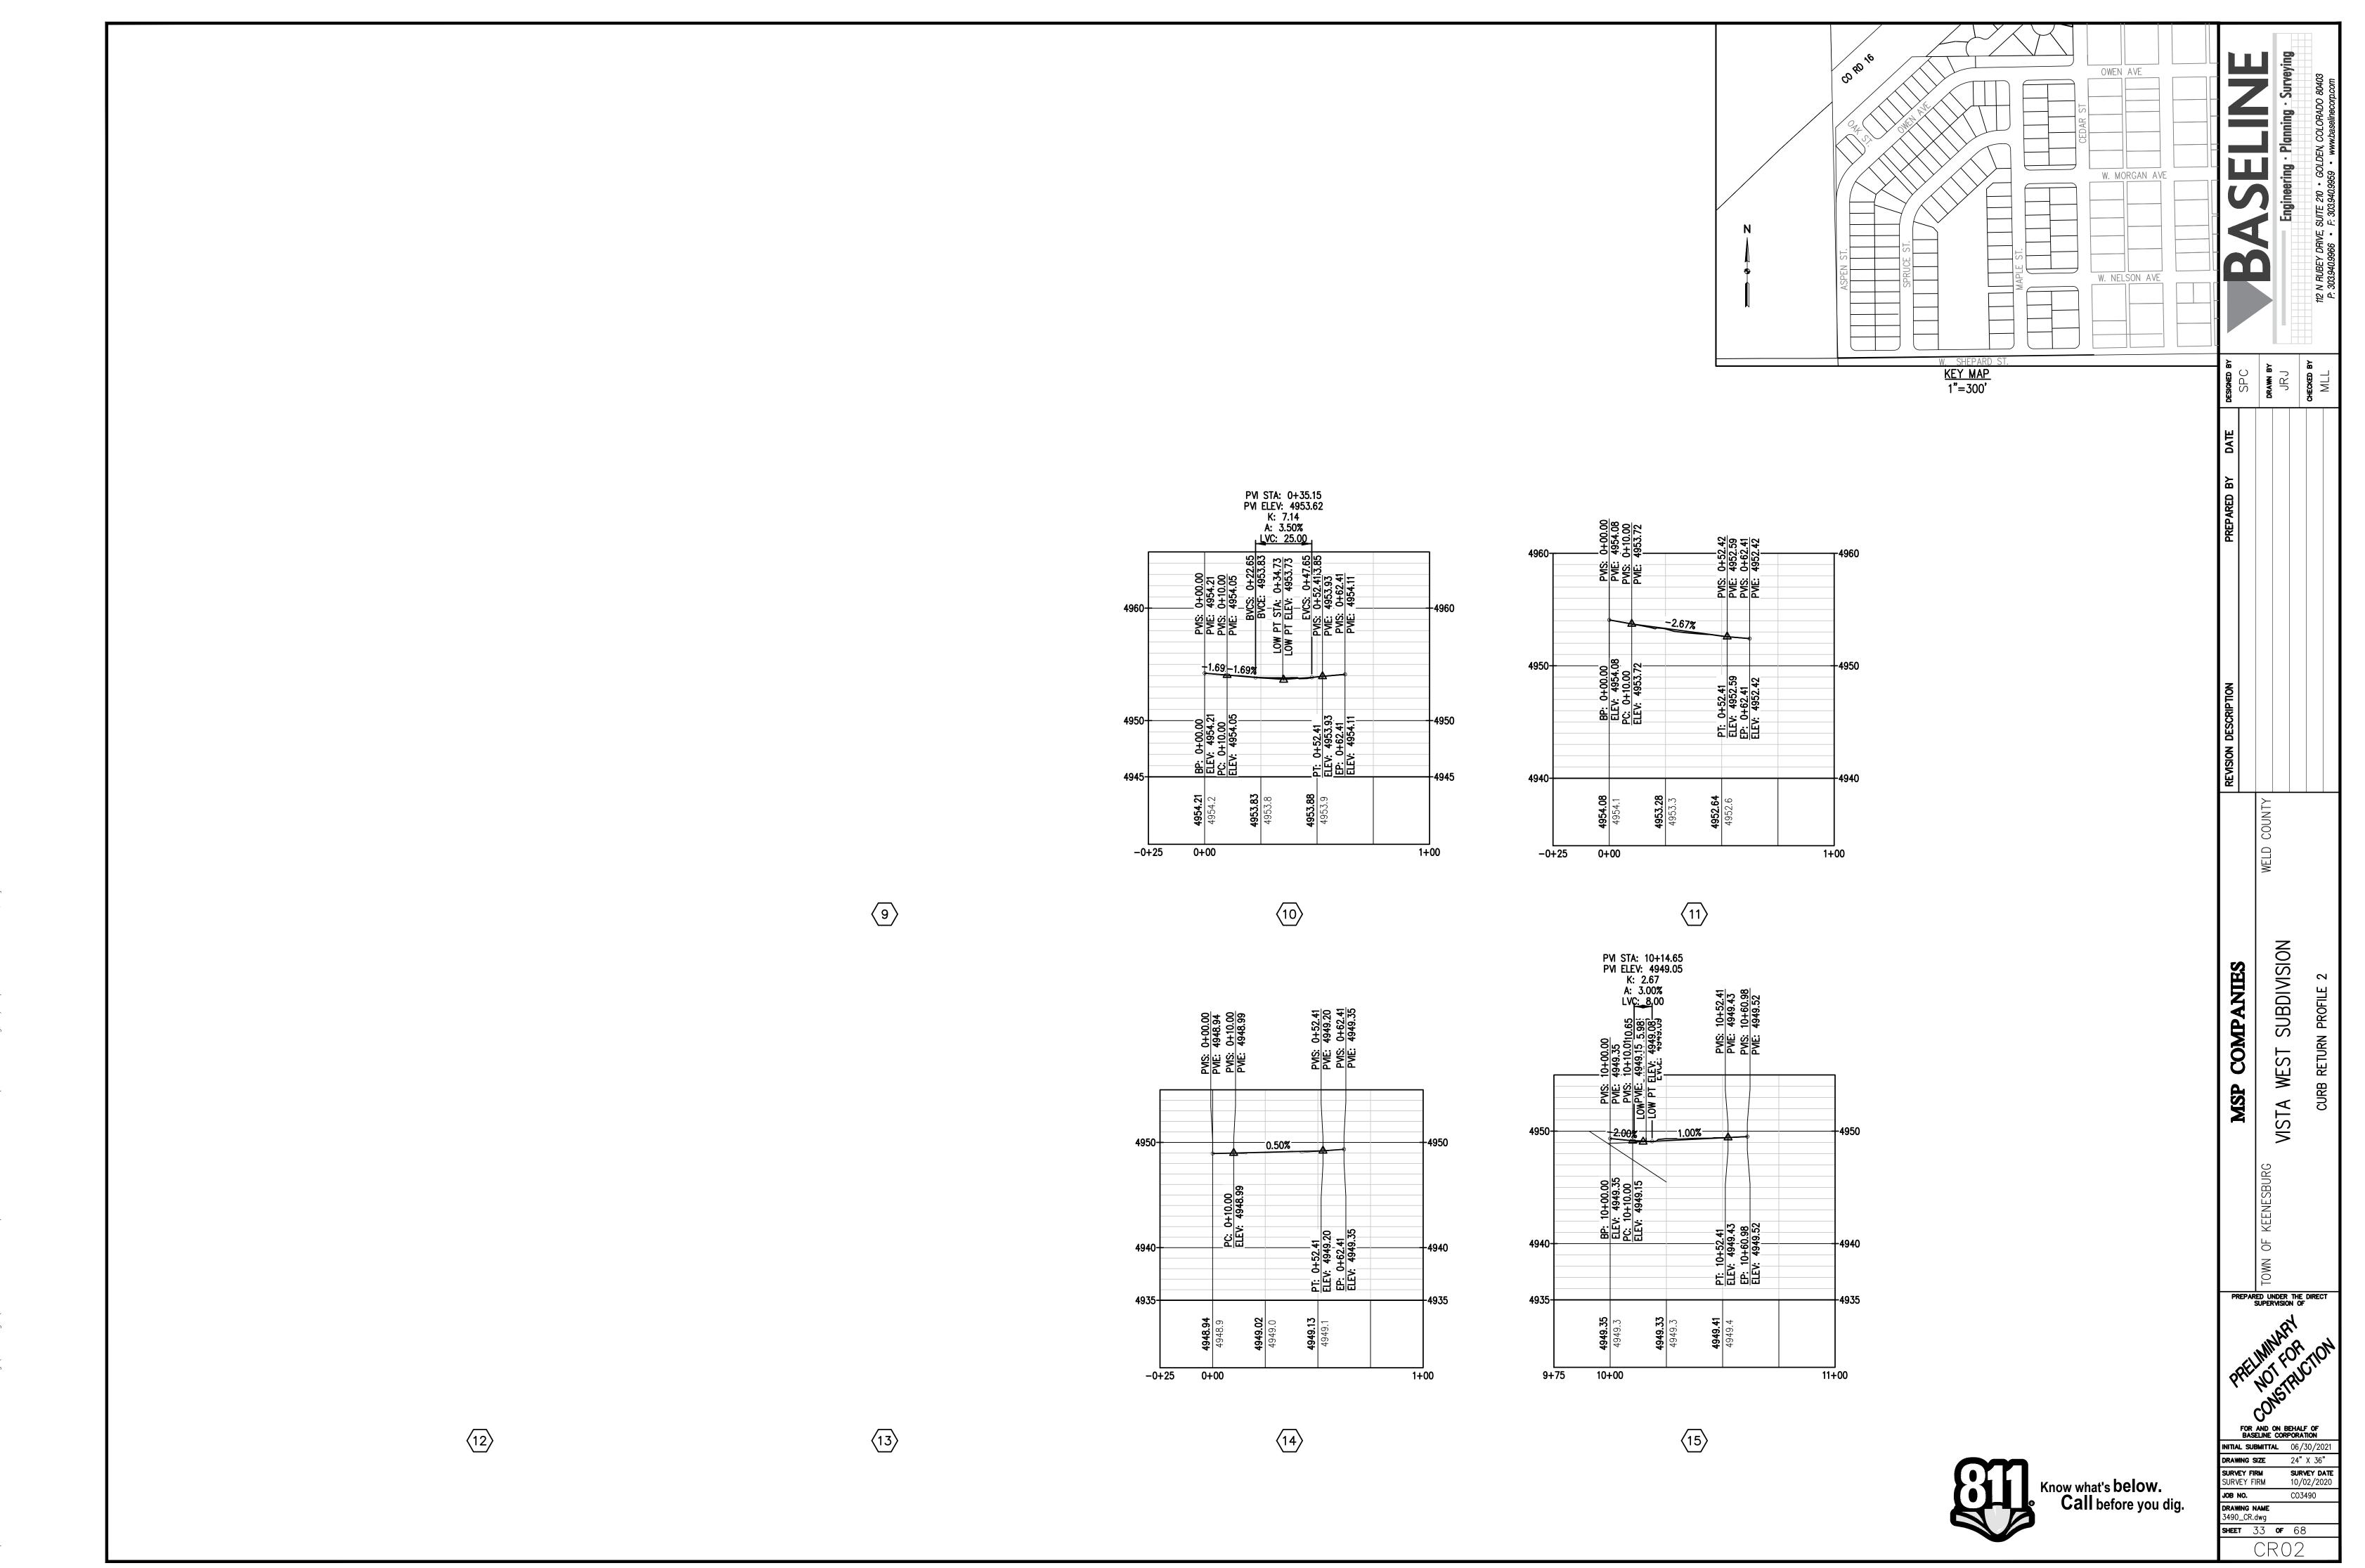

N:\co3490 — Summerfield — Keenesburq\Drawings\Construction Plans\Curb Returns and Profiles\3490\_CR.dwq, 6/30/2021 9:14:14 AM, Ryan Schultz

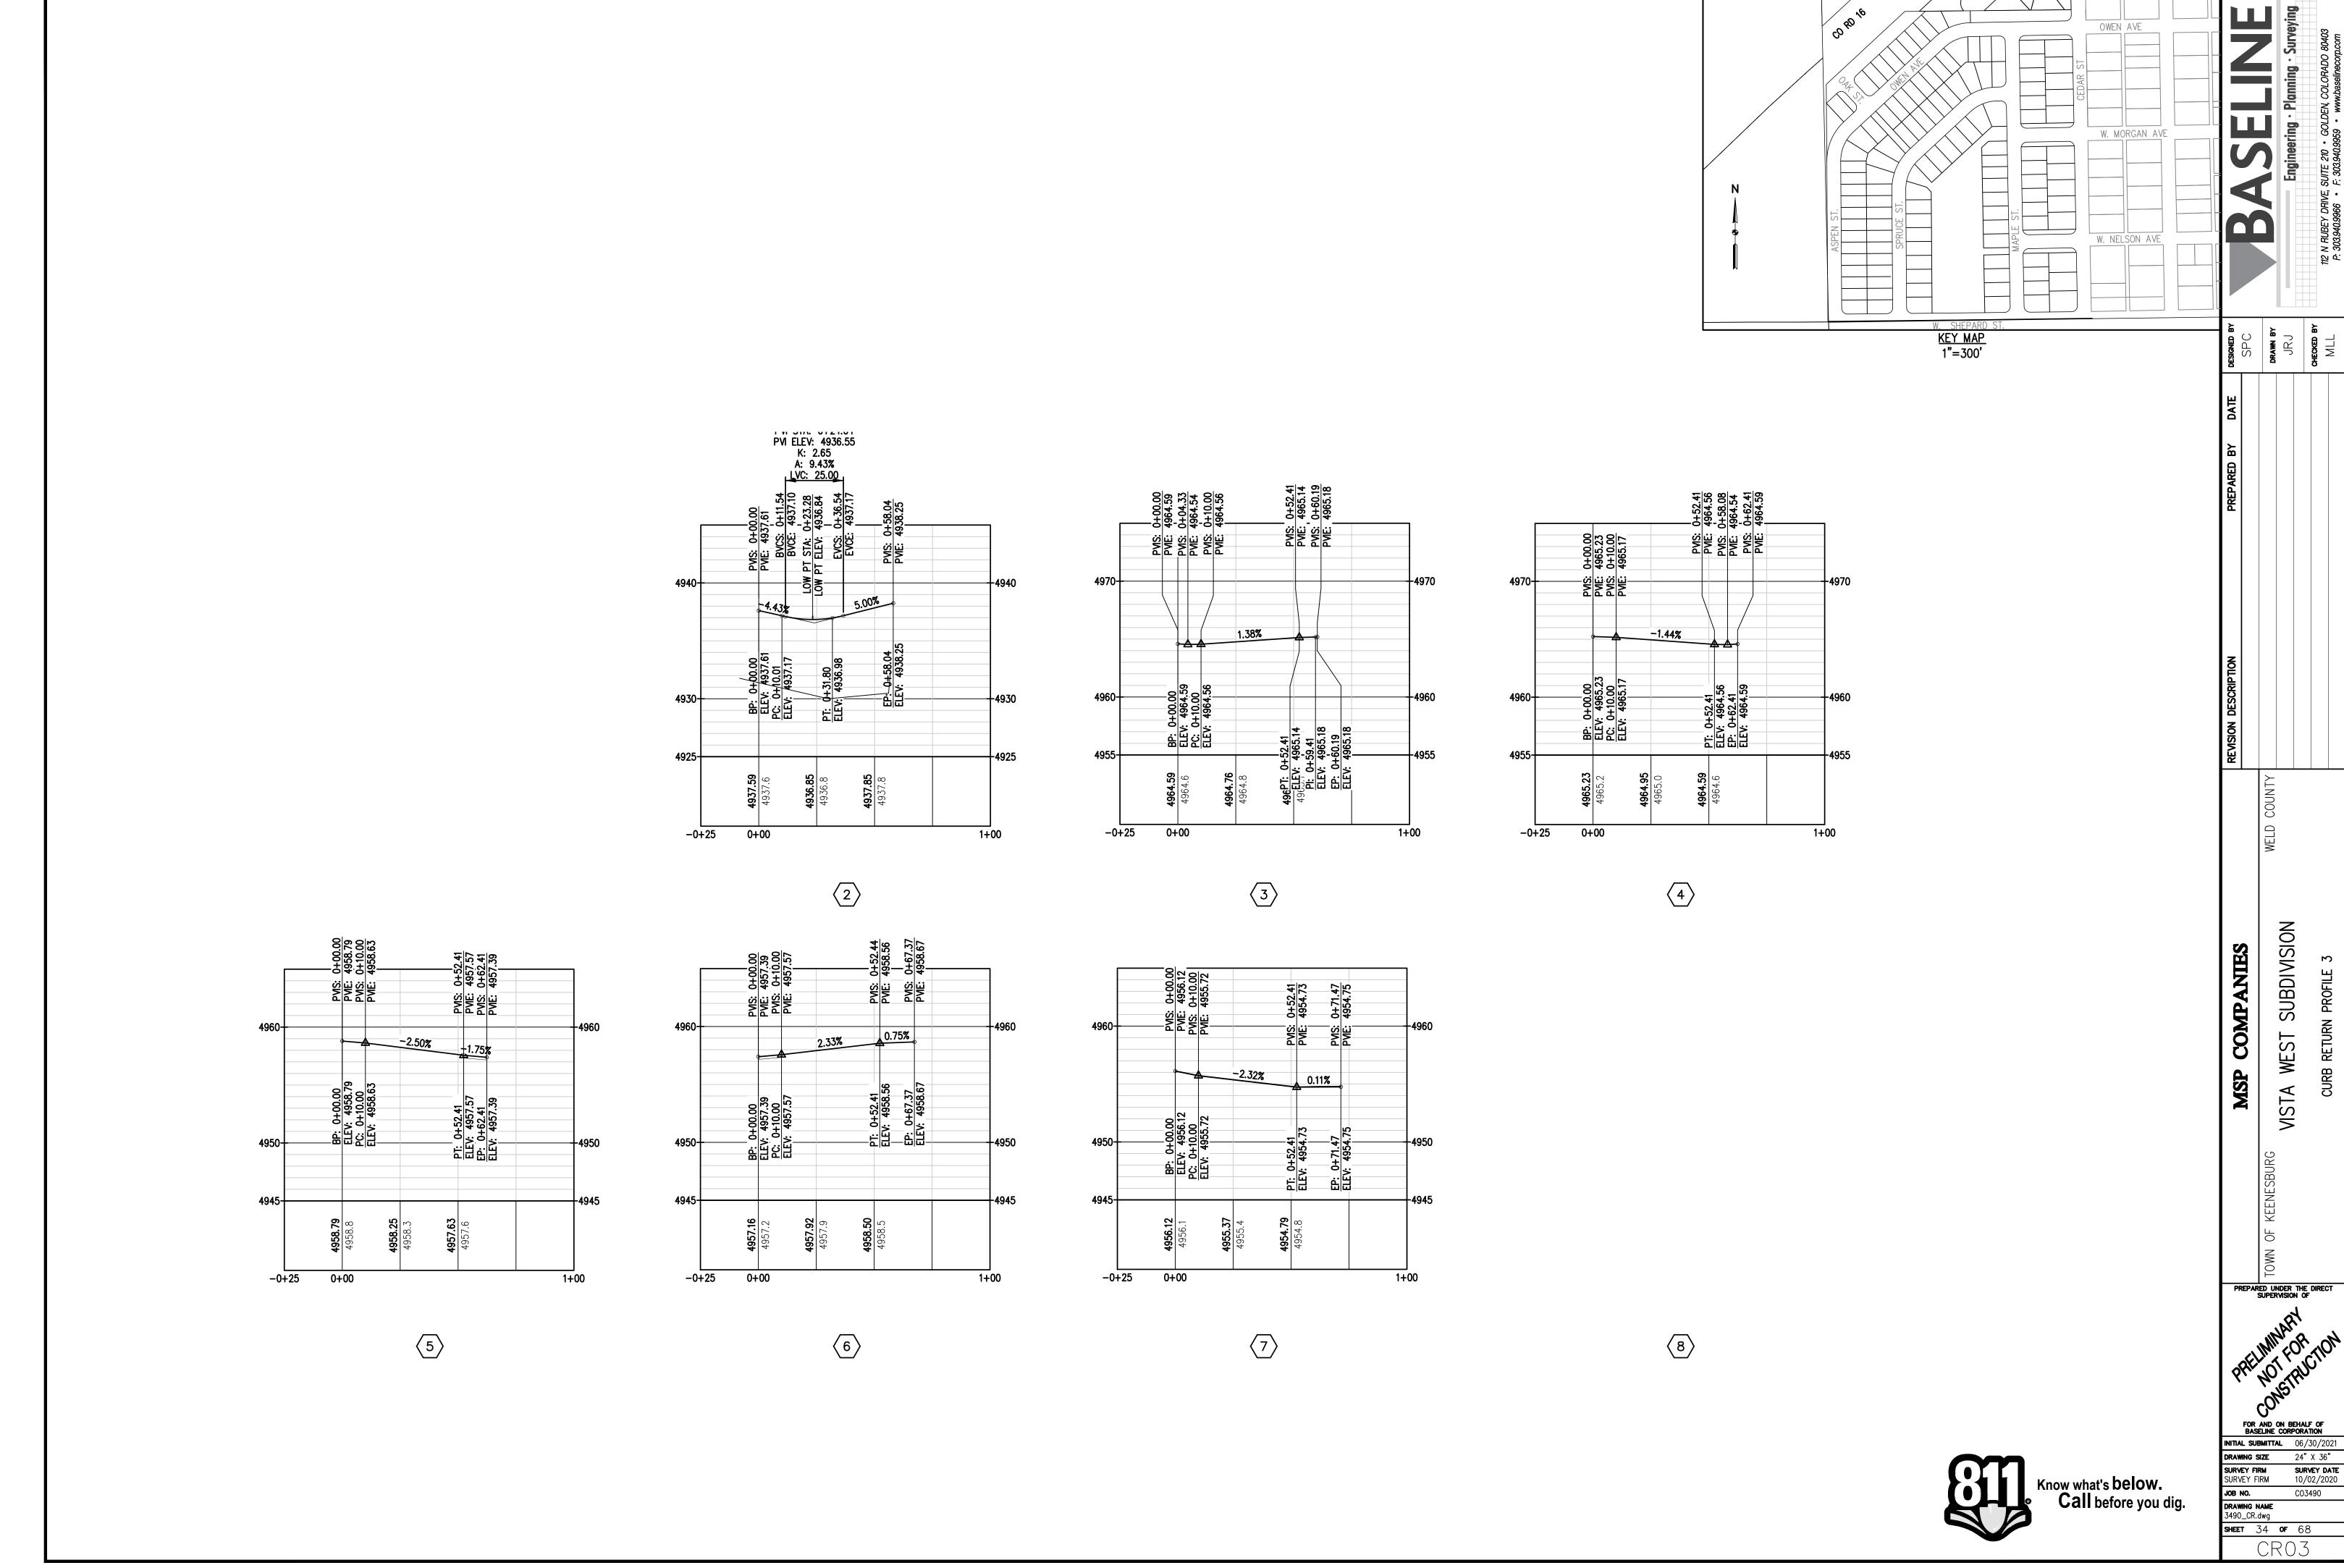

Know what's **below.**Call before you dig.

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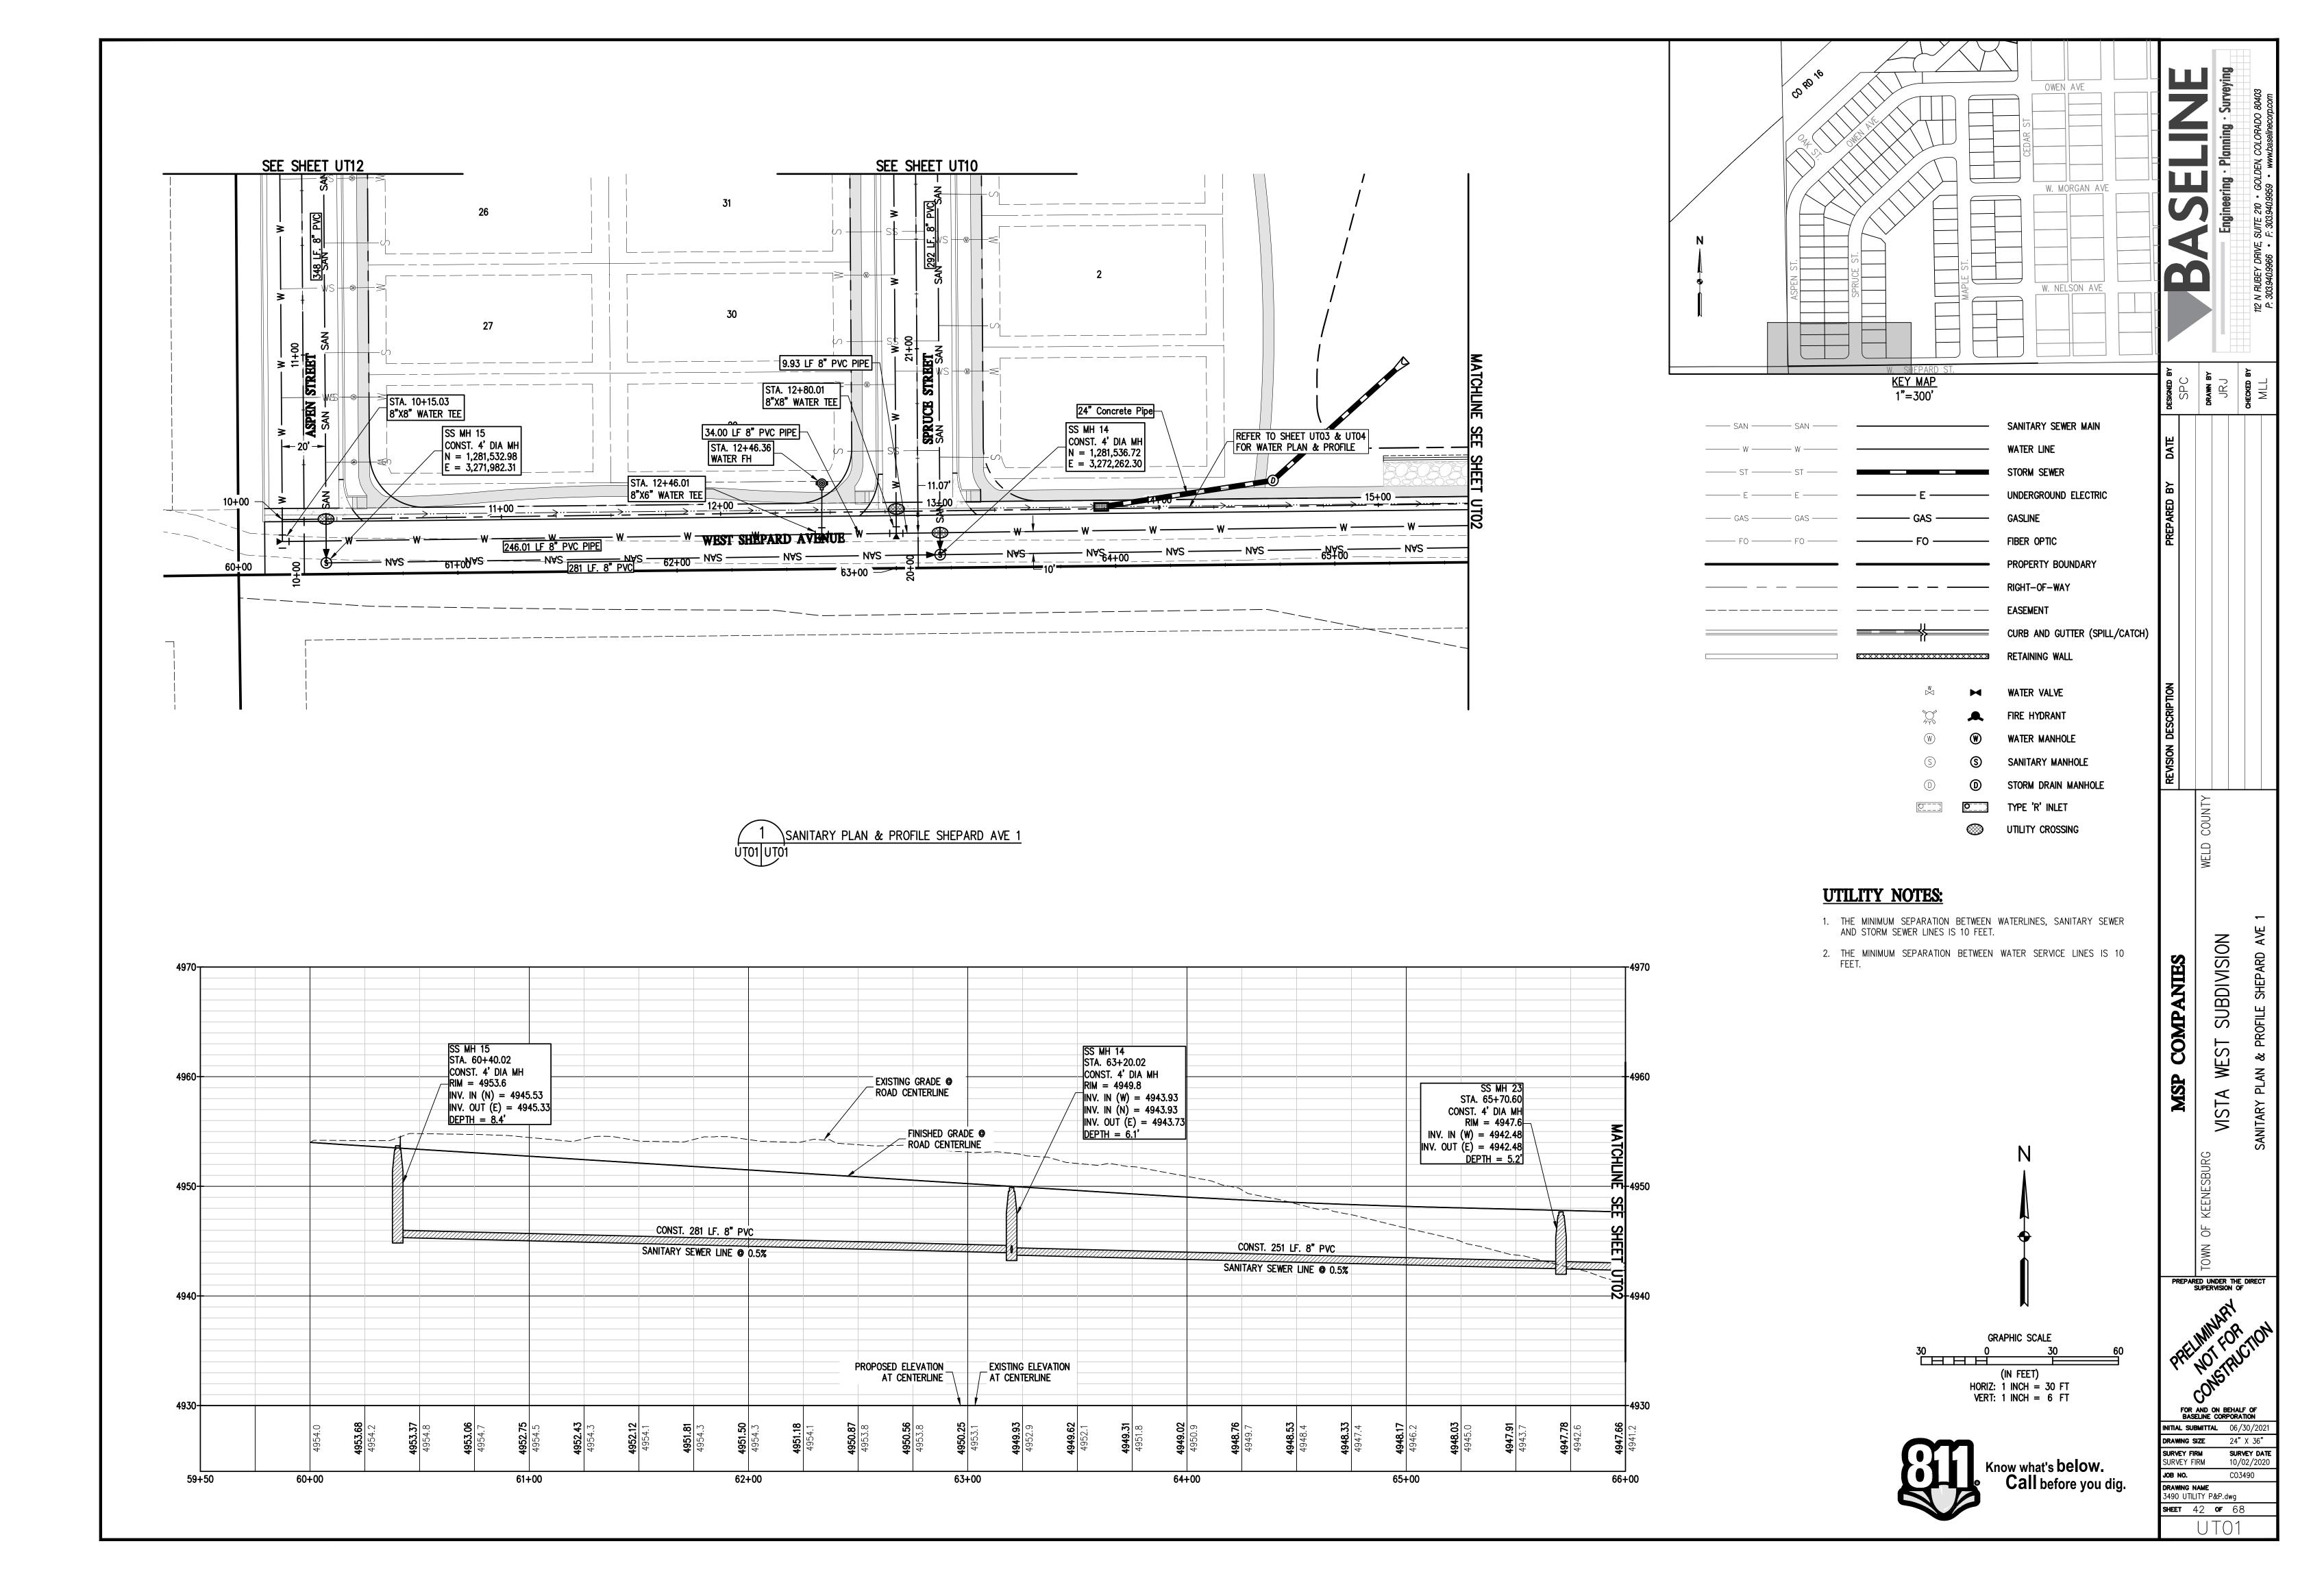
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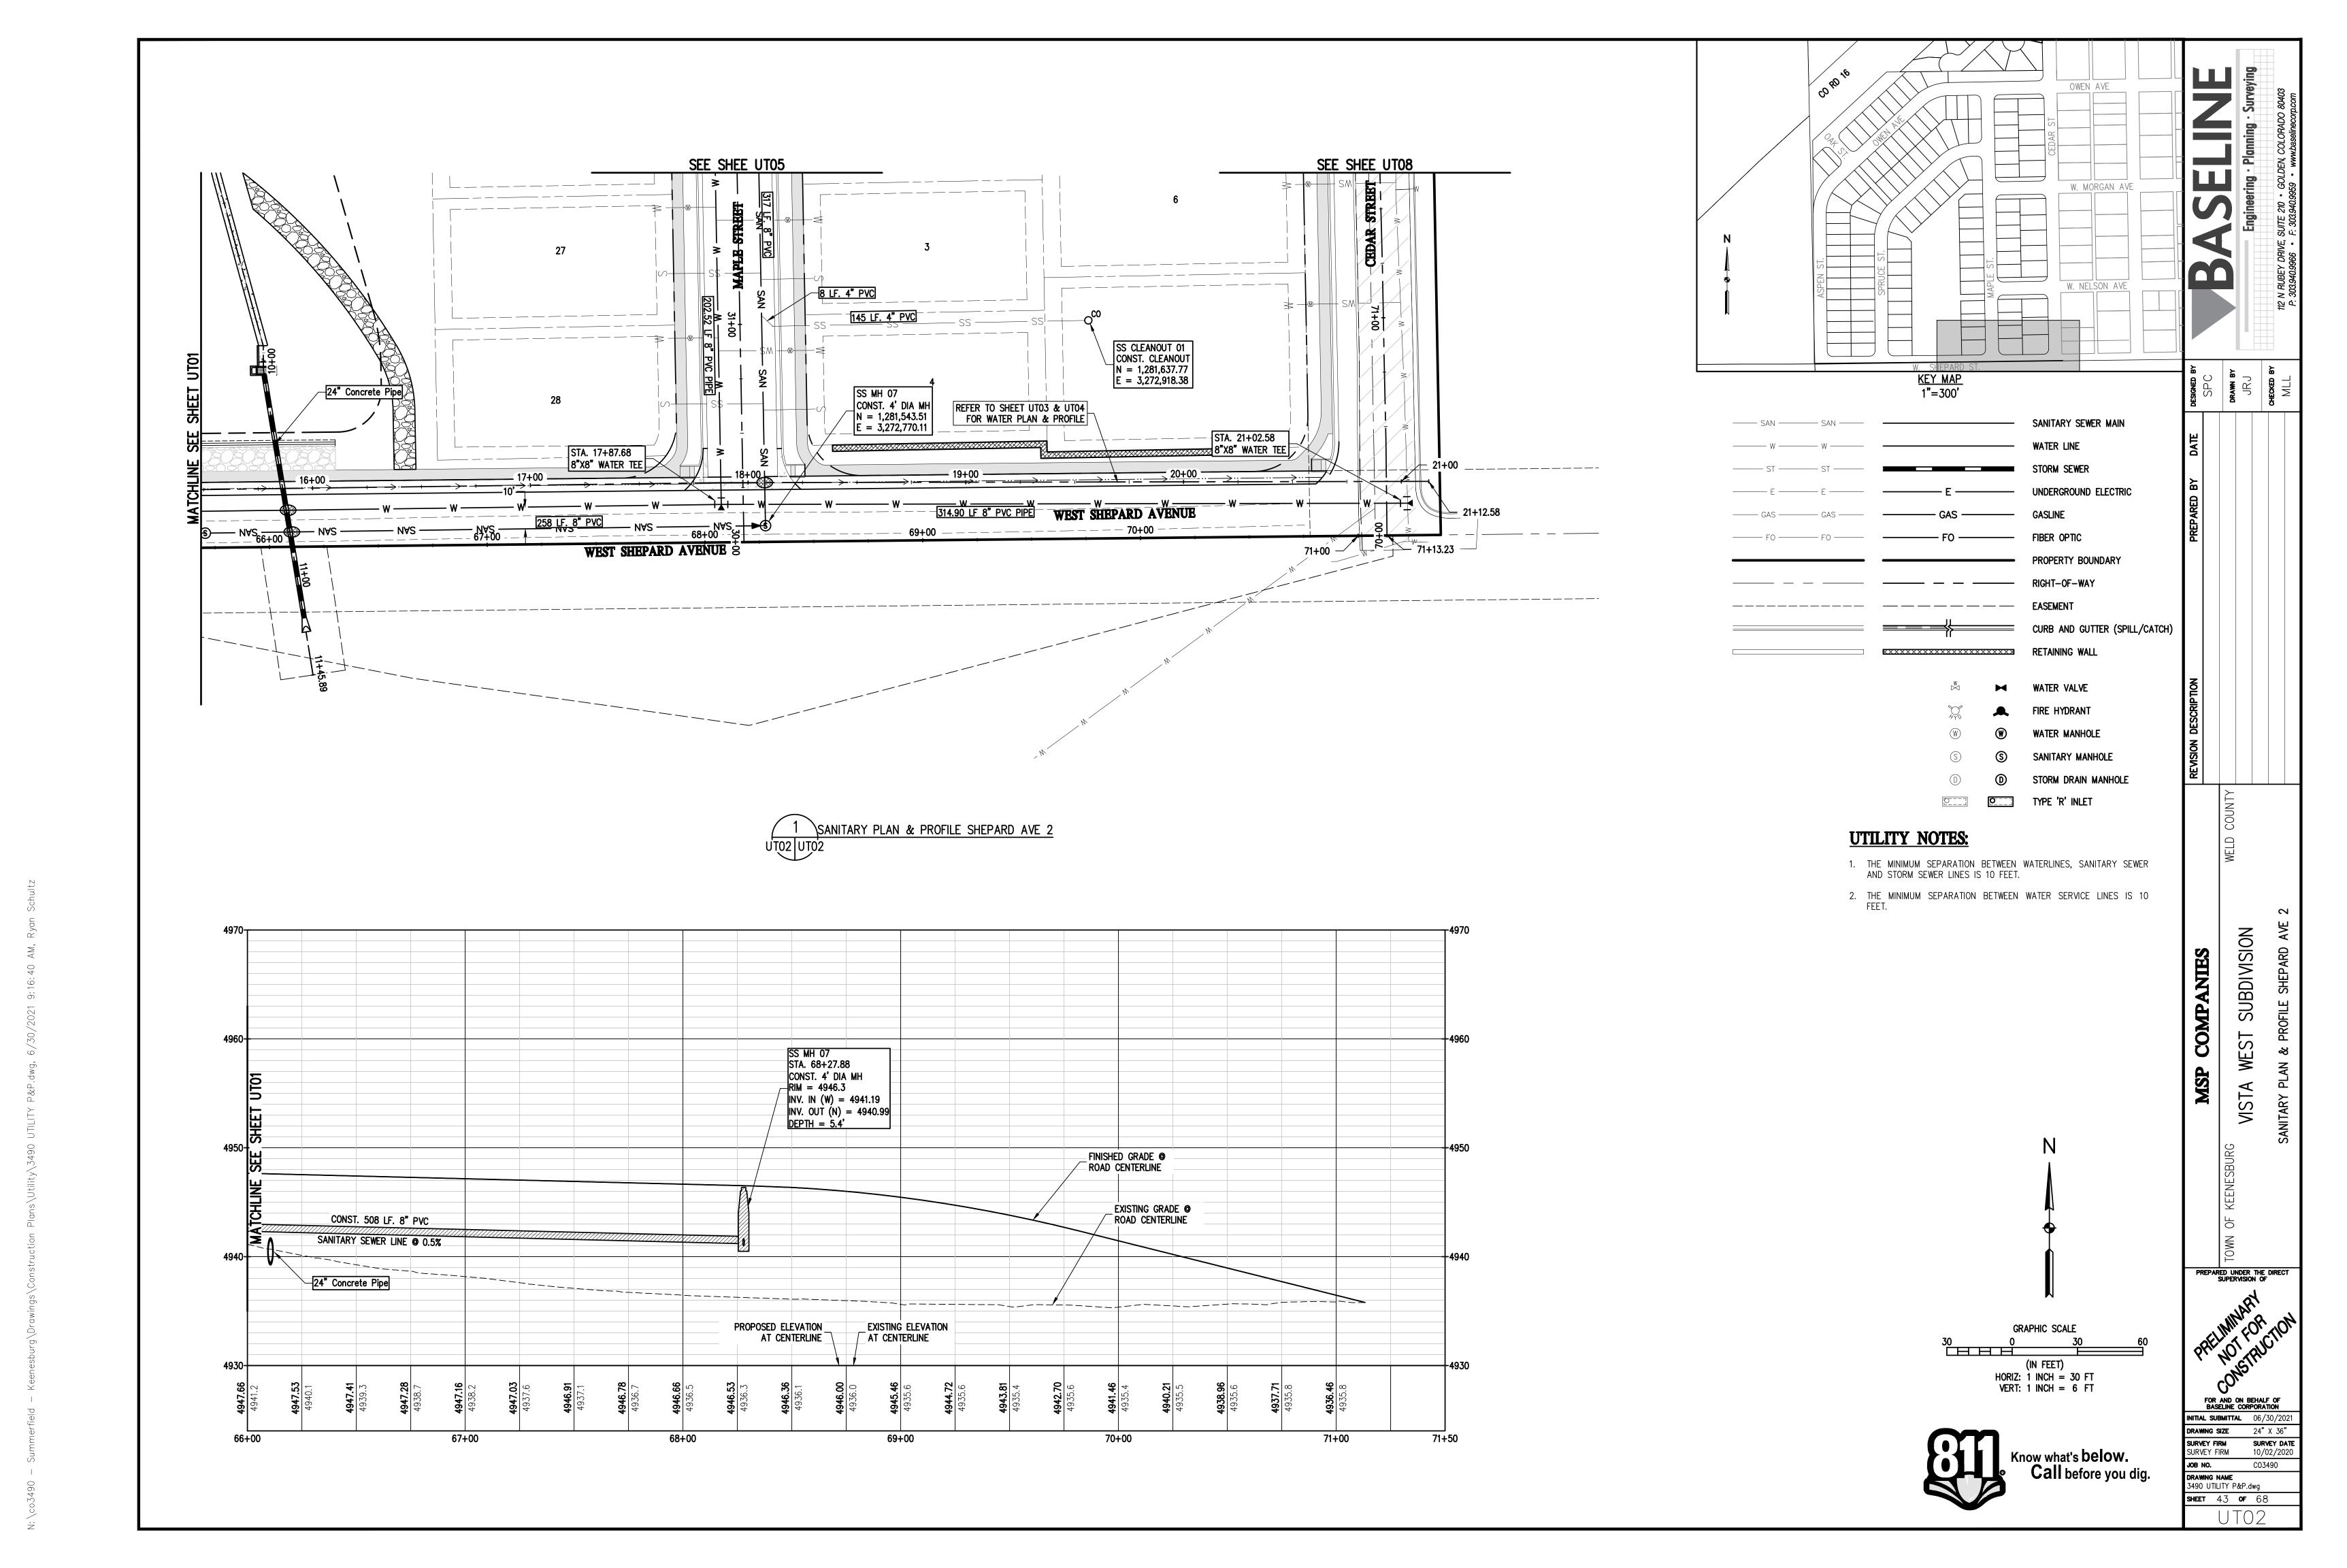
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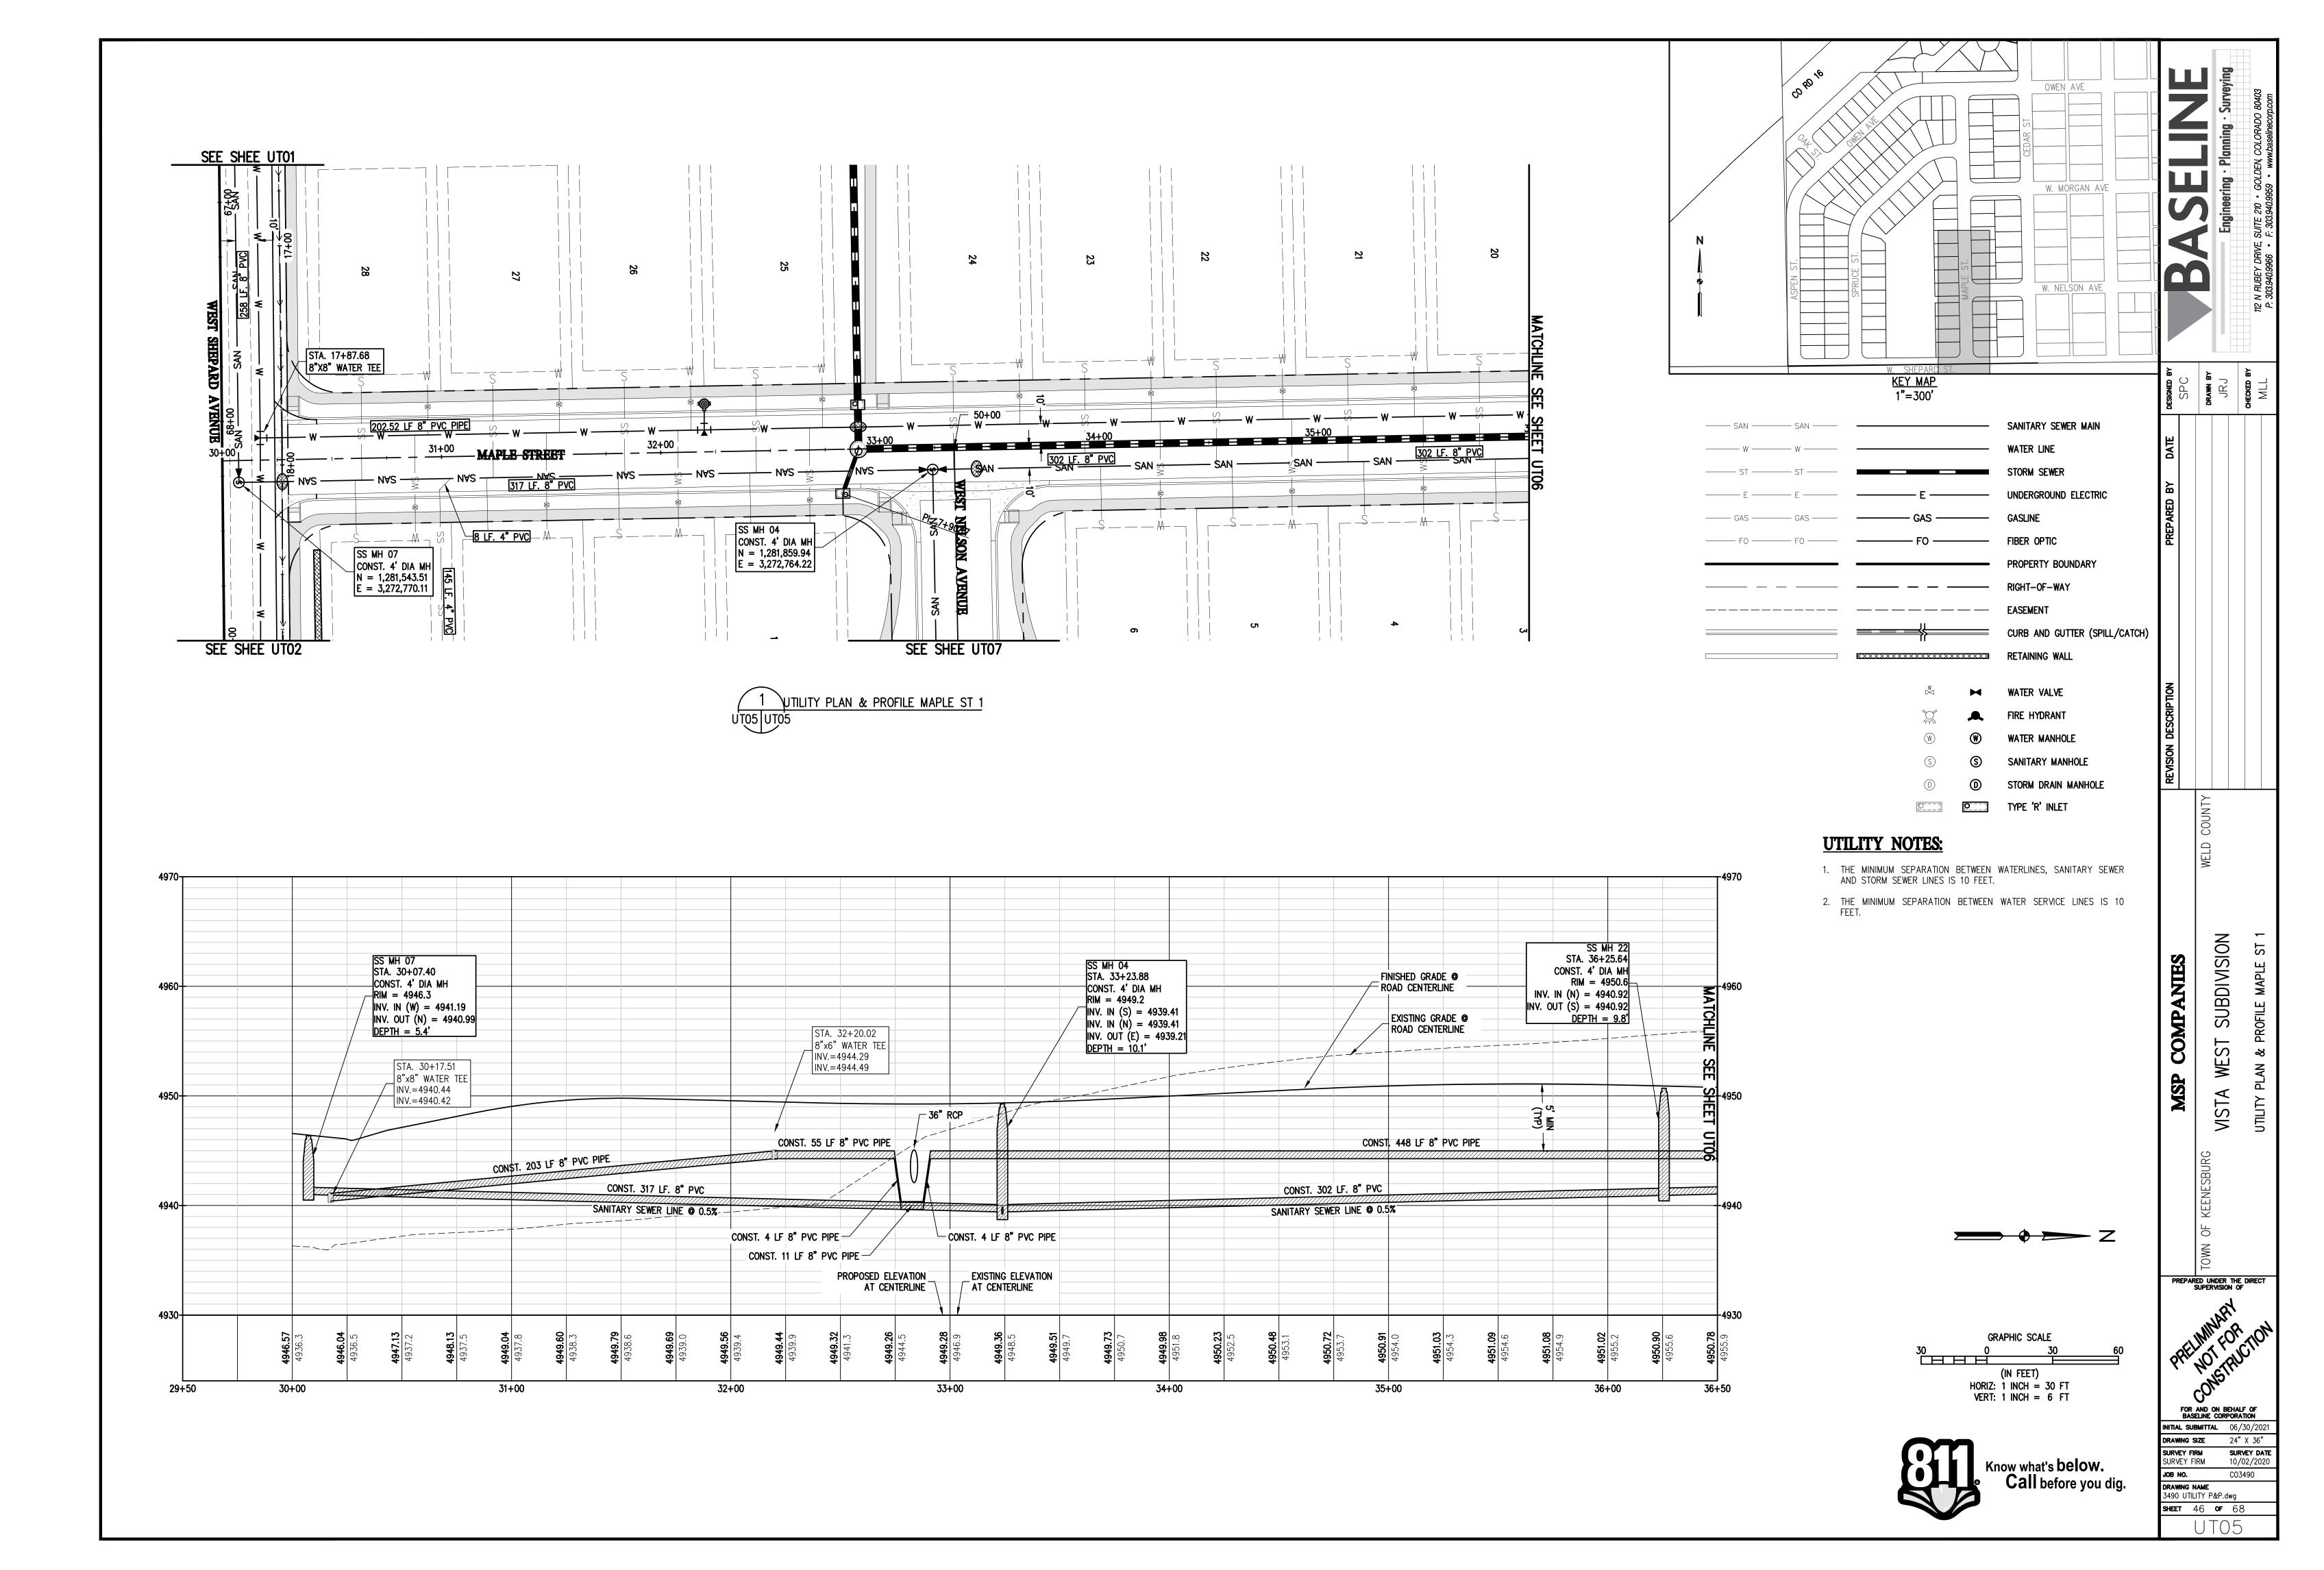


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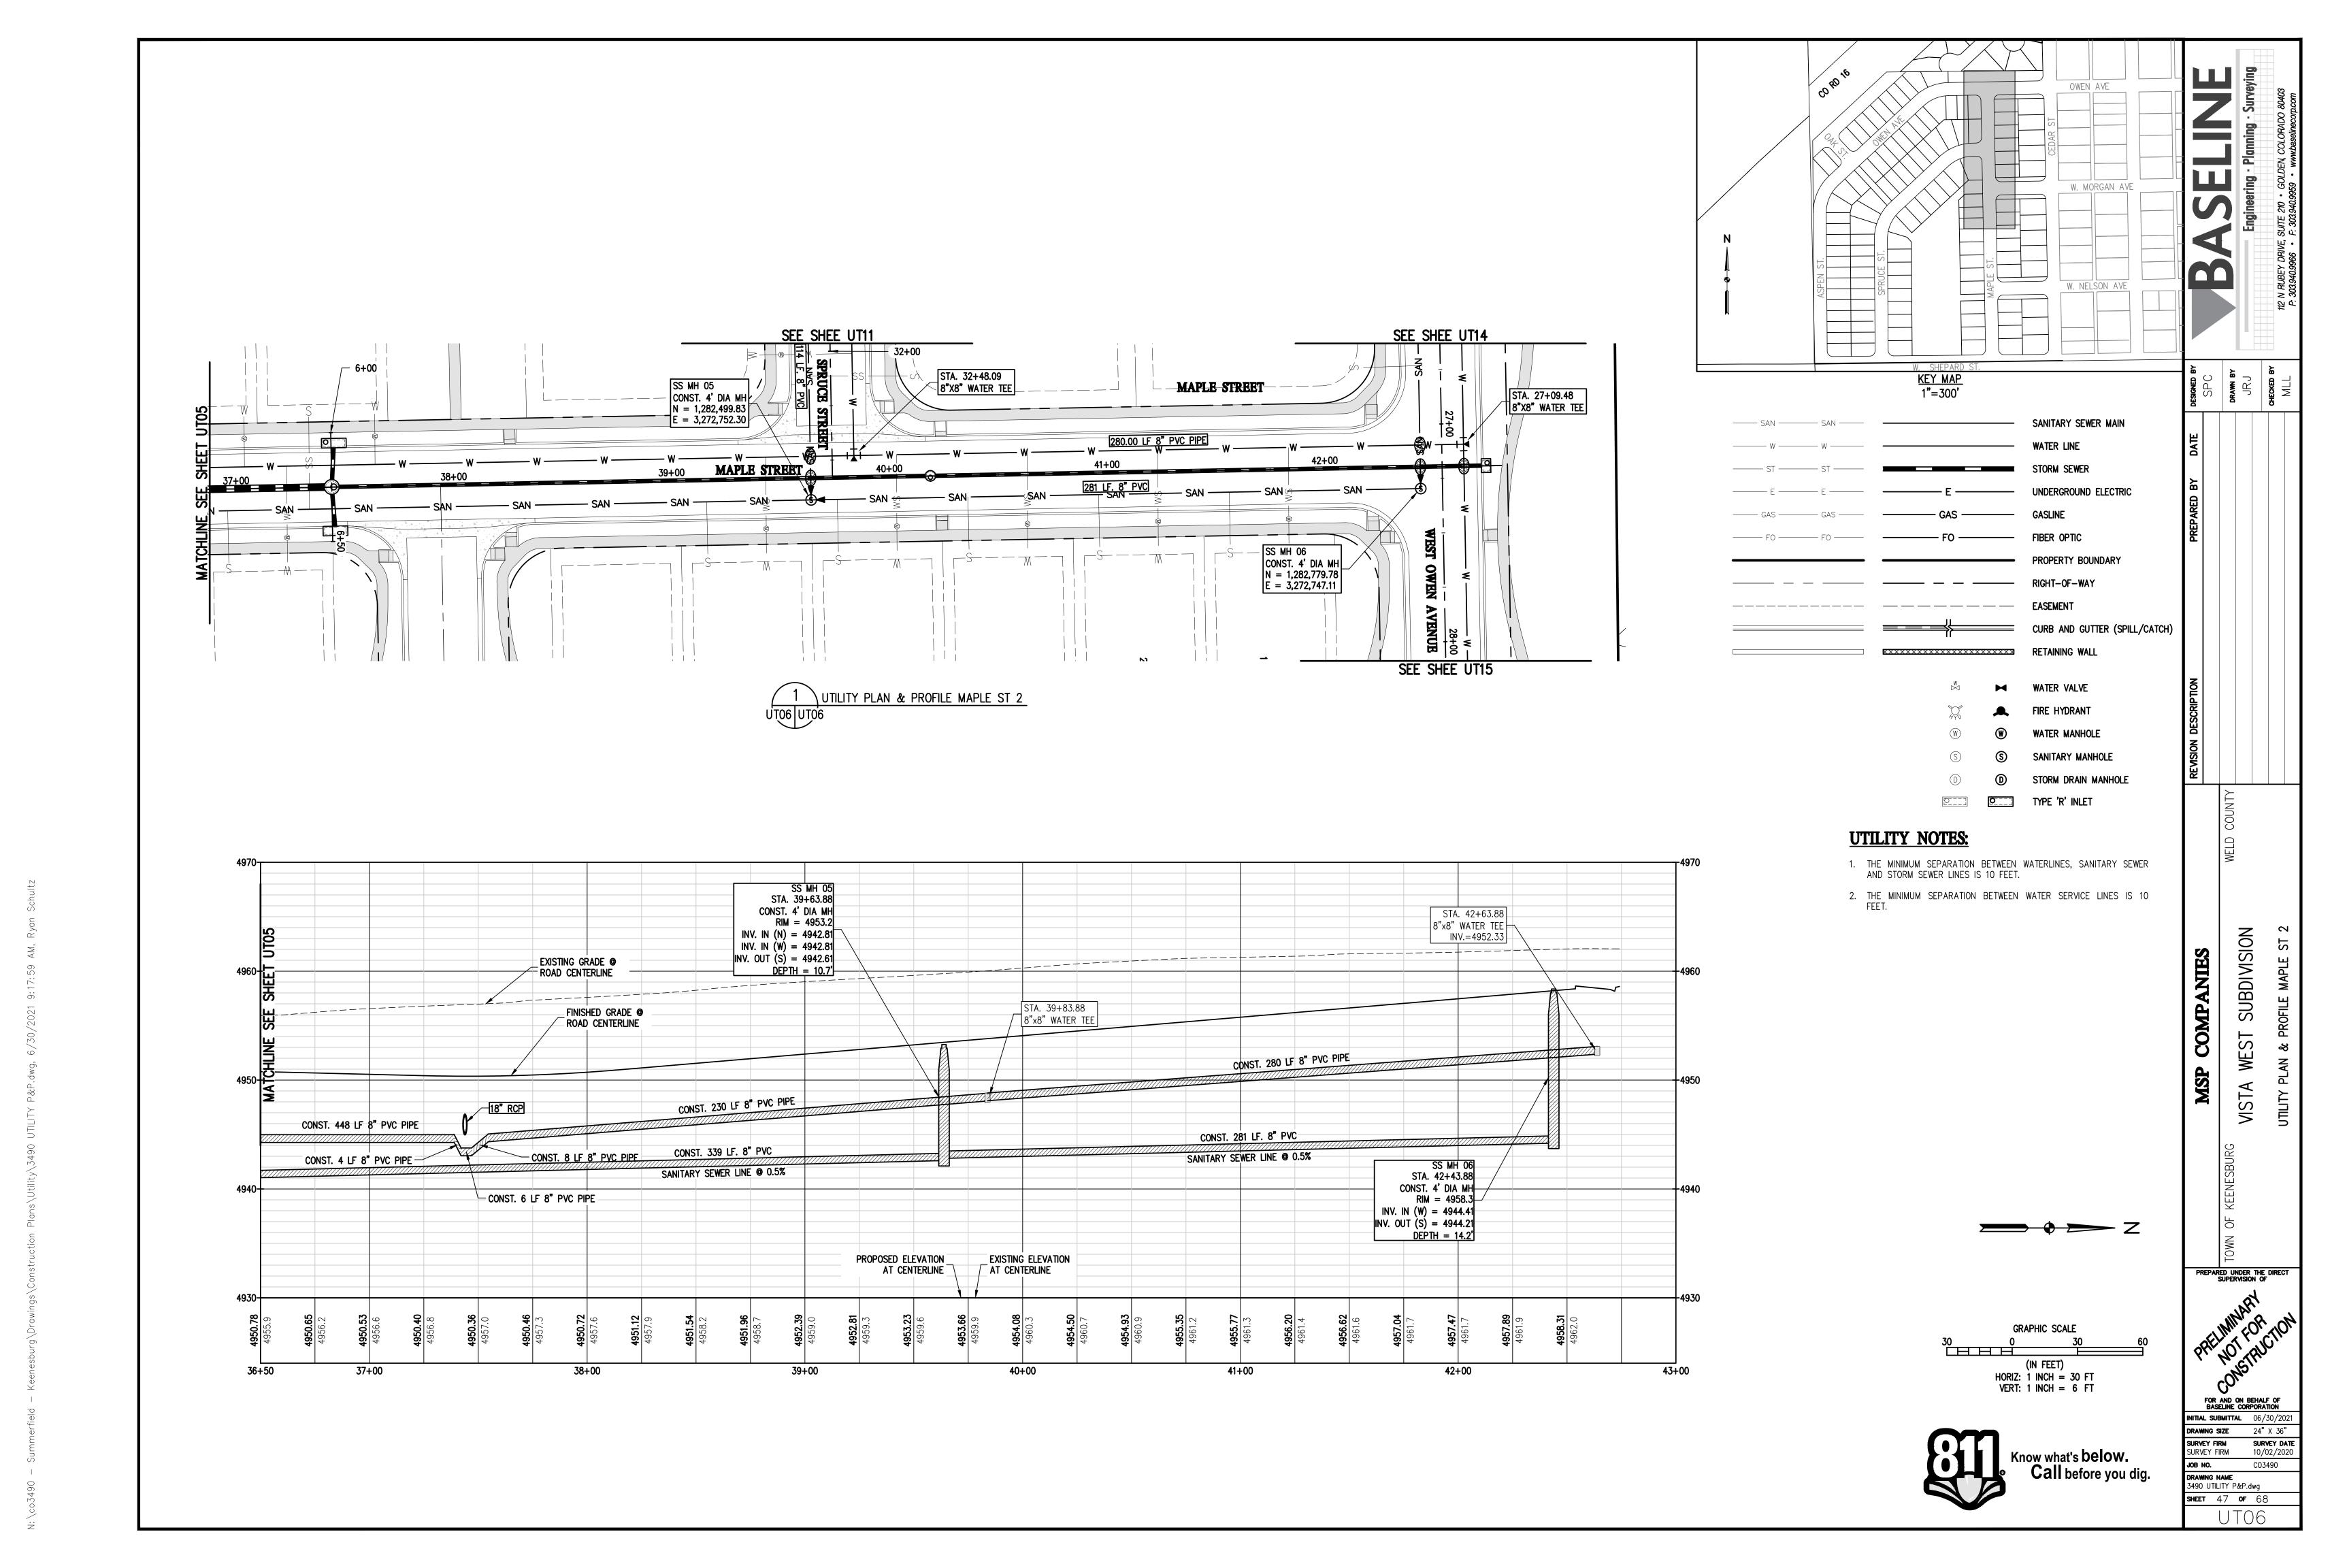



**SHEET** 44 **OF** 68

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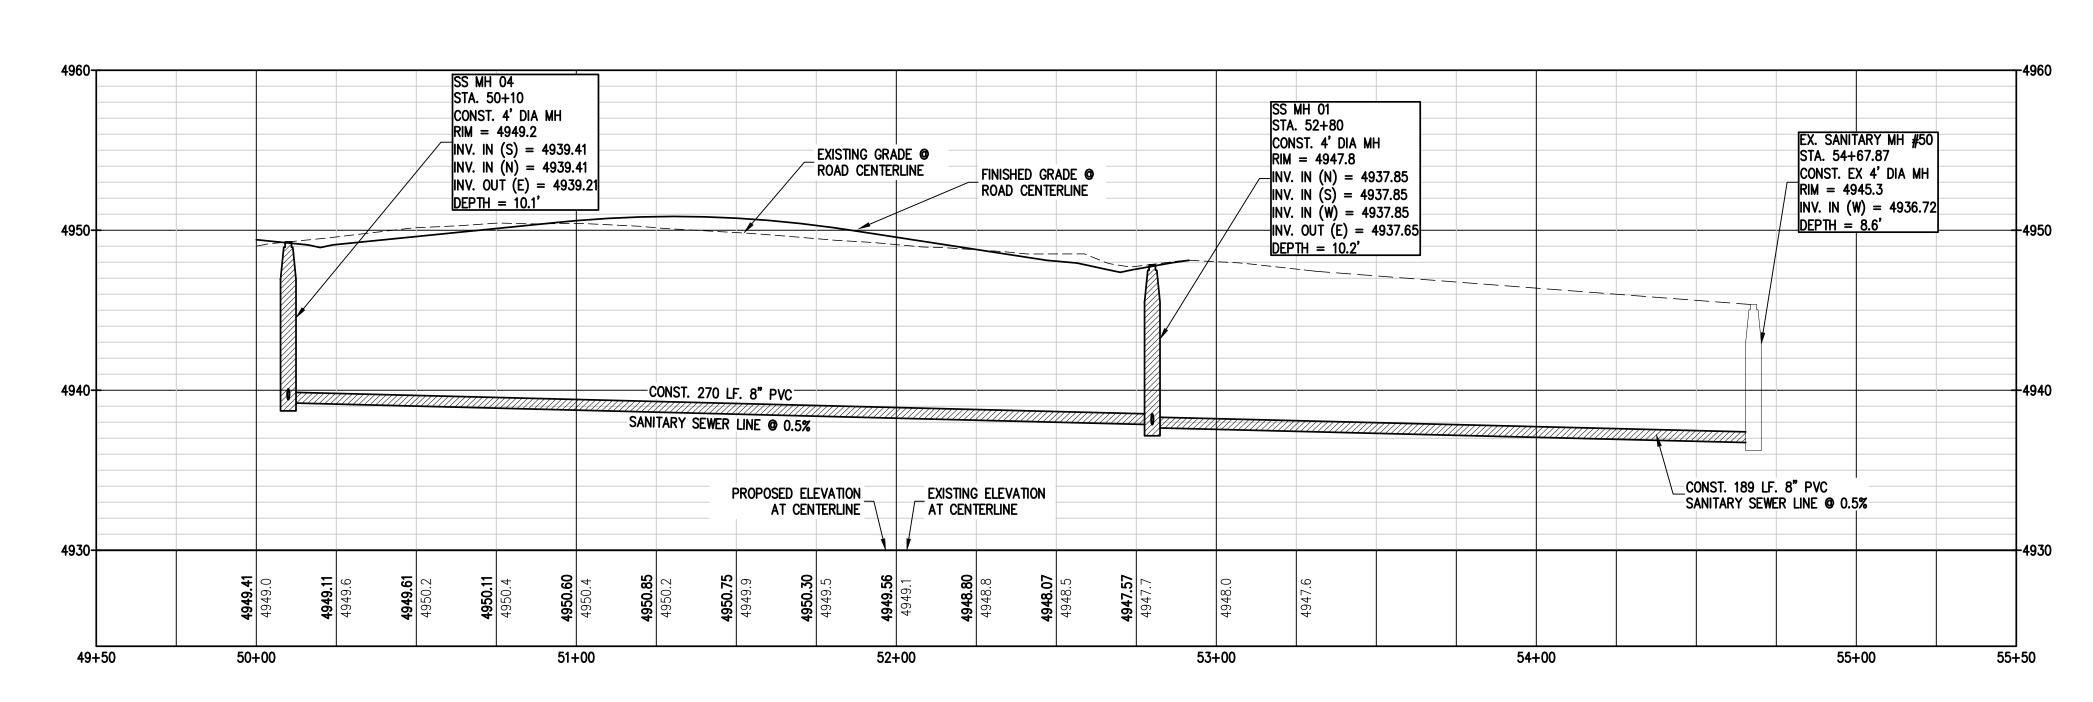



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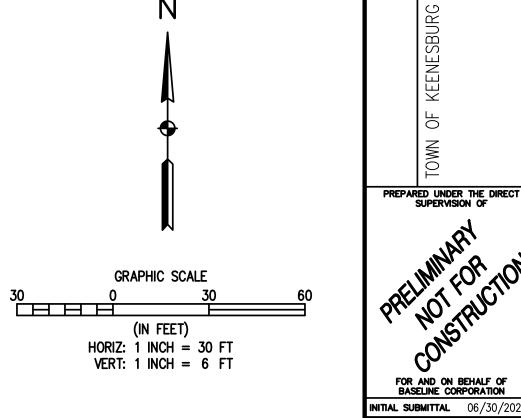




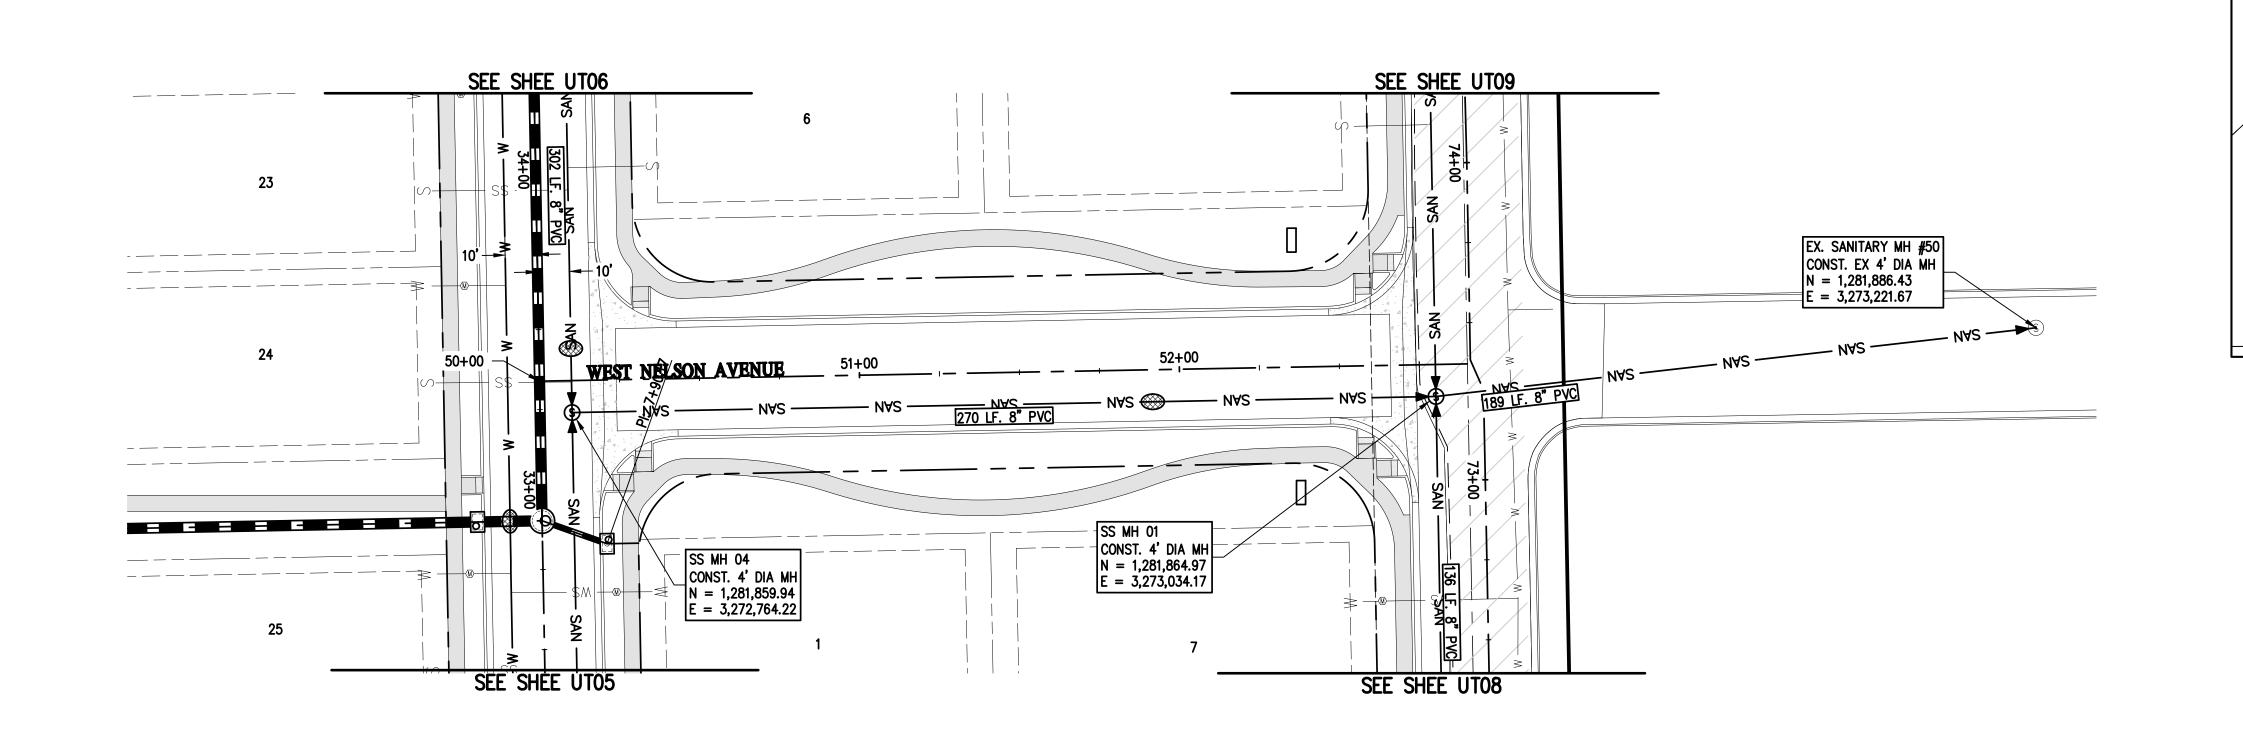

OWEN AVE

W. MORGAN AVE

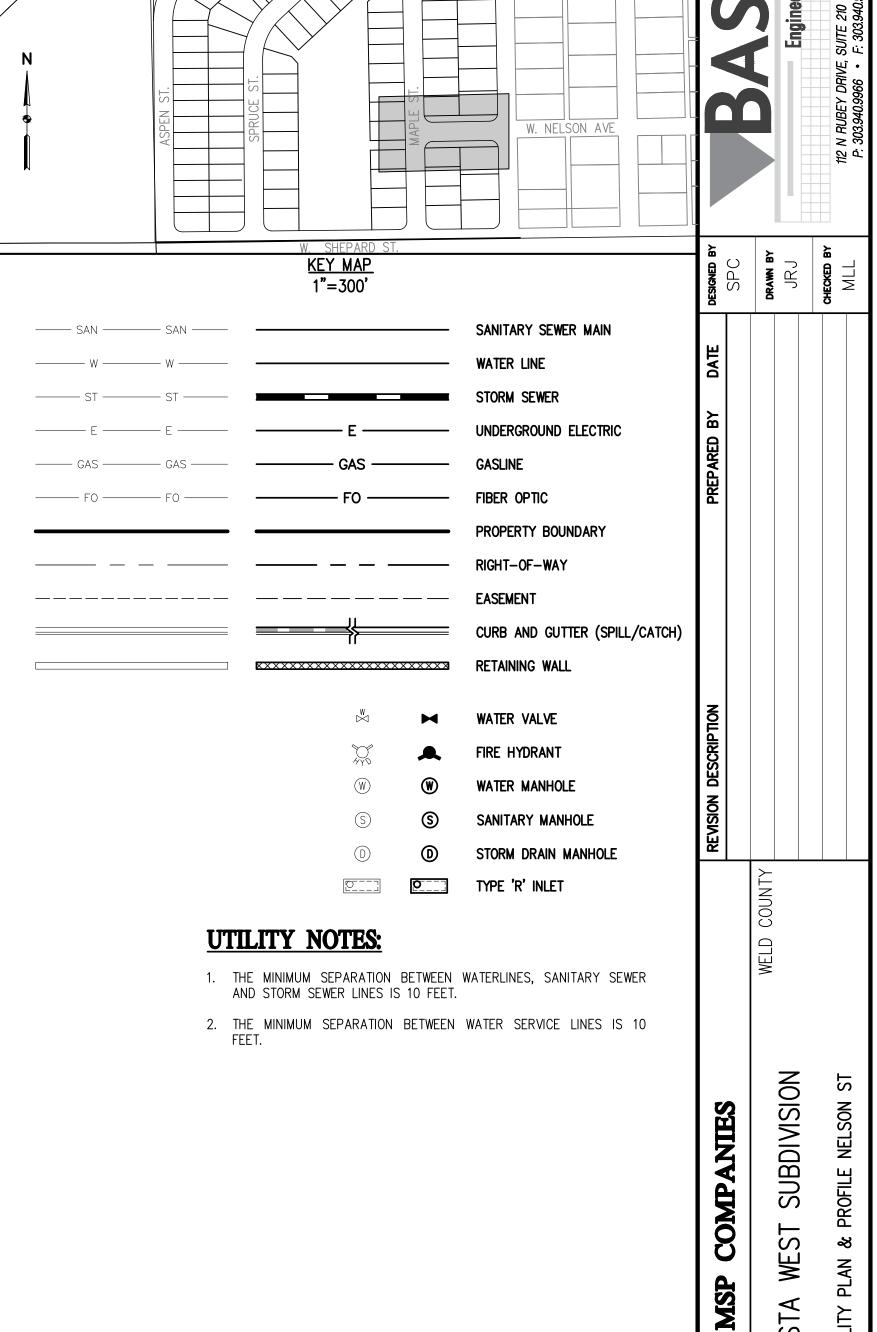

WEST

**MSTA** 

DRAWING SIZE 24" X 36" SURVEY FIRM SURVEY DATE 10/02/2020

CO3490

JOB NO. CO3


DRAWING NAME
3490 UTILITY P&P.dwg

SHEET 48 OF 68







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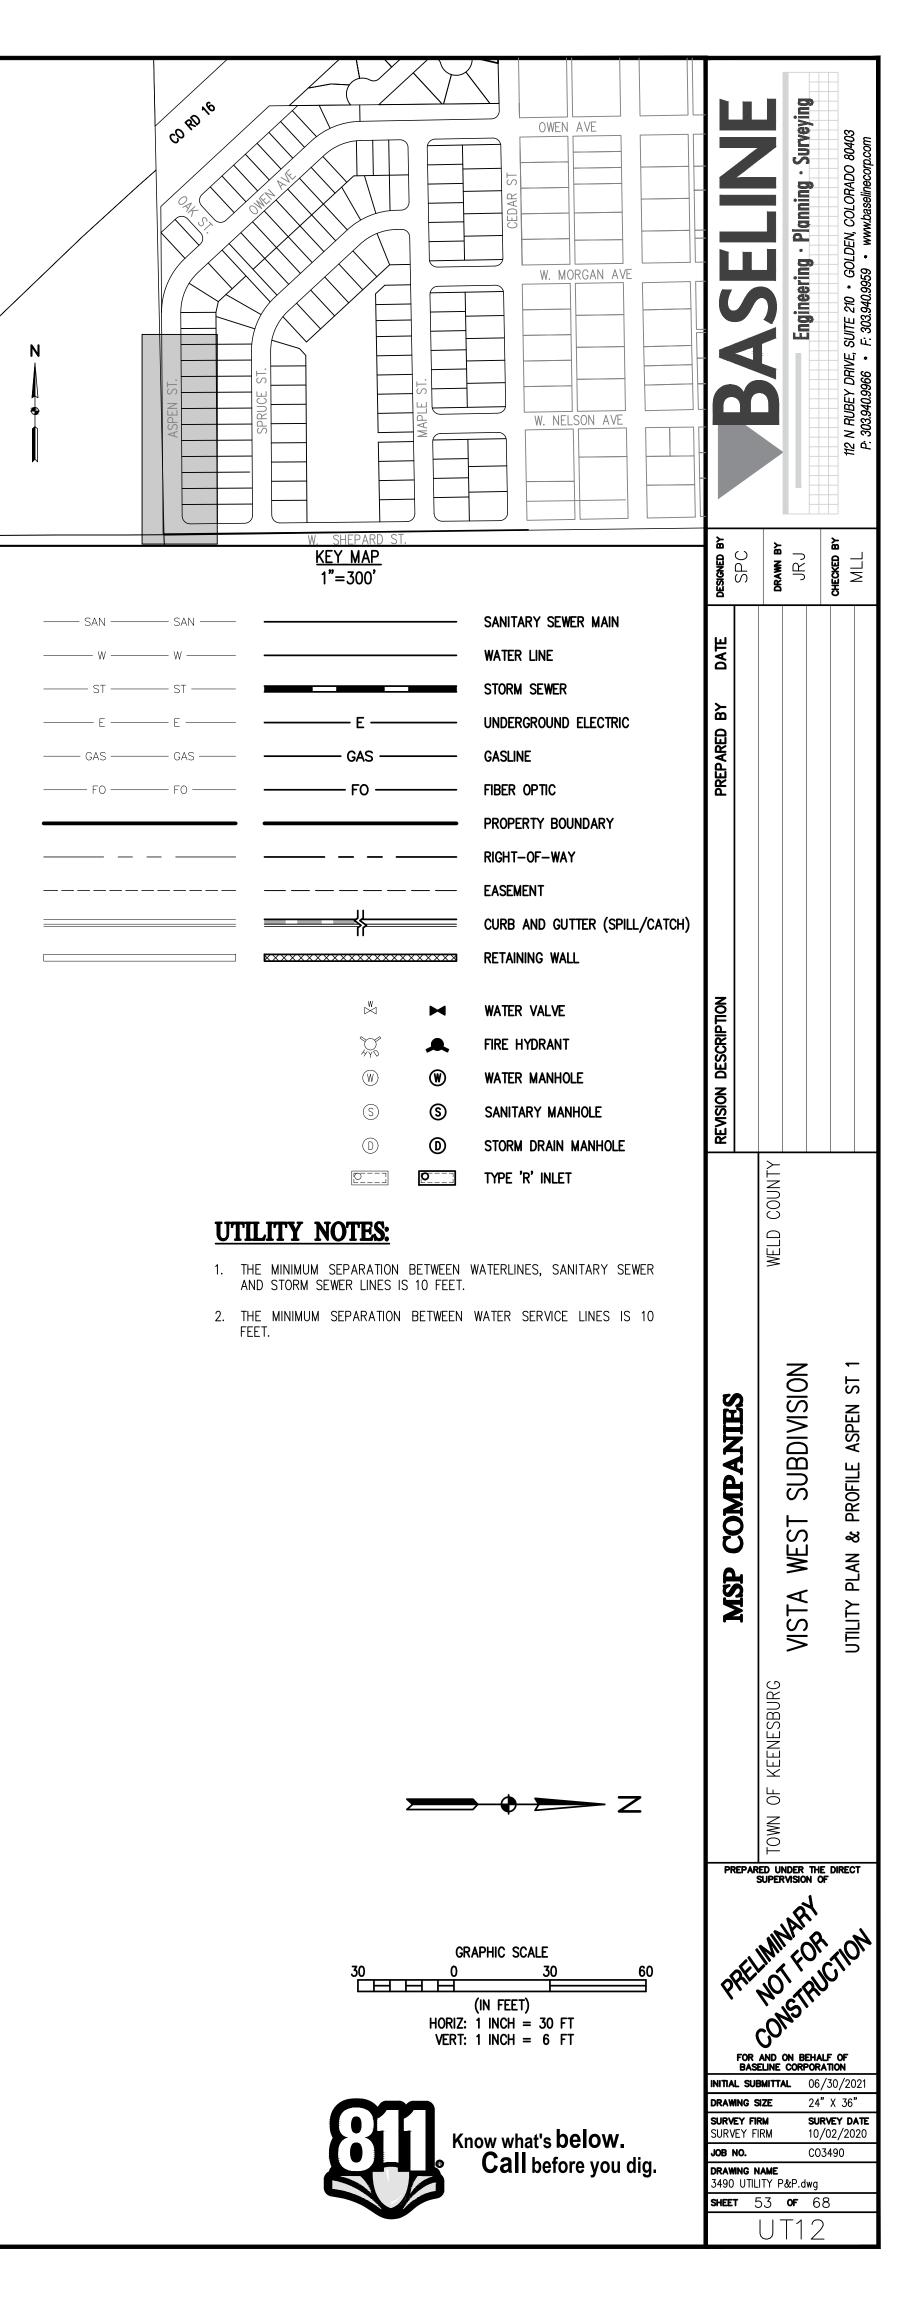

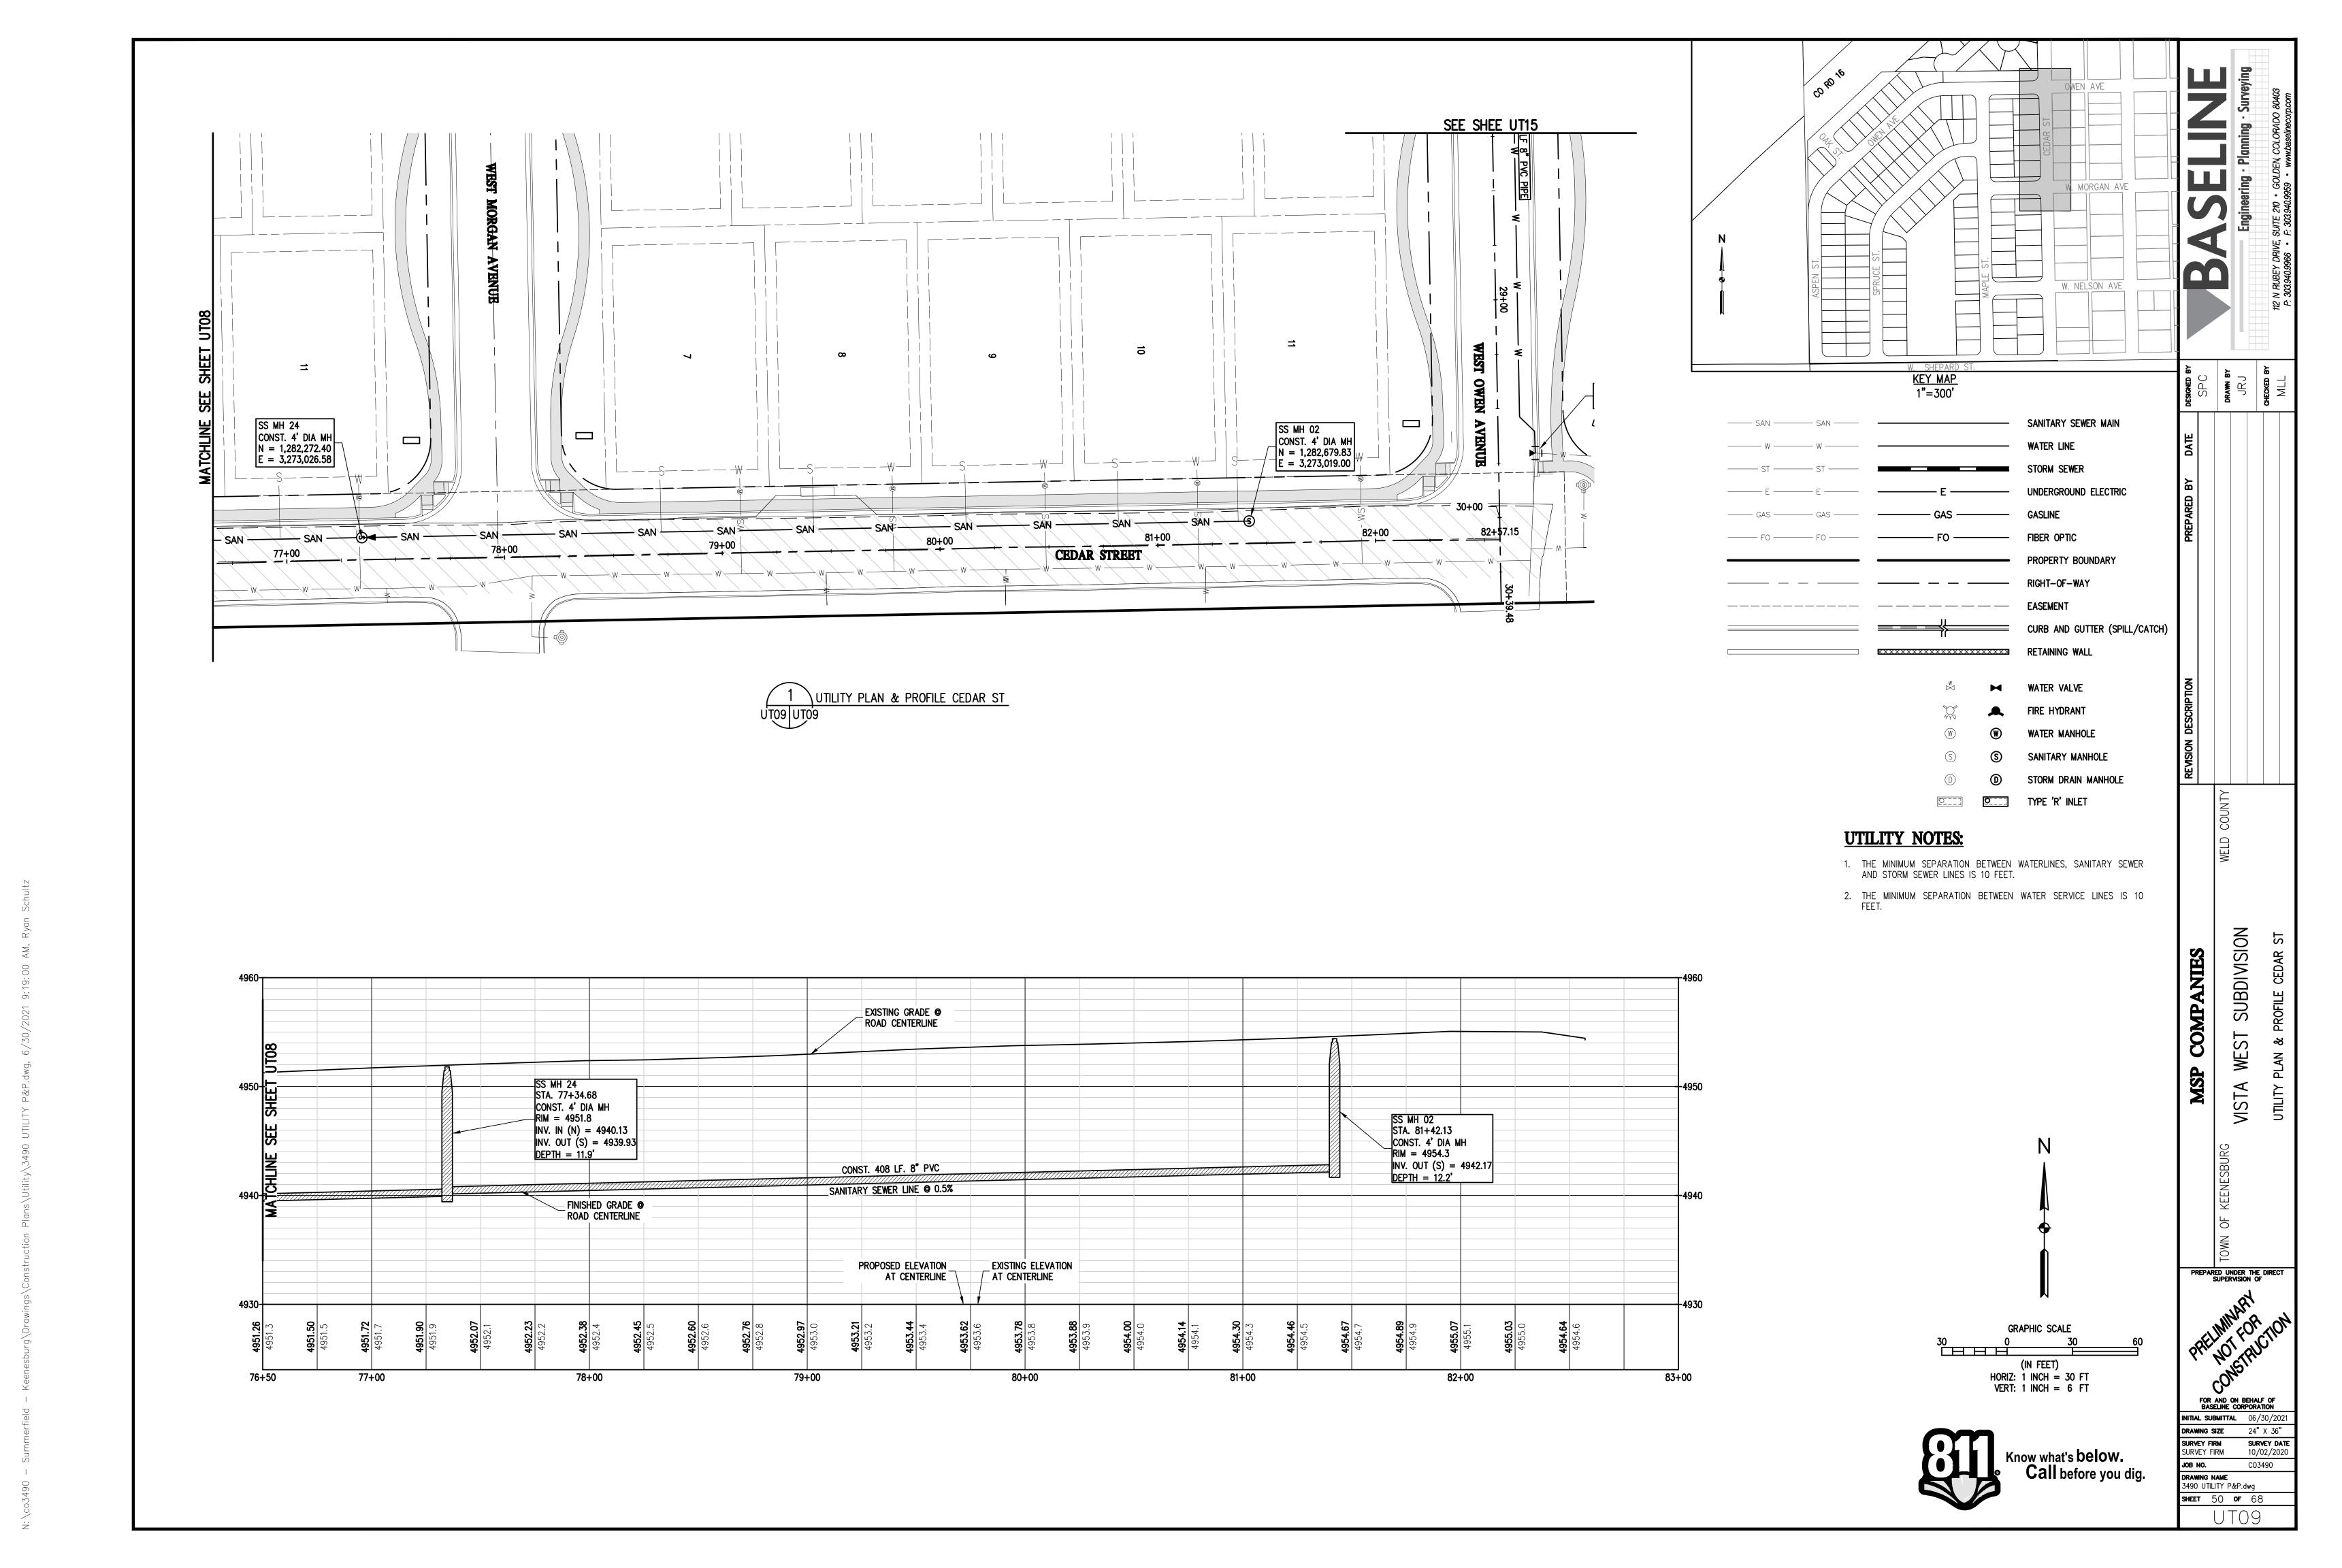
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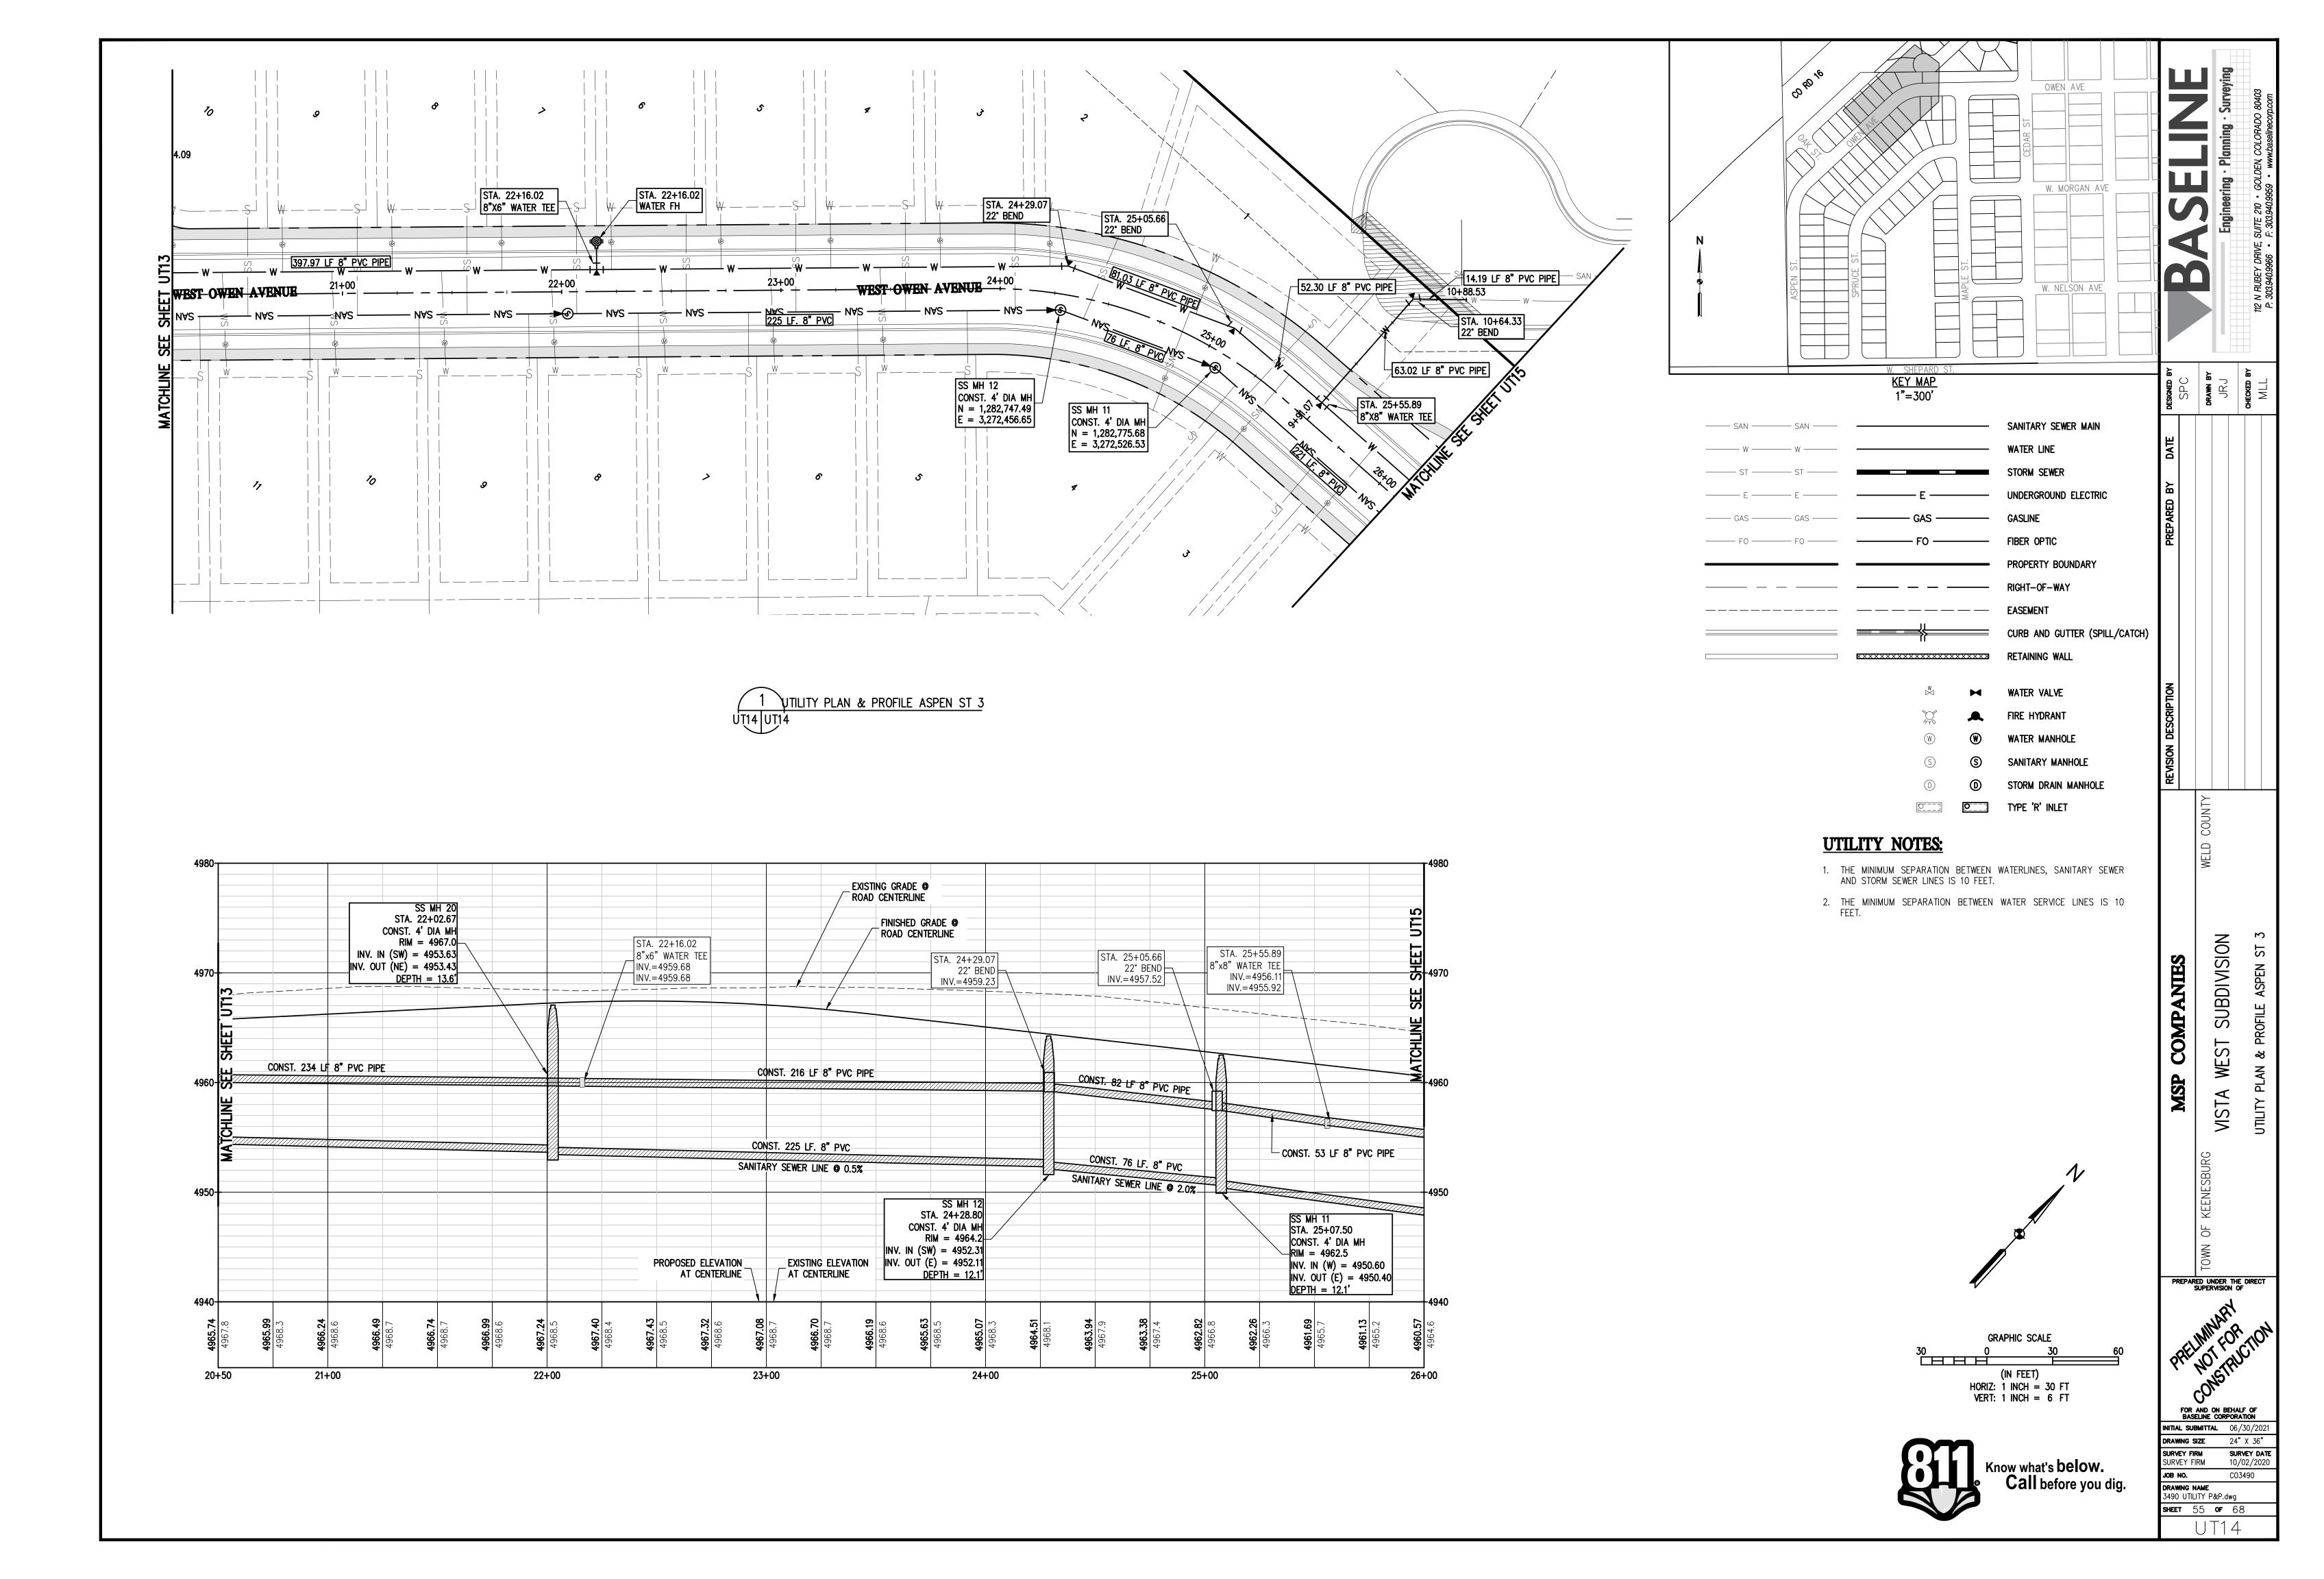
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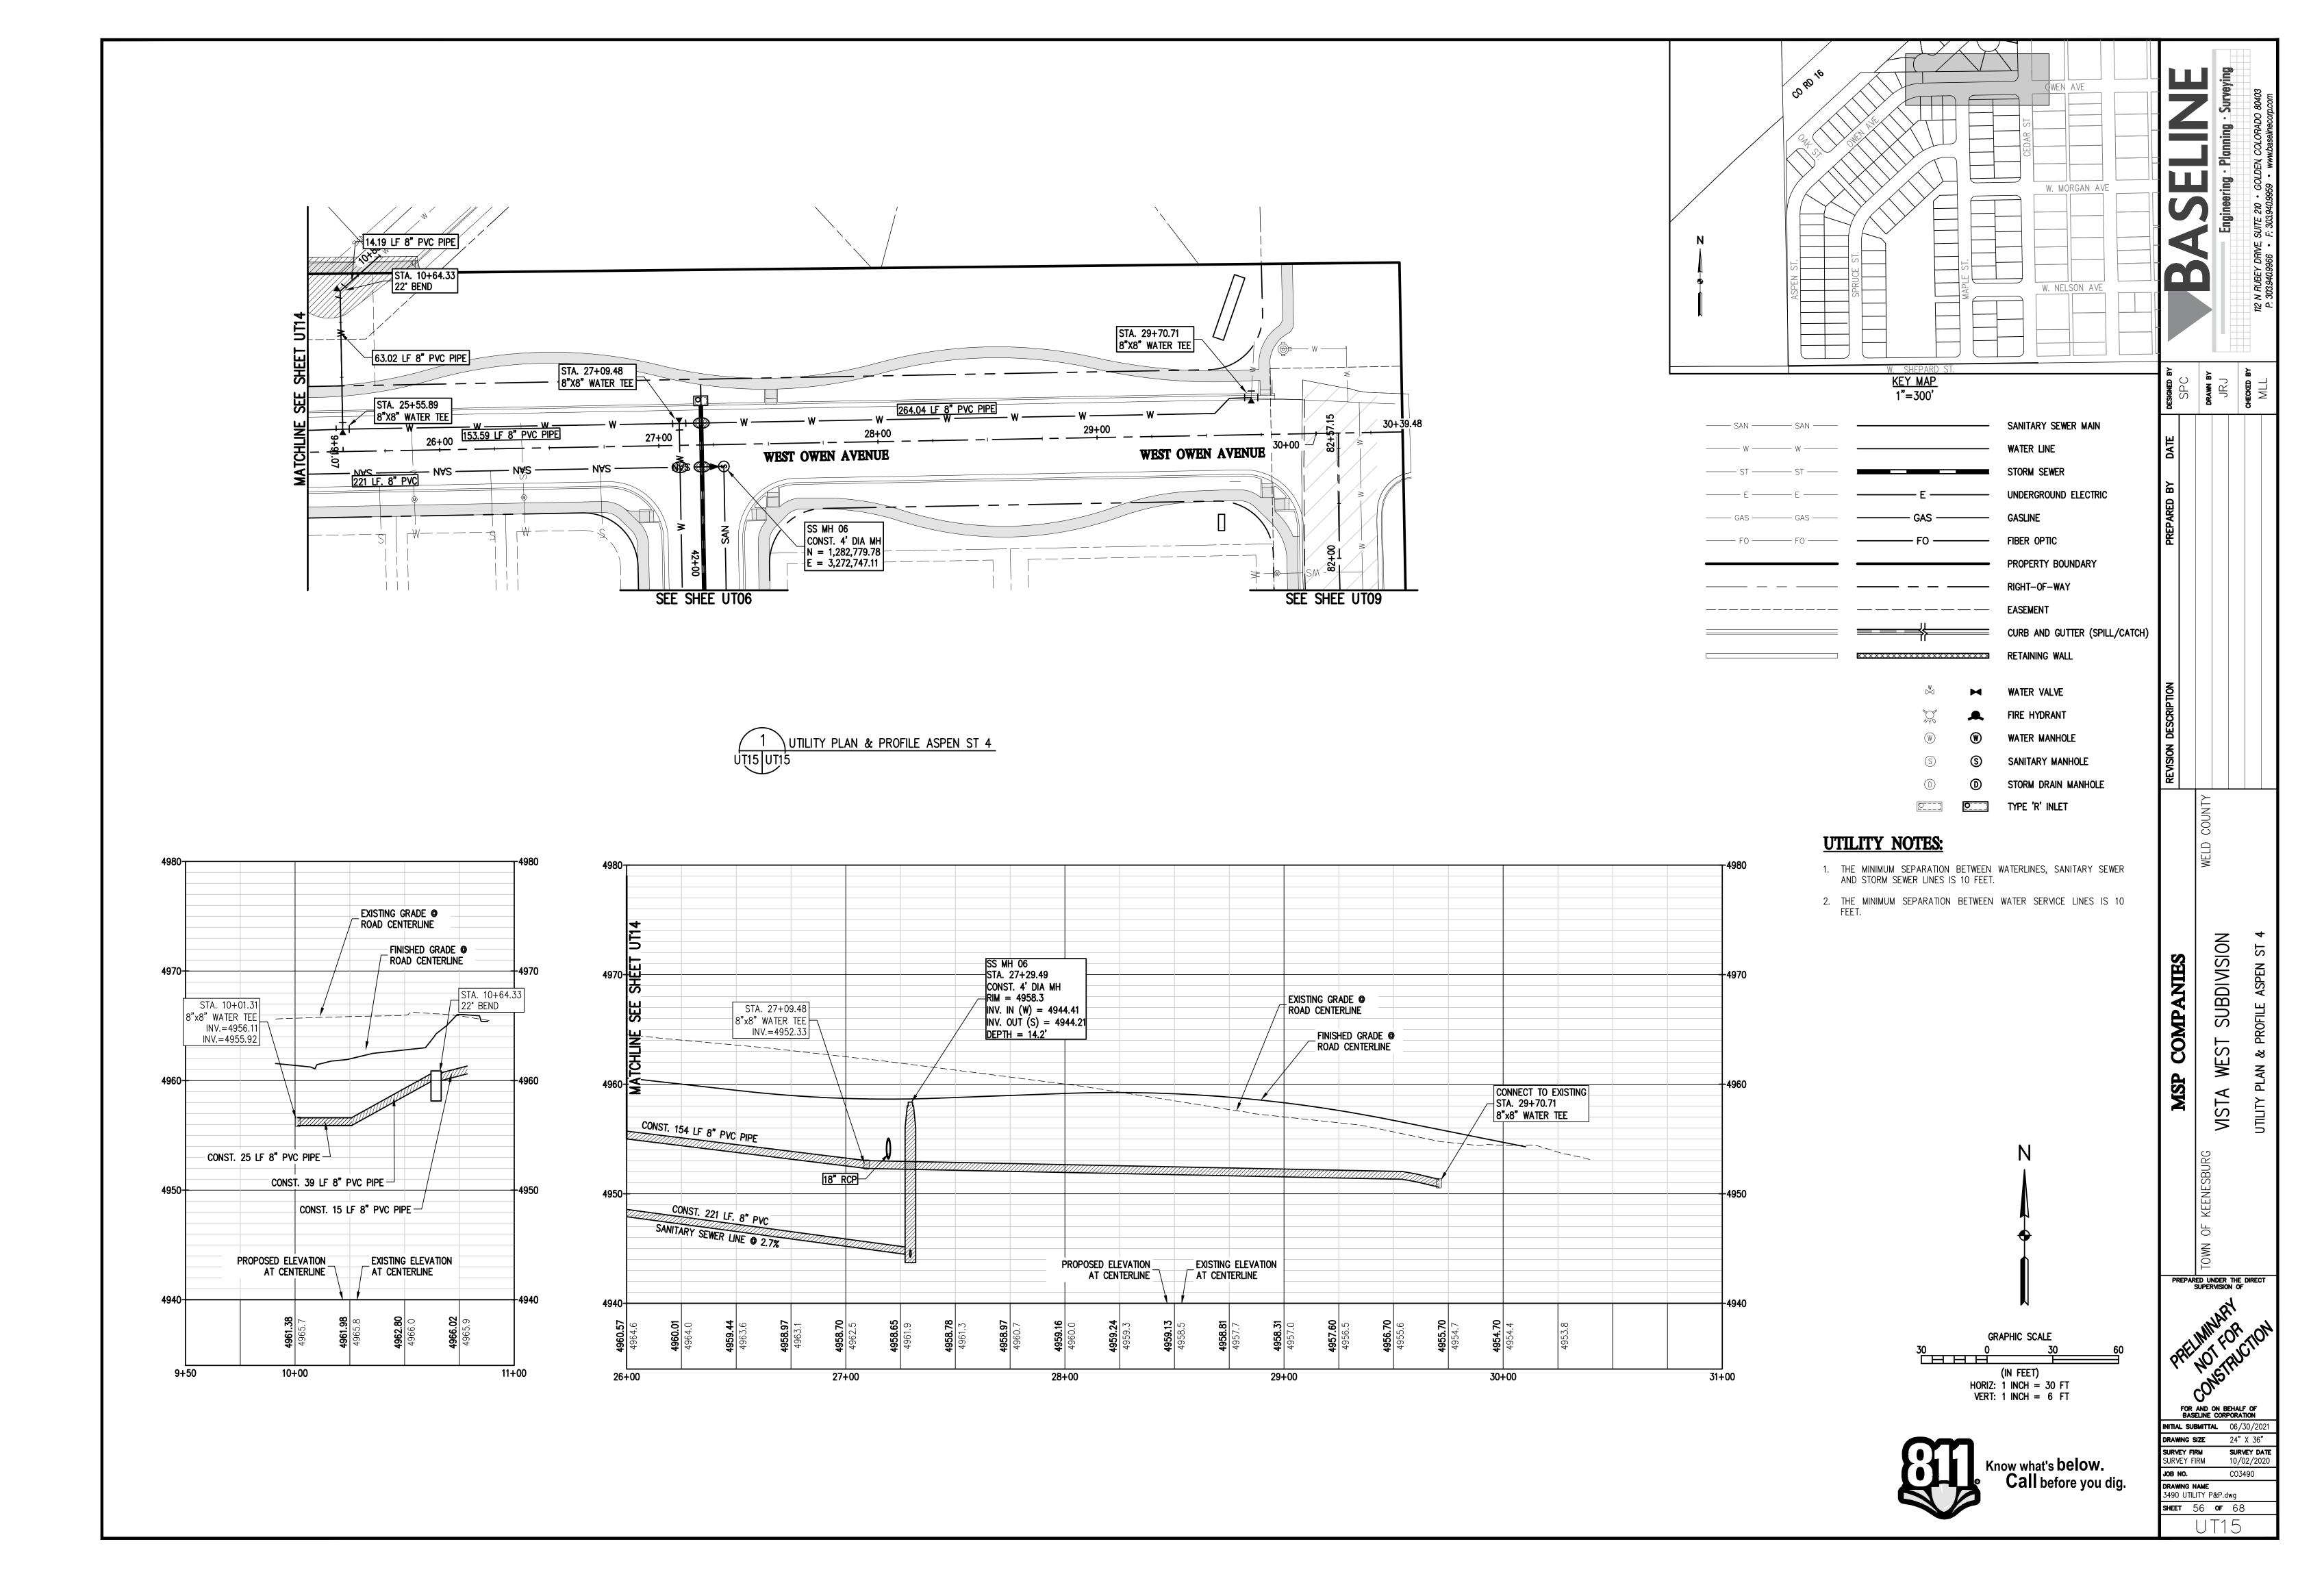


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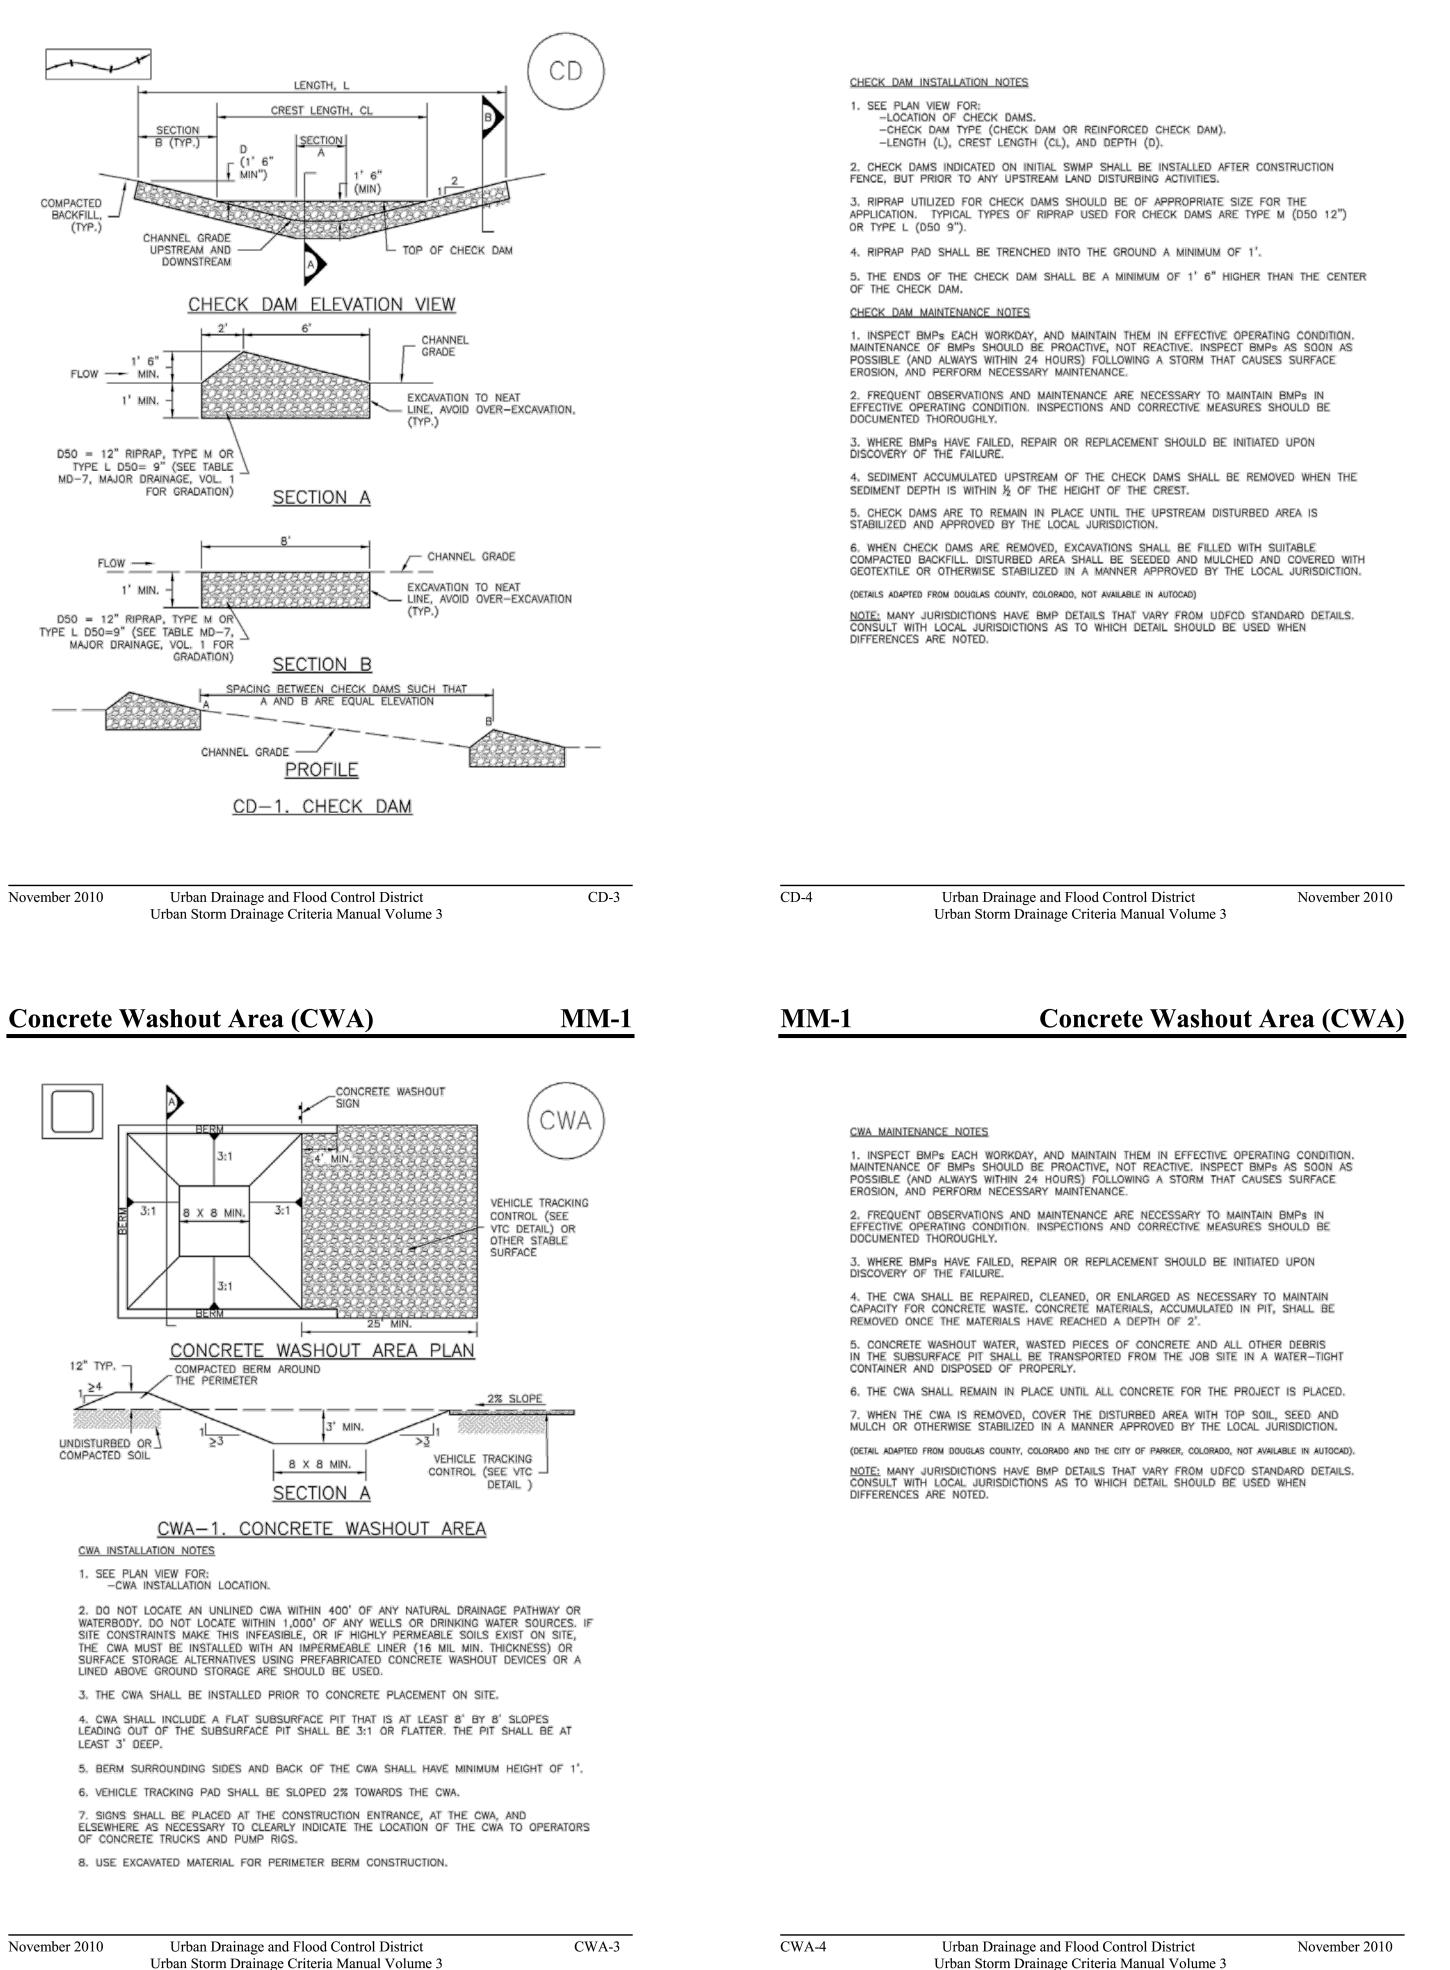

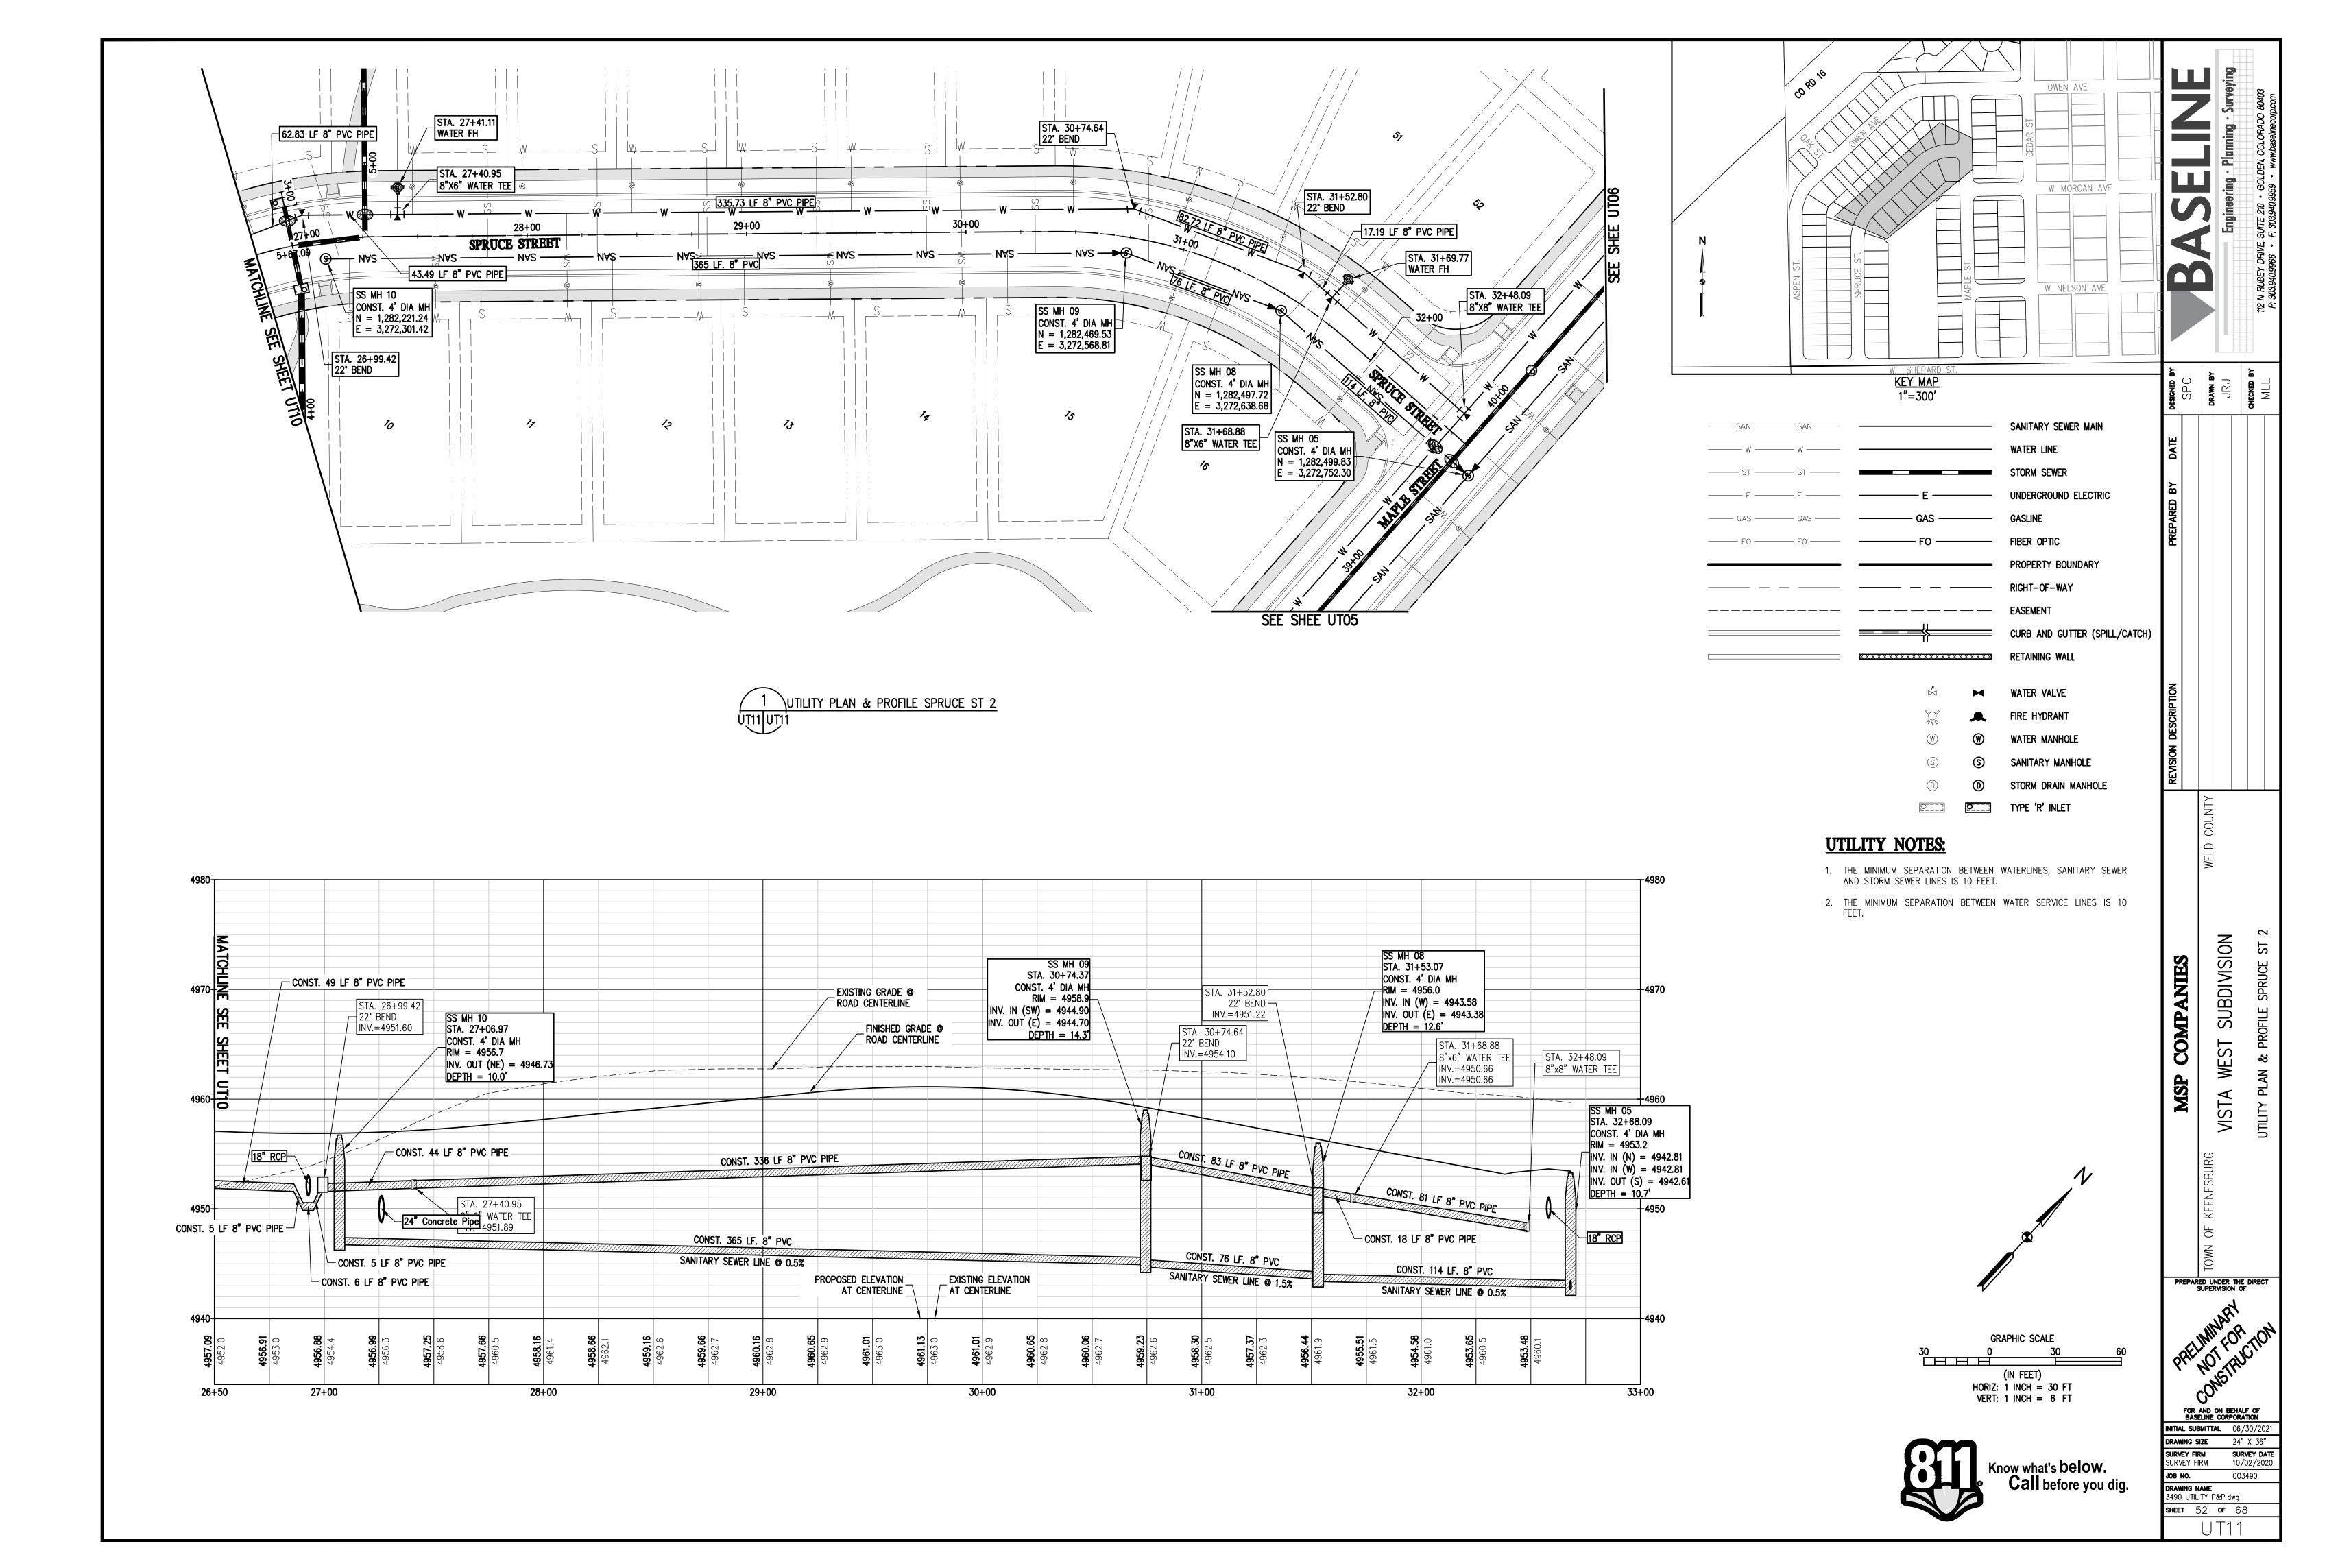
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**Check Dams (CD)** 

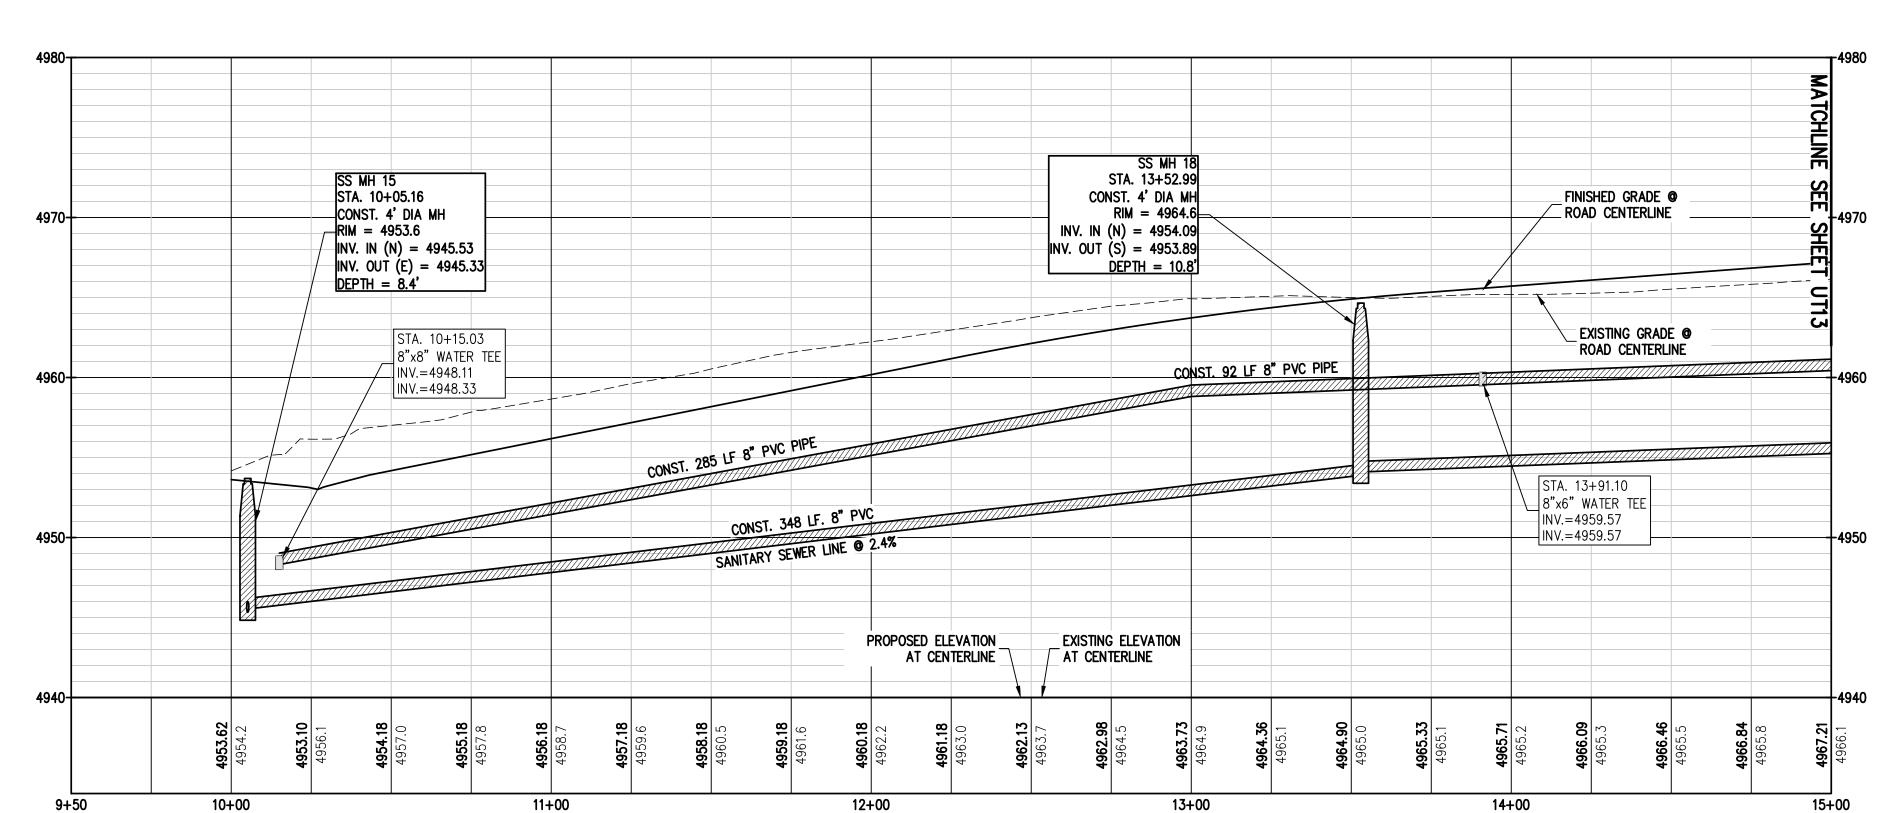


**EC-12** 

**Check Dams (CD)** 

**SM-3** 

**EC-12** 

## **Construction Fence (CF)**

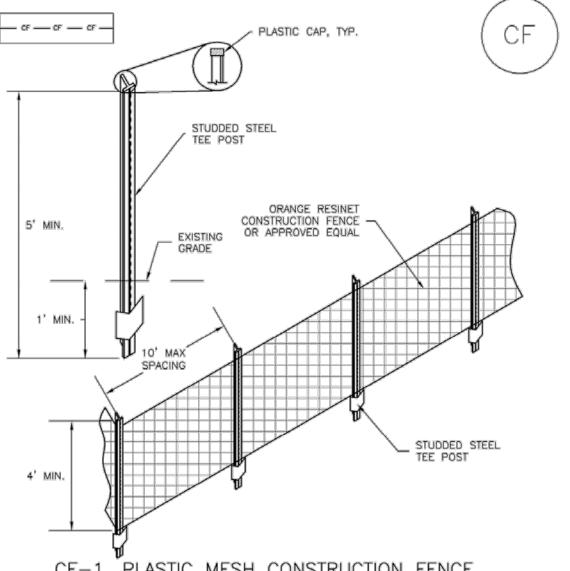

CF-1. PLASTIC MESH CONSTRUCTION FENCE

CONSTRUCTION FENCE INSTALLATION NOTES

1. SEE PLAN VIEW FOR: -LOCATION OF CONSTRUCTION FENCE.

2. CONSTRUCTION FENCE SHOWN SHALL BE INSTALLED PRIOR TO ANY LAND DISTURBING

3. CONSTRUCTION FENCE SHALL BE COMPOSED OF ORANGE, CONTRACTOR-GRADE MATERIAL THAT IS AT LEAST 4' HIGH. METAL POSTS SHOULD HAVE A PLASTIC CAP FOR SAFETY. 4. STUDDED STEEL TEE POSTS SHALL BE UTILIZED TO SUPPORT THE CONSTRUCTION FENCE. MAXIMUM SPACING FOR STEEL TEE POSTS SHALL BE 10'.

5. CONSTRUCTION FENCE SHALL BE SECURELY FASTENED TO THE TOP, MIDDLE, AND BOTTOM OF EACH POST.

Urban Drainage and Flood Control District November 2010 Urban Storm Drainage Criteria Manual Volume 3

STAGGER OVERLAPS

PERIMETER ANCHOR

ECB-3. OUTSIDE OF DRAINAGEWAY

STAKING PATTERNS BY ECB TYPE

OVERLAPPING JOINT

STAKING PATTERN PER

MANUFACTURER SPEC. OR PATTERN

TYPE (SEE STAKING PATTERN DETAIL)

BASED ON ECB AND/OR SLOPE

COCONUT OR EXCELSIOR

2:1 AND STEEPER

000

HIGH FLOW CHANNEL

**Rolled Erosion Control Products (RECP)** 

DIVERSION DITCH

TYPICALLY AT TOP OF

PERIMETER ANCHOR

TRENCH OF JOINT, TYP

**EC-6** 

Urban Drainage and Flood Control District Urban Storm Drainage Criteria Manual Volume 3

#### Rolled Erosion Control Products (RECP) **EC-6**

#### EROSION CONTROL BLANKET INSTALLATION NOTES

SHALL BE RESEEDED AND MULCHED.

SEE PLAN VIEW FOR:

 LOCATION OF ECB.

November 2010

**Construction Fence (CF)** 

DOCUMENTED THOROUGHLY.

DISCOVERY OF THE FAILURE.

DIFFERENCES ARE NOTED.

CONSTRUCTION FENCE MAINTENANCE NOTES

EROSION, AND PERFORM NECESSARY MAINTENANCE.

1. INSPECT BMPs EACH WORKDAY, AND MAINTAIN THEM IN EFFECTIVE OPERATING CONDITION.

POSSIBLE (AND ALWAYS WITHIN 24 HOURS) FOLLOWING A STORM THAT CAUSES SURFACE

2. FREQUENT OBSERVATIONS AND MAINTENANCE ARE NECESSARY TO MAINTAIN BMPs IN EFFECTIVE OPERATING CONDITION. INSPECTIONS AND CORRECTIVE MEASURES SHOULD BE

3. WHERE BMPs HAVE FAILED, REPAIR OR REPLACEMENT SHOULD BE INITIATED UPON

4. CONSTRUCTION FENCE SHALL BE REPAIRED OR REPLACED WHEN THERE ARE SIGNS OF DAMAGE SUCH AS RIPS OR SAGS, CONSTRUCTION FENCE IS TO REMAIN IN PLACE UNTIL THE UPSTREAM DISTURBED AREA IS STABILIZED AND APPROVED BY THE LOCAL JURISDICTION.

5. WHEN CONSTRUCTION FENCES ARE REMOVED, ALL DISTURBED AREAS ASSOCIATED WITH THE

NOTE: MANY JURISDICTIONS HAVE BMP DETAILS THAT VARY FROM UDFCD STANDARD DETAILS. CONSULT WITH LOCAL JURISDICTIONS AS TO WHICH DETAIL SHOULD BE USED WHEN

INSTALLATION, MAINTENANCE, AND/OR REMOVAL OF THE FENCE SHALL BE COVERED WITH

TOPSOIL, SEEDED AND MULCHED, OR OTHERWISE STABILIZED AS APPROVED BY LOCAL

(DETAIL ADAPTED FROM TOWN OF PARKER, COLORADO, NOT AVAILABLE IN AUTOCAD)

MAINTENANCE OF BMPs SHOULD BE PROACTIVE, NOT REACTIVE. INSPECT BMPs AS SOON AS

-TYPE OF ECB (STRAW, STRAW-COCONUT, COCONUT, OR EXCELSIOR). -AREA, A, IN SQUARE YARDS OF EACH TYPE OF ECB.

2. 100% NATURAL AND BIODEGRADABLE MATERIALS ARE PREFERRED FOR RECPS, ALTHOUGH SOME JURISDICTIONS MAY ALLOW OTHER MATERIALS IN SOME APPLICATIONS.

3. IN AREAS WHERE ECBs ARE SHOWN ON THE PLANS, THE PERMITTEE SHALL PLACE TOPSOIL AND PERFORM FINAL GRADING, SURFACE PREPARATION, AND SEEDING AND MULCHING. SUBGRADE SHALL BE SMOOTH AND MOIST PRIOR TO ECB INSTALLATION AND THE ECB SHALL BE IN FULL CONTACT WITH SUBGRADE. NO GAPS OR VOIDS SHALL EXIST UNDER THE

4. PERIMETER ANCHOR TRENCH SHALL BE USED ALONG THE OUTSIDE PERIMETER OF ALL BLANKET AREAS.

5. JOINT ANCHOR TRENCH SHALL BE USED TO JOIN ROLLS OF ECBs TOGETHER (LONGITUDINALLY AND TRANSVERSELY) FOR ALL ECBs EXCEPT STRAW WHICH MAY USE

6. INTERMEDIATE ANCHOR TRENCH SHALL BE USED AT SPACING OF ONE-HALF ROLL LENGTH FOR COCONUT AND EXCELSIOR ECBs.

7. OVERLAPPING JOINT DETAIL SHALL BE USED TO JOIN ROLLS OF ECBs TOGETHER FOR ECBs ON SLOPES.

8. MATERIAL SPECIFICATIONS OF ECBs SHALL CONFORM TO TABLE ECB-1. 9. ANY AREAS OF SEEDING AND MULCHING DISTURBED IN THE PROCESS OF INSTALLING ECBS

10. DETAILS ON DESIGN PLANS FOR MAJOR DRAINAGEWAY STABILIZATION WILL GOVERN IF

DIFFERENT FROM THOSE SHOWN HERE.

Ţ	ABLE ECB-1.	ECB MATERIA	AL SPECIFICAT	IONS
TYPE	COCONUT CONTENT	STRAW CONTENT	EXCELSIOR CONTENT	RECOMMEND NETTING*
STRAW*	=	100%	=	DOUBLE/ NATURAL
STRAW- COCONUT	30% MIN	70% MAX	_	DOUBLE/ NATURAL
COCONUT	100%	_	:	DOUBLE/ NATURAL
EXCELSIOR	_	_	100%	DOUBLE/ NATURAL
STRAW ECBs MAY	ONLY BE USED	OUTSIDE OF STRE	AMS AND DRAINAG	E CHANNEL.

\*\*ALTERNATE NETTING MAY BE ACCEPTABLE IN SOME JURISDICTIONS

NITIAL SUBMITTAL 06/30/20 DRAWING SIZE 24" X 36" SURVEY FIRM SURVEY DAT 10/02/202 SURVEY FIRM

CO3490

**SHEET** 57 **OF** 68

COMPANIES

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SUBDIVIS

November 2010

Urban Drainage and Flood Control District Urban Storm Drainage Criteria Manual Volume 3

STAKING PATTERNS BY SLOPE OR CHANNEL TYPE

4' -

LOW FLOW CHANNEL

Urban Drainage and Flood Control District Urban Storm Drainage Criteria Manual Volume 3 November 2010 JOB NO. DRAWING NAME 3490-Cover, Notes, & Details.dv

**SM-3** 

CF-3

Urban Storm Drainage Criteria Manual Volume 3

RECP-7

RECP-8

**GEOTEXTILE** 

COMPACTED

FLOW \_\_\_\_

AT LEAST 10"

OF SILT FENCE

"TAIL" SHALL BE

POSTS SHALL BE JOINED AS

SHOWN, THEN ROTATED 180 DEG

IN DIRECTION SHOWN AND DRIVEN

INTO THE GROUND

BURIED

GROUND

— SF —— SF —— SF —

**SM-6** 

SF-3

DRAWING SIZE 24" X 36" SURVEY FIRM SURVEY DAT 10/02/202 SURVEY FIRM

CO3490 JOB NO. DRAWING NAME 3490—Cover, Notes, & Details.dv

EROSION CONTROL BLANKET MAINTENANCE NOTES

RESEEDED AND MULCHED AND THE ECB REINSTALLED.

1. INSPECT BMPs EACH WORKDAY, AND MAINTAIN THEM IN EFFECTIVE OPERATING CONDITION. MAINTENANCE OF BMPs SHOULD BE PROACTIVE, NOT REACTIVE. INSPECT BMPs AS SOON AS POSSIBLE (AND ALWAYS WITHIN 24 HOURS) FOLLOWING A STORM THAT CAUSES SURFACE EROSION, AND PERFORM NECESSARY MAINTENANCE.

2. FREQUENT OBSERVATIONS AND MAINTENANCE ARE NECESSARY TO MAINTAIN BMPs IN EFFECTIVE OPERATING CONDITION. INSPECTIONS AND CORRECTIVE MEASURES SHOULD BE DOCUMENTED THOROUGHLY.

3. WHERE BMPs HAVE FAILED, REPAIR OR REPLACEMENT SHOULD BE INITIATED UPON DISCOVERY OF THE FAILURE.

REMOVED BY THE LOCAL JURISDICTION. 5. ANY ECB PULLED OUT, TORN, OR OTHERWISE DAMAGED SHALL BE REPAIRED OR REINSTALLED. ANY SUBGRADE AREAS BELOW THE GEOTEXTILE THAT HAVE ERODED TO CREATED A VOID UNDER THE BLANKET, OR THAT REMAIN DEVOID OF GRASS SHALL BE REPAIRED,

4. ECBs SHALL BE LEFT IN PLACE TO EVENTUALLY BIODEGRADE, UNLESS REQUESTED TO BE

MANY JURISDICTIONS HAVE BMP DETAILS THAT VARY FROM UDFCD STANDARD DETAILS. NOTE: MANY JURISDICTIONS HAVE BMP DETAILS THAT YOUR SHOULD BE USED WHEN DIFFERENCES ARE NOTED.

(DETAILS ADAPTED FROM DOUGLAS COUNTY, COLORADO AND TOWN OF PARKER COLORADO, NOT AVAILABLE IN AUTOCAD)

1½" (MINUS) CRUSHED ROCK ENCLOSED IN WIRE MESH 1½" (MINUS) CRUSHED ROCK ENCLOSED IN WIRE MESH WIRE TIE ENDS 4" TO 6" MAX AT CURBS, OTHERWISE GROUND SURFACE O" ON BEDROCK OR - 6"-10" DEPENDING HARD SURFACE, 2" IN SOIL SEDIMENT LOADS

ANY GAP AT JOINT SHALL BE FILLED WITH AN ADEQUATE AMOUNT OF 11/2" (MINUS) CRUSHED ROCK AND WRAPPED WITH ADDITIONAL WIRE MESH SECURED TO ENDS OF ROCK ROCK SOCK, REINFORCED SOCK. AS AN ALTERNATIVE TO FILLING JOINTS BETWEEN ADJOINING ROCK SOCKS WITH CRUSHED ROCK AND ADDITIONAL WIRE WRAPPING, ROCK SOCKS CAN BE OVERLAPPED (TYPICALLY 12-INCH OVERLAP) TO AVOID GAPS. GRADATION TABLE

SIEVE SIZE MASS PERCENT PASSING SQUARE MESH SIEVES ROCK SOCK JOINTING

ROCK SOCK INSTALLATION NOTES 1. SEE PLAN VIEW FOR: -LOCATION(S) OF ROCK SOCKS.

ROCK SOCK SECTION

MATCHES SPECIFICATIONS FOR NO. 4 COARSE AGGREGATE FOR CONCRETE PER AASHTO M43. ALL ROCK SHALL BE FRACTURED FACE, ALL SIDES.

NO. 4

20 - 55

ROCK SOCK PLAN

2. CRUSHED ROCK SHALL BE 1½" (MINUS) IN SIZE WITH A FRACTURED FACE (ALL SIDES) AND SHALL COMPLY WITH GRADATION SHOWN ON THIS SHEET (11/2" MINUS). 3. WIRE MESH SHALL BE FABRICATED OF 10 GAGE POULTRY MESH, OR EQUIVALENT, WITH A

MAXIMUM OPENING OF 1/2", RECOMMENDED MINIMUM ROLL WIDTH OF 48" 4. WIRE MESH SHALL BE SECURED USING "HOG RINGS" OR WIRE TIES AT 6" CENTERS

ALONG ALL JOINTS AND AT 2" CENTERS ON ENDS OF SOCKS. 5. SOME MUNICIPALITIES MAY ALLOW THE USE OF FILTER FABRIC AS AN ALTERNATIVE TO WIRE

RS-1. ROCK SOCK PERIMETER CONTROL

November 2010

**MM-2** 

Rock Sock (RS)

ROCK SOCK MAINTENANCE NOTES

DOCUMENTED THOROUGHLY.

DISCOVERY OF THE FAILURE.

DIFFERENCES ARE NOTED.

IN THE MANUFACTURER'S DETAILS.

EROSION, AND PERFORM NECESSARY MAINTENANCE

IS APPROXIMATELY 1/2 OF THE HEIGHT OF THE ROCK SOCK.

STABILIZED AND APPROVED BY THE LOCAL JURISDICTION.

1. INSPECT BMPs EACH WORKDAY, AND MAINTAIN THEM IN EFFECTIVE OPERATING CONDITION. MAINTENANCE OF BMPs SHOULD BE PROACTIVE, NOT REACTIVE. INSPECT BMPs AS SOON AS

POSSIBLE (AND ALWAYS WITHIN 24 HOURS) FOLLOWING A STORM THAT CAUSES SURFACE

2. FREQUENT OBSERVATIONS AND MAINTENANCE ARE NECESSARY TO MAINTAIN BMPs IN

3. WHERE BMPs HAVE FAILED, REPAIR OR REPLACEMENT SHOULD BE INITIATED UPON

4. ROCK SOCKS SHALL BE REPLACED IF THEY BECOME HEAVILY SOILED, OR DAMAGED

6. ROCK SOCKS ARE TO REMAIN IN PLACE UNTIL THE UPSTREAM DISTURBED AREA IS

7. WHEN ROCK SOCKS ARE REMOVED, ALL DISTURBED AREAS SHALL BE COVERED WITH

(DETAIL ADAPTED FROM TOWN OF PARKER, COLORADO AND CITY OF AURORA, COLORADO, NOT AVAILABLE IN AUTOCAD)

NOTE: MANY JURISDICTIONS HAVE BMP DETAILS THAT VARY FROM UDFCD STANDARD DETAILS. CONSULT WITH LOCAL JURISDICTIONS AS TO WHICH DETAIL SHOULD BE USED WHEN

NOTE: THE DETAILS INCLUDED WITH THIS FACT SHEET SHOW COMMONLY USED, CONVENTIONAL METHODS OF ROCK SOCK INSTALLATION IN THE DENVER METROPOLITAN AREA. THERE ARE

MANY OTHER SIMILAR PROPRIETARY PRODUCTS ON THE MARKET. UDFCD NEITHER NDORSES NOR DISCOURAGES USE OF PROPRIETARY PROTECTION PRODUCTS; HOWEVER, IN THE EVENT PROPRIETARY METHODS ARE USED, THE APPROPRIATE DETAIL FROM THE MANUFACTURER MUST BE INCLUDED IN THE SWMP AND THE BMP MUST BE INSTALLED AND MAINTAINED AS SHOWN

TOPSOIL, SEEDED AND MULCHED OR OTHERWISE STABILIZED AS APPROVED BY LOCAL

5. SEDIMENT ACCUMULATED UPSTREAM OF ROCK SOCKS SHALL BE REMOVED AS NEEDED TO

MAINTAIN FUNCTIONALITY OF THE BMP, TYPICALLY WHEN DEPTH OF ACCUMULATED SEDIMENTS

EFFECTIVE OPERATING CONDITION. INSPECTIONS AND CORRECTIVE MEASURES SHOULD BE

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SILT FENCE

SECTION A

SF-1. SILT FENCE

1 ½" x 1 ½"

SPACING

(RECOMMENDED) WOODEN

FENCE POST WITH 10' MAX

POSTS SHALL OVERLAP AT JOINTS SO THAT NO GAPS 7 EXIST IN SILT FENCE/

THICKNESS OF GEOTEXTILE HAS

BEEN EXAGGERATED. TY

November 2010

Silt Fence (SF)

RECP-9

SILT FENCE INSTALLATION NOTES

1. SILT FENCE MUST BE PLACED AWAY FROM THE TOE OF THE SLOPE TO ALLOW FOR WATER PONDING. SILT FENCE AT THE TOE OF A SLOPE SHOULD BE INSTALLED IN A FLAT LOCATION AT LEAST SEVERAL FEET (2-5 FT) FROM THE TOE OF THE SLOPE TO ALLOW ROOM FOR

Urban Drainage and Flood Control District

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2. A UNIFORM 6" X 4" ANCHOR TRENCH SHALL BE EXCAVATED USING TRENCHER OR SILT FENCE INSTALLATION DEVICE. NO ROAD GRADERS, BACKHOES, OR SIMILAR EQUIPMENT SHALL

3. COMPACT ANCHOR TRENCH BY HAND WITH A "JUMPING JACK" OR BY WHEEL ROLLING. COMPACTION SHALL BE SUCH THAT SILT FENCE RESISTS BEING PULLED OUT OF ANCHOR

4. SILT FENCE SHALL BE PULLED TIGHT AS IT IS ANCHORED TO THE STAKES, THERE SHOULD BE NO NOTICEABLE SAG BETWEEN STAKES AFTER IT HAS BEEN ANCHORED TO THE STAKES. 5. SILT FENCE FABRIC SHALL BE ANCHORED TO THE STAKES USING 1" HEAVY DUTY STAPLES OR NAILS WITH 1" HEADS. STAPLES AND NAILS SHOULD BE PLACED 3" ALONG THE FABRIC

DOWN THE STAKE. 6. AT THE END OF A RUN OF SILT FENCE ALONG A CONTOUR, THE SILT FENCE SHOULD BE TURNED PERPENDICULAR TO THE CONTOUR TO CREATE A "J-HOOK." THE "J-HOOK" EXTENDING PERPENDICULAR TO THE CONTOUR SHOULD BE OF SUFFICIENT LENGTH TO KEEP

7. SILT FENCE SHALL BE INSTALLED PRIOR TO ANY LAND DISTURBING ACTIVITIES.

RUNOFF FROM FLOWING AROUND THE END OF THE SILT FENCE (TYPICALLY 10" - 20").

SILT FENCE MAINTENANCE NOTES

1. INSPECT BMPs EACH WORKDAY, AND MAINTAIN THEM IN EFFECTIVE OPERATING CONDITION. MAINTENANCE OF BMPs SHOULD BE PROACTIVE, NOT REACTIVE. INSPECT BMPs AS SOON AS POSSIBLE (AND ALWAYS WITHIN 24 HOURS) FOLLOWING A STORM THAT CAUSES SURFACE EROSION, AND PERFORM NECESSARY MAINTENANCE.

2. FREQUENT OBSERVATIONS AND MAINTENANCE ARE NECESSARY TO MAINTAIN BMPs IN EFFECTIVE OPERATING CONDITION. INSPECTIONS AND CORRECTIVE MEASURES SHOULD BE

3. WHERE BMPs HAVE FAILED, REPAIR OR REPLACEMENT SHOULD BE INITIATED UPON DISCOVERY OF THE FAILURE.

4. SEDIMENT ACCUMULATED UPSTREAM OF THE SILT FENCE SHALL BE REMOVED AS NEEDED TO MAINTAIN THE FUNCTIONALITY OF THE BMP, TYPICALLY WHEN DEPTH OF ACCUMULATED SEDIMENTS IS APPROXIMATELY 6".

5. REPAIR OR REPLACE SILT FENCE WHEN THERE ARE SIGNS OF WEAR, SUCH AS SAGGING, TEARING, OR COLLAPSE.

6. SILT FENCE IS TO REMAIN IN PLACE UNTIL THE UPSTREAM DISTURBED AREA IS STABILIZED AND APPROVED BY THE LOCAL JURISDICTION, OR IS REPLACED BY AN EQUIVALENT PERIMETER SEDIMENT CONTROL BMP.

7. WHEN SILT FENCE IS REMOVED, ALL DISTURBED AREAS SHALL BE COVERED WITH TOPSOIL, SEEDED AND MULCHED OR OTHERWISE STABILIZED AS APPROVED BY LOCAL JURISDICTION. (DETAIL ADAPTED FROM TOWN OF PARKER, COLORADO AND CITY OF AURORA, NOT AVAILABLE IN AUTOCAD)

NOTE: MANY JURISDICTIONS HAVE BMP DETAILS THAT VARY FROM UDFCD STANDARD DETAILS. CONSULT WITH LOCAL JURISDICTIONS AS TO WHICH DETAIL SHOULD BE USED WHEN DIFFERENCES ARE NOTED.

**Stockpile Management (SP)** 

RS-2

MM-2

November 2010

STOCKPILE PROTECTION MAINTENANCE NOTES

2. FREQUENT OBSERVATIONS AND MAINTENANCE ARE NECESSARY TO MAINTAIN BMPs IN

3. WHERE BMPs HAVE FAILED, REPAIR OR REPLACEMENT SHOULD BE INITIATED UPON

STOCKPILE PROTECTION MAINTENANCE NOTES

5. STOCKPILE PERIMETER CONTROLS CAN BE REMOVED ONCE ALL THE MATERIAL FROM THE STOCKPILE HAS BEEN USED.

(DETAILS ADAPTED FROM PARKER, COLORADO, NOT AVAILABLE IN AUTOCAD)

**Stockpile Management (SM)** 

EFFECTIVE OPERATING CONDITION, INSPECTIONS AND CORRECTIVE MEASURES SHOULD BE


DISCOVERY OF THE FAILURE.

4. IF PERIMETER PROTECTION MUST BE MOVED TO ACCESS SOIL STOCKPILE, REPLACE PERIMETER CONTROLS BY THE END OF THE WORKDAY.

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STOCKPILE SILT FENCE (SEE SF DETAIL FOR INSTALLATION REQUIREMENTS)



SP-1. STOCKPILE PROTECTION

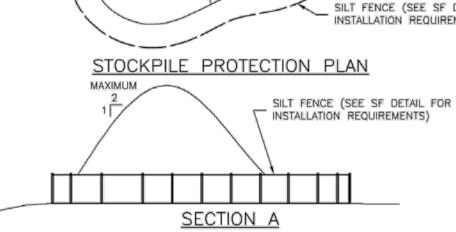STOCKPILE PROTECTION INSTALLATION NOTES

OR SLUMPS AGAINST THE PERIMETER, AND OTHER FACTORS.

-LOCATION OF STOCKPILES.


-TYPE OF STOCKPILE PROTECTION. 2. INSTALL PERIMETER CONTROLS IN ACCORDANCE WITH THEIR RESPECTIVE DESIGN DETAILS SILT FENCE IS SHOWN IN THE STOCKPILE PROTECTION DETAILS: HOWEVER, OTHER TYPES OF PERIMETER CONTROLS INCLUDING SEDIMENT CONTROL LOGS OR ROCK SOCKS MAY BE SUITABLE IN SOME CIRCUMSTANCES. CONSIDERATIONS FOR DETERMINING THE APPROPRIATE TYPE OF PERIMETER CONTROL FOR A STOCKPILE INCLUDE WHETHER THE STOCKPILE IS LOCATED ON A PERVIOUS OR IMPERVIOUS SURFACE, THE RELATIVE HEIGHTS OF THE PERIMETER CONTROL AND STOCKPILE, THE ABILITY OF THE PERIMETER CONTROL TO CONTAIN THE STOCKPILE WITHOUT FAILING IN THE EVENT THAT MATERIAL FROM THE STOCKPILE SHIFTS

3. STABILIZE THE STOCKPILE SURFACE WITH SURFACE ROUGHENING, TEMPORARY SEEDING AND MULCHING, EROSION CONTROL BLANKETS, OR SOIL BINDERS. SOILS STOCKPILED FOR AN EXTENDED PERIOD (TYPICALLY FOR MORE THAN 60 DAYS) SHOULD BE SEEDED AND MULCHED WITH A TEMPORARY GRASS COVER ONCE THE STOCKPILE IS PLACED (TYPICALLY WITHIN 14 DAYS), USE OF MULCH ONLY OR A SOIL BINDER IS ACCEPTABLE IF THE STOCKPILE WILL BE IN PLACE FOR A MORE LIMITED TIME PERIOD (TYPICALLY 30-60 DAYS).

4. FOR TEMPORARY STOCKPILES ON THE INTERIOR PORTION OF A CONSTRUCTION SITE. WHERE OTHER DOWNGRADIENT CONTROLS, INCLUDING PERIMETER CONTROL, ARE IN PLACE, STOCKPILE PERIMETER CONTROLS MAY NOT BE REQUIRED.

1. INSPECT BMPs EACH WORKDAY, AND MAINTAIN THEM IN EFFECTIVE OPERATING CONDITION. MAINTENANCE OF BMPs SHOULD BE PROACTIVE, NOT REACTIVE, INSPECT BMPs AS SOON AS POSSIBLE (AND ALWAYS WITHIN 24 HOURS) FOLLOWING A STORM THAT CAUSES SURFACE EROSION, AND PERFORM NECESSARY MAINTENANCE.

NOTE: MANY JURISDICTIONS HAVE BMP DETAILS THAT VARY FROM UDFCD STANDARD DETAILS. CONSULT WITH LOCAL JURISDICTIONS AS TO WHICH DETAIL SHOULD BE USED WHEN DIFFERENCES ARE NOTED.

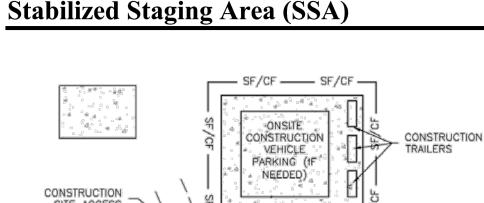

SITE ACCESS

3" MIN. THICKNESS GRANULAR MATERIAL STABILIZED AREA CONSTRUCTION ENTRANCE (SEE DETAILS VTC-1 TO VTC-3) SILT FENCE OR CONSTRUCTION — SF/CF —— SF/CF — FENCING AS NEEDED

> EXISTING ROADWAY SSA-1. STABILIZED STAGING AREA

STABILIZED STAGING AREA INSTALLATION NOTES

1. SEE PLAN VIEW FOR

-LOCATION OF STAGING AREA(S). -CONTRACTOR MAY ADJUST LOCATION AND SIZE OF STAGING AREA WITH APPROVAL FROM THE LOCAL JURISDICTION.

2. STABILIZED STAGING AREA SHOULD BE APPROPRIATE FOR THE NEEDS OF THE SITE. OVERSIZING RESULTS IN A LARGER AREA TO STABILIZE FOLLOWING CONSTRUCTION.

3. STAGING AREA SHALL BE STABILIZED PRIOR TO OTHER OPERATIONS ON THE SITE. 4. THE STABILIZED STAGING AREA SHALL CONSIST OF A MINIMUM 3" THICK GRANULAR

5. UNLESS OTHERWISE SPECIFIED BY LOCAL JURISDICTION, ROCK SHALL CONSIST OF DOT SECT. #703, AASHTO #3 COARSE AGGREGATE OR 6" (MINUS) ROCK.

6. ADDITIONAL PERIMETER BMPs MAY BE REQUIRED INCLUDING BUT NOT LIMITED TO SILT FENCE AND CONSTRUCTION FENCING. STABILIZED STAGING AREA MAINTENANCE NOTES

MAINTENANCE OF BMPs SHOULD BE PROACTIVE, NOT REACTIVE. INSPECT BMPs AS SOON AS POSSIBLE (AND ALWAYS WITHIN 24 HOURS) FOLLOWING A STORM THAT CAUSES SURFACE EROSION, AND PERFORM NECESSARY MAINTENANCE. 2. FREQUENT OBSERVATIONS AND MAINTENANCE ARE NECESSARY TO MAINTAIN BMPs IN

1. INSPECT BMPs EACH WORKDAY, AND MAINTAIN THEM IN EFFECTIVE OPERATING CONDITION.

EFFECTIVE OPERATING CONDITION. INSPECTIONS AND CORRECTIVE MEASURES SHOULD BE DOCUMENTED THOROUGHLY. 3. WHERE BMPs HAVE FAILED, REPAIR OR REPLACEMENT SHOULD BE INITIATED UPON

DISCOVERY OF THE FAILURE. 4. ROCK SHALL BE REAPPLIED OR REGRADED AS NECESSARY IF RUTTING OCCURS OR UNDERLYING SUBGRADE BECOMES EXPOSED.

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SP-4 Urban Storm Drainage Criteria Manual Volume 3 November 2010

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**SM-4** 

1.00 lbs pls/acre

2.50 lbs pls/acre

3.00 lbs pls/acre

0.75 lbs pls/acre

1.50 lbs pls/acre

0.75 lbs pls/acre

Q.50 lbs pls/acre

1.50 lbs pls/acre

0.50 lbs pls/acre

3.00 lbs pls/acre

2.00 lbs pls/acre

2.50 lbs pls/acre

2.50 lbs pls/acre

1.75 lbs pls/acre

0.50 lbs pls/acre

1.00 lbs pls/acre

0.50 lbs pls/acre

0.25 lbs pls/acre

Total: 14.00 pounds pls/acre

Total: 12.00 pounds pls/acre

(Champ, Chet)

(Bend, Native, Ne27)

(Blaze, Cimarron, Camper)

(Nezpar, Rimrock)

(Goshen)

Yellow Indiangrass / (Cheyenne, Holt, Scout)

Western wheatgrass (Arriba, Barton, Rosana)

Slender wheatgrass (Pryor, San Luis)

Alkaligrass (Fults II, Salt on Sea)

Streambank Wheatgrass (Sodar)

Green Needlegrass (Lodorm)

Sand Dropseed

Switchgrass (Nebraska 28, Blackwell)

Sideoats Grama (Butte, El Reno, Pierre)

Perennial Ryegrass (Calibra or Garibaldi tetraploid)

Switchgrass (Blackwell, Nebraska 28)

Sandy Site Mix

Sand Bluestem

Sand Lovegrass

Indian Ricegrass

Prairie Sandreed

Little bluestem

Sand Dropseed

Wetter Site Mix

Green Needlegrass (Lodorm)

WEST

CO3490 **SHEET** 59 **OF** 68

STABILIZED STAGING AREA MAINTENANCE NOTES

6. THE STABILIZED STAGING AREA SHALL BE REMOVED AT THE END OF CONSTRUCTION. THE GRANULAR MATERIAL SHALL BE REMOVED OR, IF APPROVED BY THE LOCAL JURISDICTION, USED ON SITE, AND THE AREA COVERED WITH TOPSOIL, SEEDED AND MULCHED OR OTHERWISE STABILIZED IN A MANNER APPROVED BY LOCAL JURISDICTION.

20 FOOT (WIDTH CAN BE LESS IF CONST. VEHICLES ARE PHYSICALLY CONFINED ON BOTH SIDES) SIDEWALK OR OTHER 50 FOOT (MIN.) PAVED SURFACE - 9" (MIN.) UNLESS OTHERWISE SPECIFIED **PUBLIC** BY LOCAL JURISDICTION, USE ROADWAY CDOT SECT. #703, AASHTO #3 COARSE AGGREGATE OR 6" MINUS ROCK NON-WOVEN GEOTEXTILE FABRIC BETWEEN SOIL AND ROCK UNLESS OTHERWISE SPECIFIED BY LOCAL INSTALL ROCK FLUSH WITH OR BELOW TOP OF PAVEMENT JURISDICTION, USE CDOT SECT. #703, AASHTO #3 COARSE AGGREGATE OR 6" MINUS ROCK

VTC-1. AGGREGATE VEHICLE TRACKING CONTROL

Urban Drainage and Flood Control District

NON-WOVEN GEOTEXTILE

USED ON SHORT DURATION PROJECTS (TYPICALLY RANGING FROM A WEEK TO A MONTH) WHERE THERE WILL BE LIMITED VEHICULAR ACCESS.

4. STABILIZED CONSTRUCTION ENTRANCE/EXIT SHALL BE INSTALLED PRIOR TO ANY LAND

5. A NON-WOVEN GEOTEXTILE FABRIC SHALL BE PLACED UNDER THE STABILIZED CONSTRUCTION ENTRANCE/EXIT PRIOR TO THE PLACEMENT OF ROCK.

SECT. #703, AASHTO #3 COARSE AGGREGATE OR 6" (MINUS) ROCK.

1. INSPECT BMPs EACH WORKDAY, AND MAINTAIN THEM IN EFFECTIVE OPERATING CONDITION. MAINTENANCE OF BMPs SHOULD BE PROACTIVE, NOT REACTIVE. INSPECT BMPs AS SOON AS POSSIBLE (AND ALWAYS WITHIN 24 HOURS) FOLLOWING A STORM THAT CAUSES SURFACE

2. FREQUENT OBSERVATIONS AND MAINTENANCE ARE NECESSARY TO MAINTAIN BMPs IN

4. ROCK SHALL BE REAPPLIED OR REGRADED AS NECESSARY TO THE STABILIZED

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STABILIZED CONSTRUCTION ENTRANCE/EXIT INSTALLATION NOTES

1. SEE PLAN VIEW FOR -LOCATION OF CONSTRUCTION ENTRANCE(S)/EXIT(S). -TYPE OF CONSTRUCTION ENTRANCE(S)/EXITS(S) (WITH/WITHOUT WHEEL WASH, CONSTRUCTION MAT OR TRM).

2. CONSTRUCTION MAT OR TRM STABILIZED CONSTRUCTION ENTRANCES ARE ONLY TO BE

3. A STABILIZED CONSTRUCTION ENTRANCE/EXIT SHALL BE LOCATED AT ALL ACCESS POINTS WHERE VEHICLES ACCESS THE CONSTRUCTION SITE FROM PAVED RIGHT-OF-WAYS.

DISTURBING ACTIVITIES.

6. UNLESS OTHERWISE SPECIFIED BY LOCAL JURISDICTION, ROCK SHALL CONSIST OF DOT

STABILIZED CONSTRUCTION ENTRANCE/EXIT MAINTENANCE NOTES

EROSION, AND PERFORM NECESSARY MAINTENANCE.

EFFECTIVE OPERATING CONDITION. INSPECTIONS AND CORRECTIVE MEASURES SHOULD BE DOCUMENTED THOROUGHLY.

3. WHERE BMPs HAVE FAILED, REPAIR OR REPLACEMENT SHOULD BE INITIATED UPON DISCOVERY OF THE FAILURE.

ENTRANCE/EXIT TO MAINTAIN A CONSISTENT DEPTH.

5. SEDIMENT TRACKED ONTO PAVED ROADS IS TO BE REMOVED THROUGHOUT THE DAY AND AT THE END OF THE DAY BY SHOVELING OR SWEEPING, SEDIMENT MAY NOT BE WASHED DOWN STORM SEWER DRAINS.

NOTE: MANY JURISDICTIONS HAVE BMP DETAILS THAT VARY FROM UDFCD STANDARD DETAILS. CONSULT WITH LOCAL JURISDICTIONS AS TO WHICH DETAIL SHOULD BE USED WHEN

(DETAILS ADAPTED FROM CITY OF BROOMFIELD, COLORADO, NOT AVAILABLE IN AUTOCAD)

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COMPACTED SUBGRADE -

VTC-3

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SUBDIVISION MSP COMPANIES


**VISTA** 

5. STABILIZED STAGING AREA SHALL BE ENLARGED IF NECESSARY TO CONTAIN PARKING, STORAGE, AND UNLOADING/LOADING OPERATIONS.

NOTE: MANY MUNICIPALITIES PROHIBIT THE USE OF RECYCLED CONCRETE AS GRANULAR MATERIAL FOR STABILIZED STAGING AREAS DUE TO DIFFICULTIES WITH RE-ESTABLISHMENT OF VEGETATION IN AREAS WHERE RECYCLED CONCRETE WAS PLACED.

NOTE: MANY JURISDICTIONS HAVE BMP DETAILS THAT VARY FROM UDFCD STANDARD DETAILS. CONSULT WITH LOCAL JURISDICTIONS AS TO WHICH DETAIL SHOULD BE USED WHEN DIFFERENCES ARE NOTED.

(DETAILS ADAPTED FROM DOUGLAS COUNTY, COLORADO, NOT AVAILABLE IN AUTOCAD)

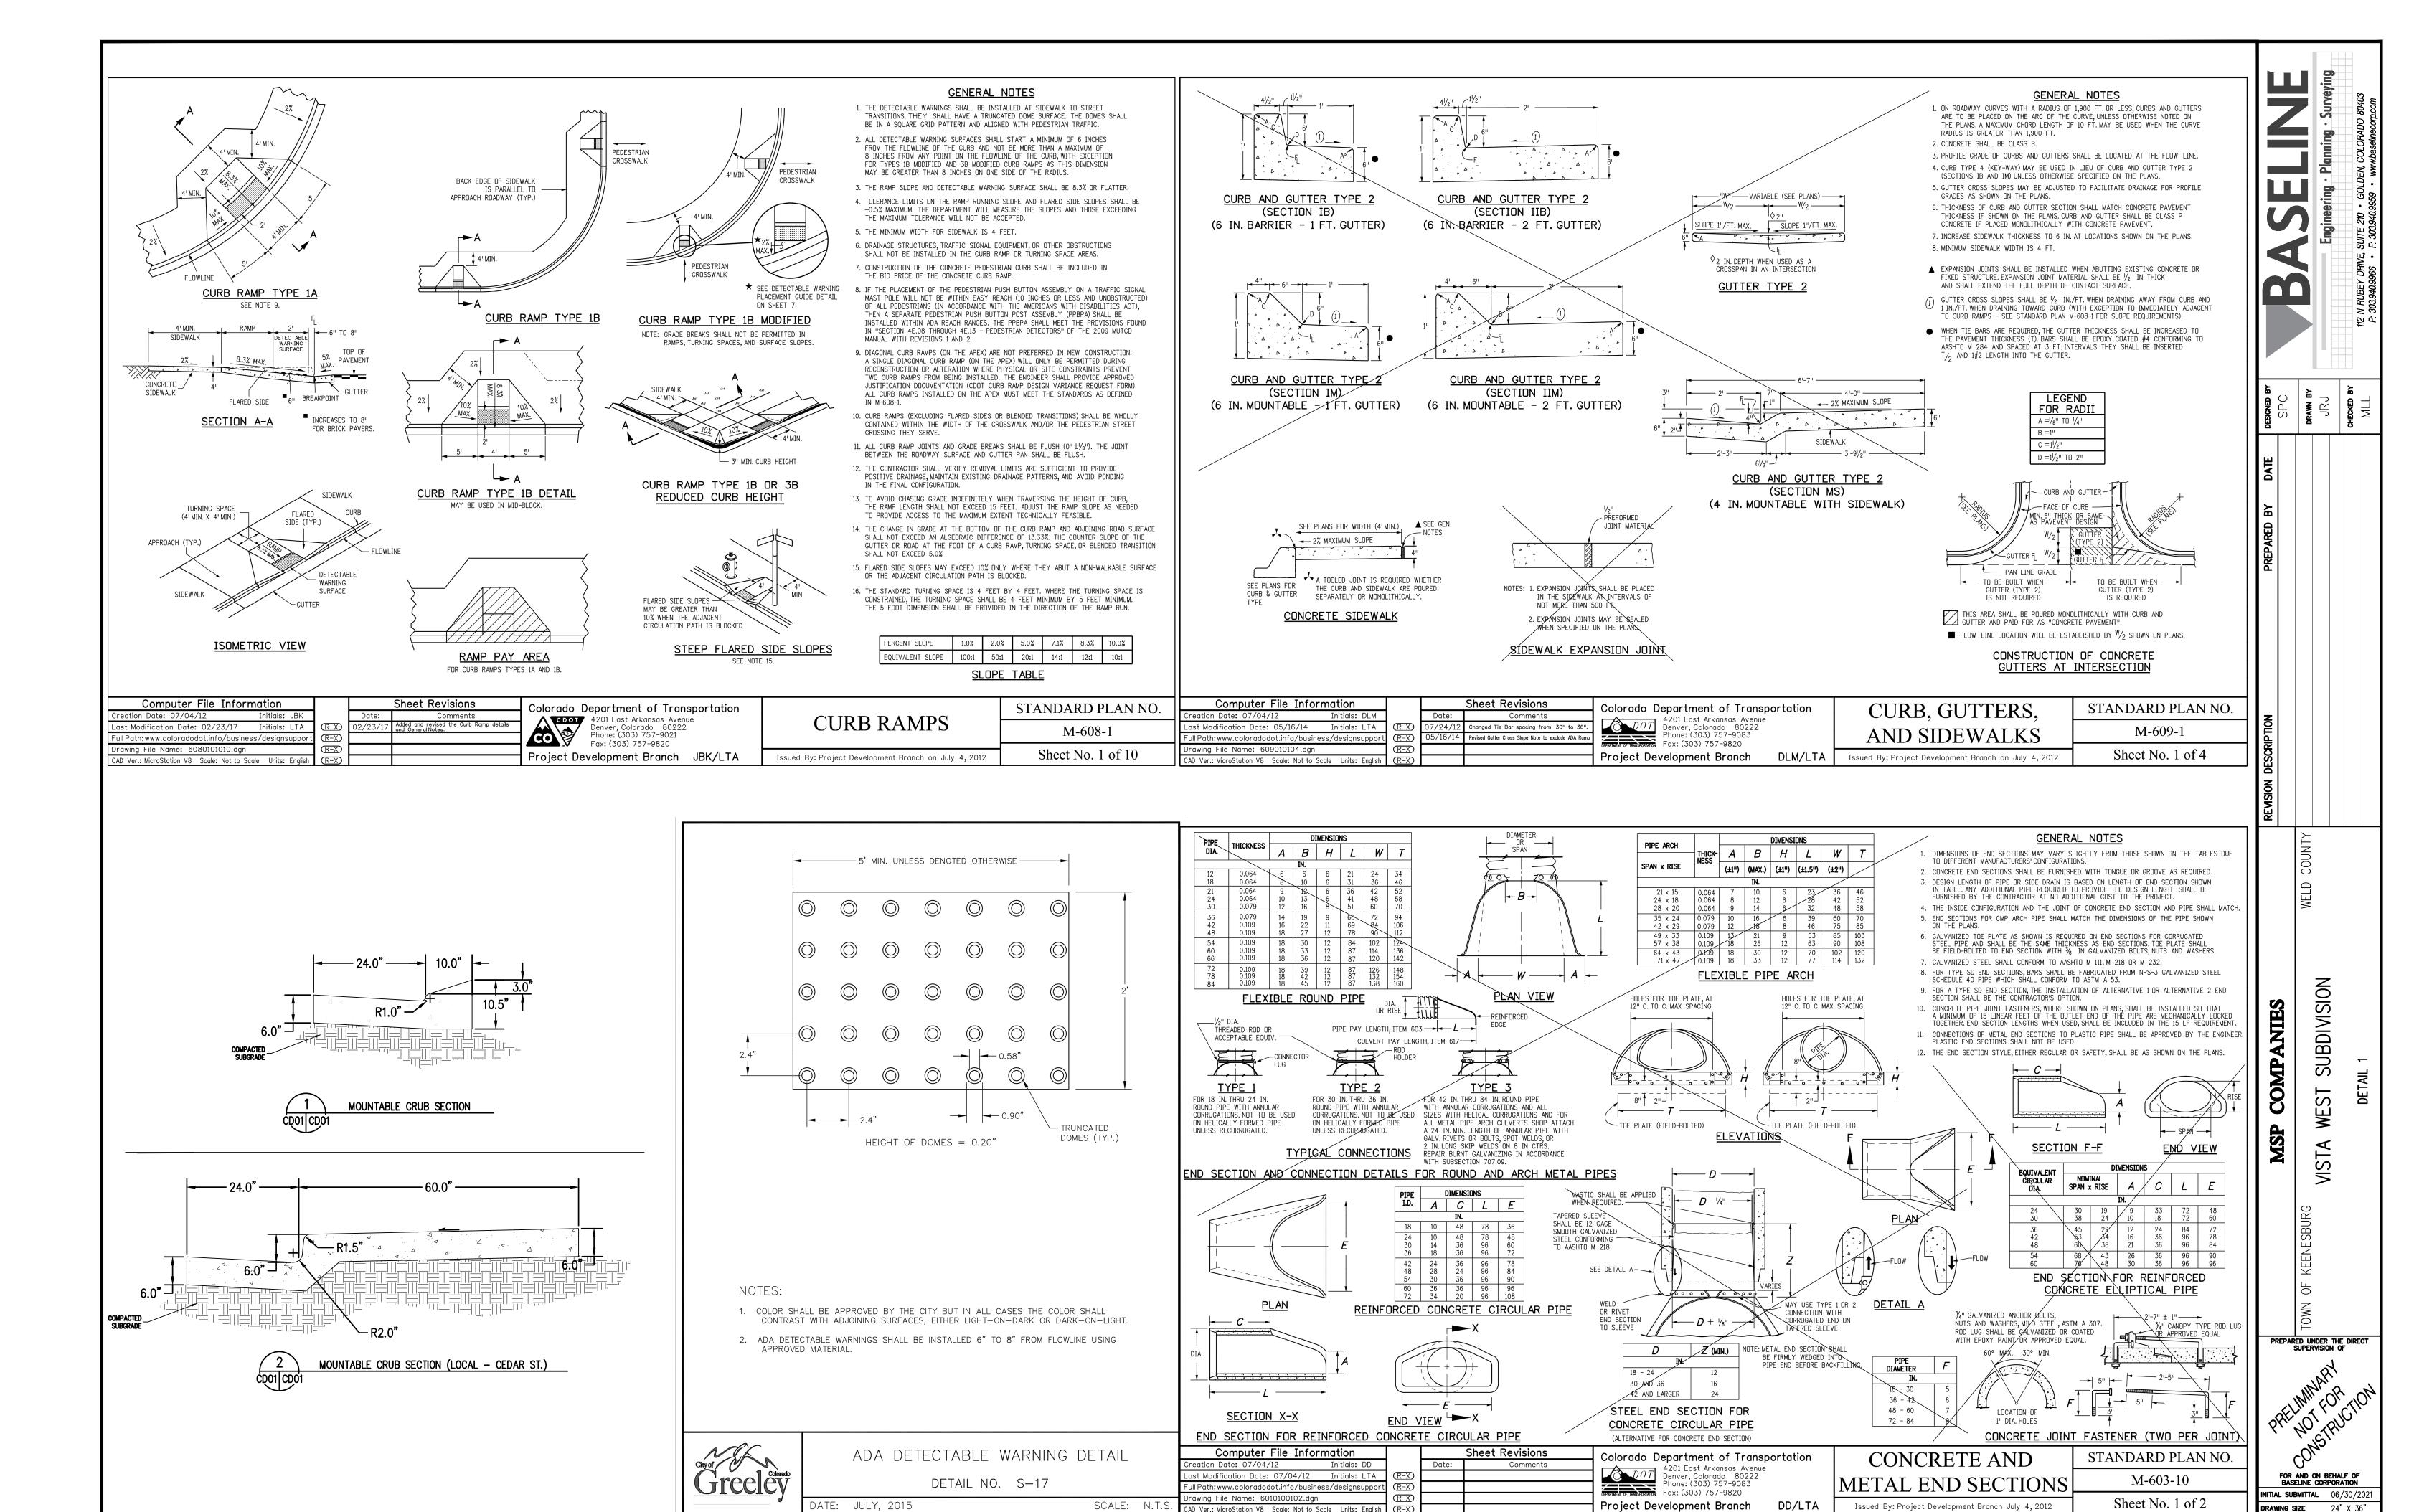

. 1490 — Summerfield — Keenesburg\Drawings\Construction Plans\Cover and Notes\349


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3490-Cover, Notes, & Details.dwg
SHEET 60 OF 68


SURVEY DATE 10/02/2020

SURVEY FIRM

SURVEY FIRM

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2. SERVICES ARE 4" OR 6" IN DIAMETER AND SHALL HAVE A MINIMUM SLOPE OF 1.0% (%" PER FOOT) AND A

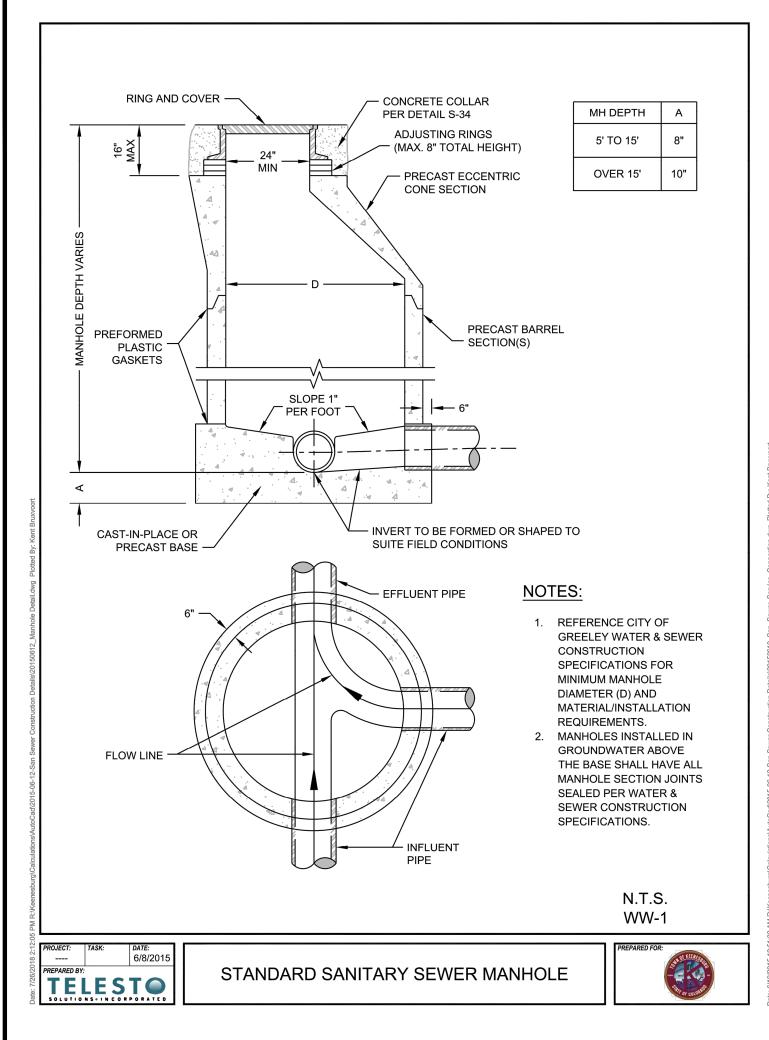4. SERVICES SHALL EXTEND TO THE PROPERTY LINE UNLESS OTHERWISE SHOWN ON CITY ACCEPTED

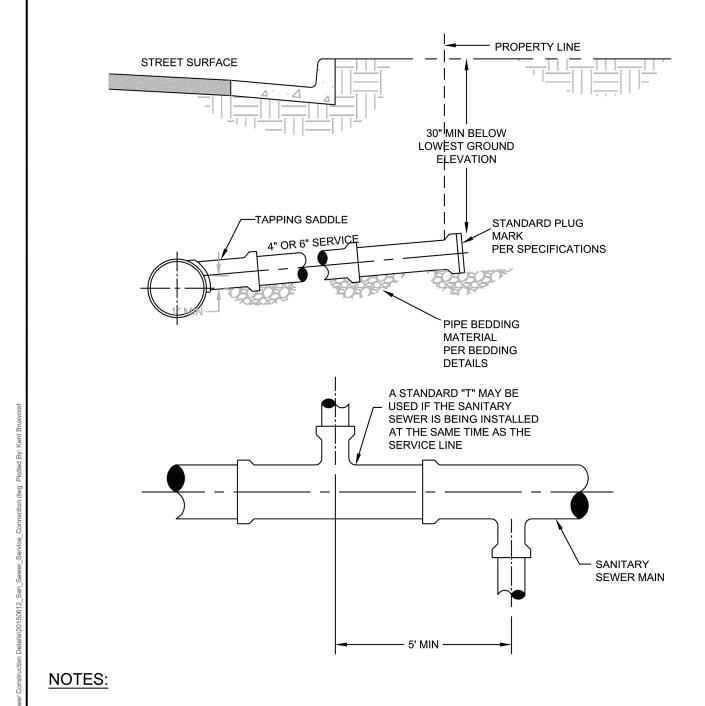5. THE SPRINGLINE OF THE SERVICE LINE SHALL BE A MINIMUM OF 1" ABOVE THE SPRINGLINE OF THE SANITARY

SANITARY SEWER SERVICE CONNECTION

N.T.S.

WW-2


1. IN NO CASE SHALL THE SERVICE LINE PROTRUDE INTO THE MAIN.

SEWER MAIN AND NO CLOSER THAN 1' TO A PIPE JOINT.


3. SERVICES LARGER THAN 6" DIAMETER SHALL BE CONNECTED TO A MANHOLE.

MAXIMUM SLOPE OF 8.0%.


CONSTRUCTION DRAWINGS.

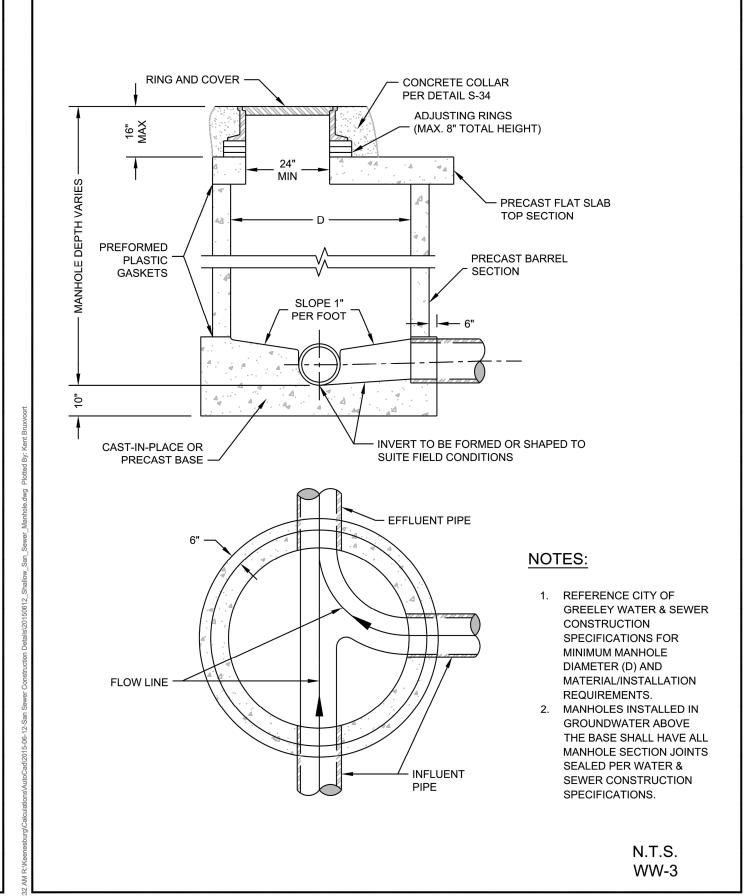



SHALLOW SANITARY SEWER MANHOLE

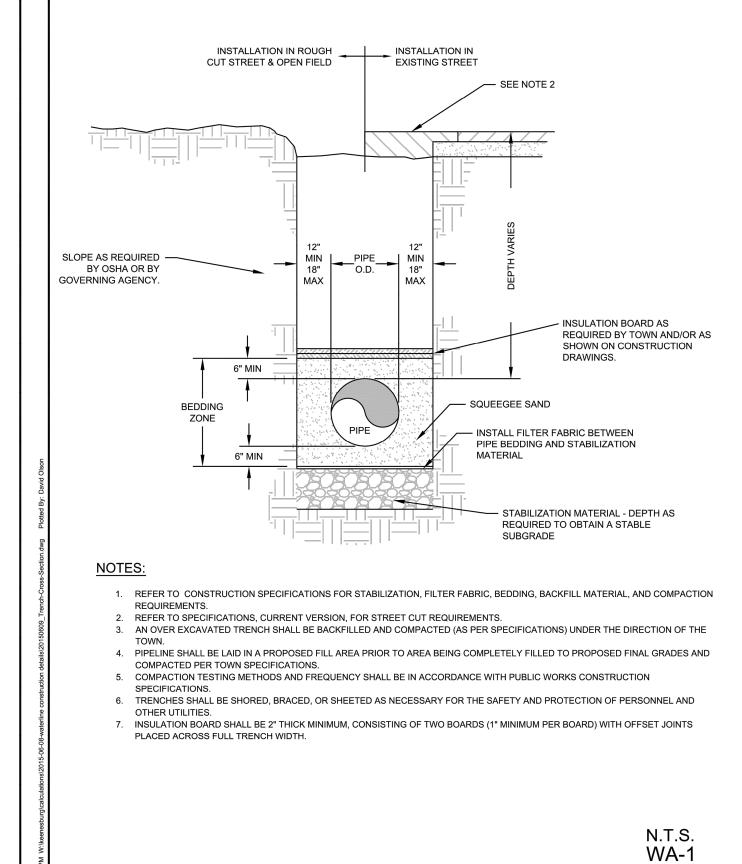


TRENCH CROSS SECTION

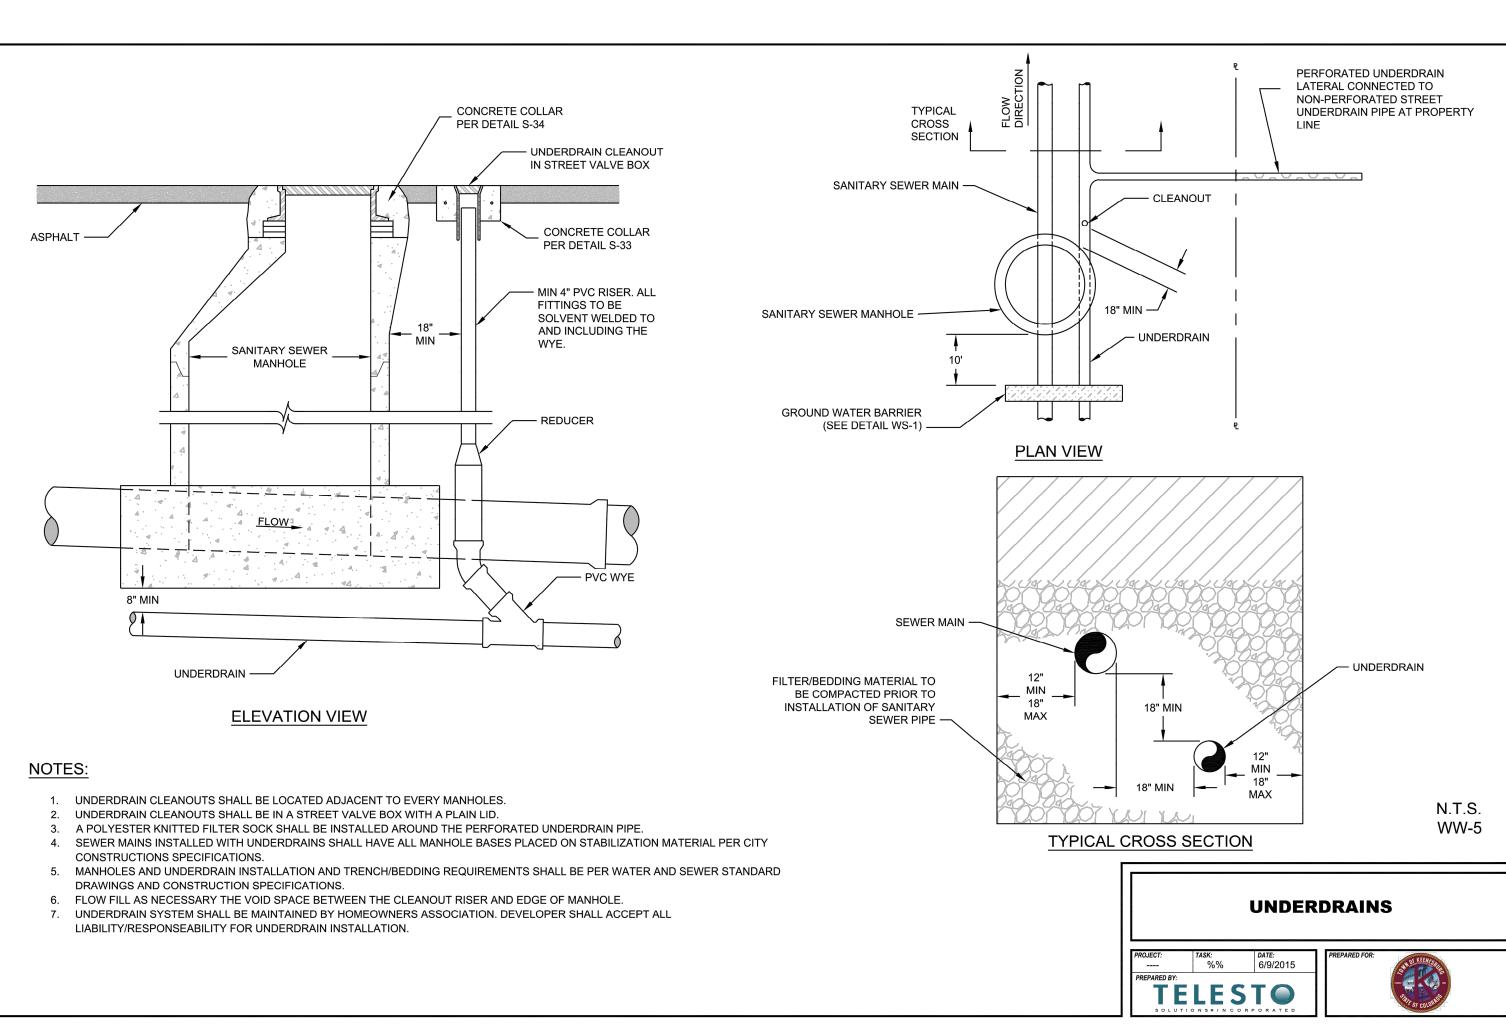

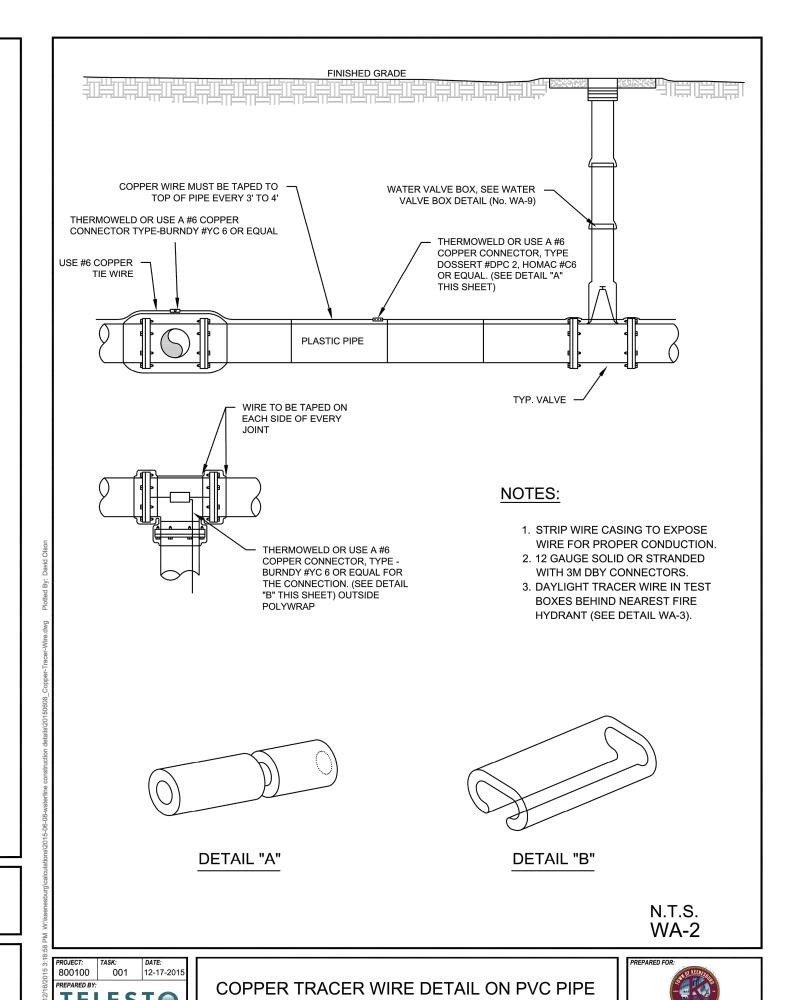

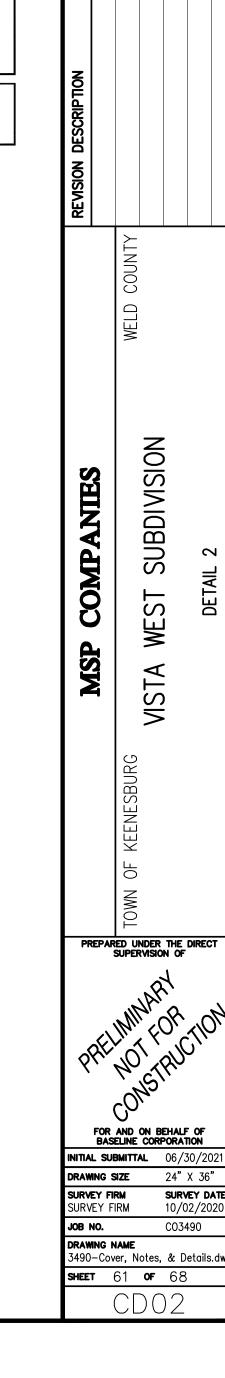

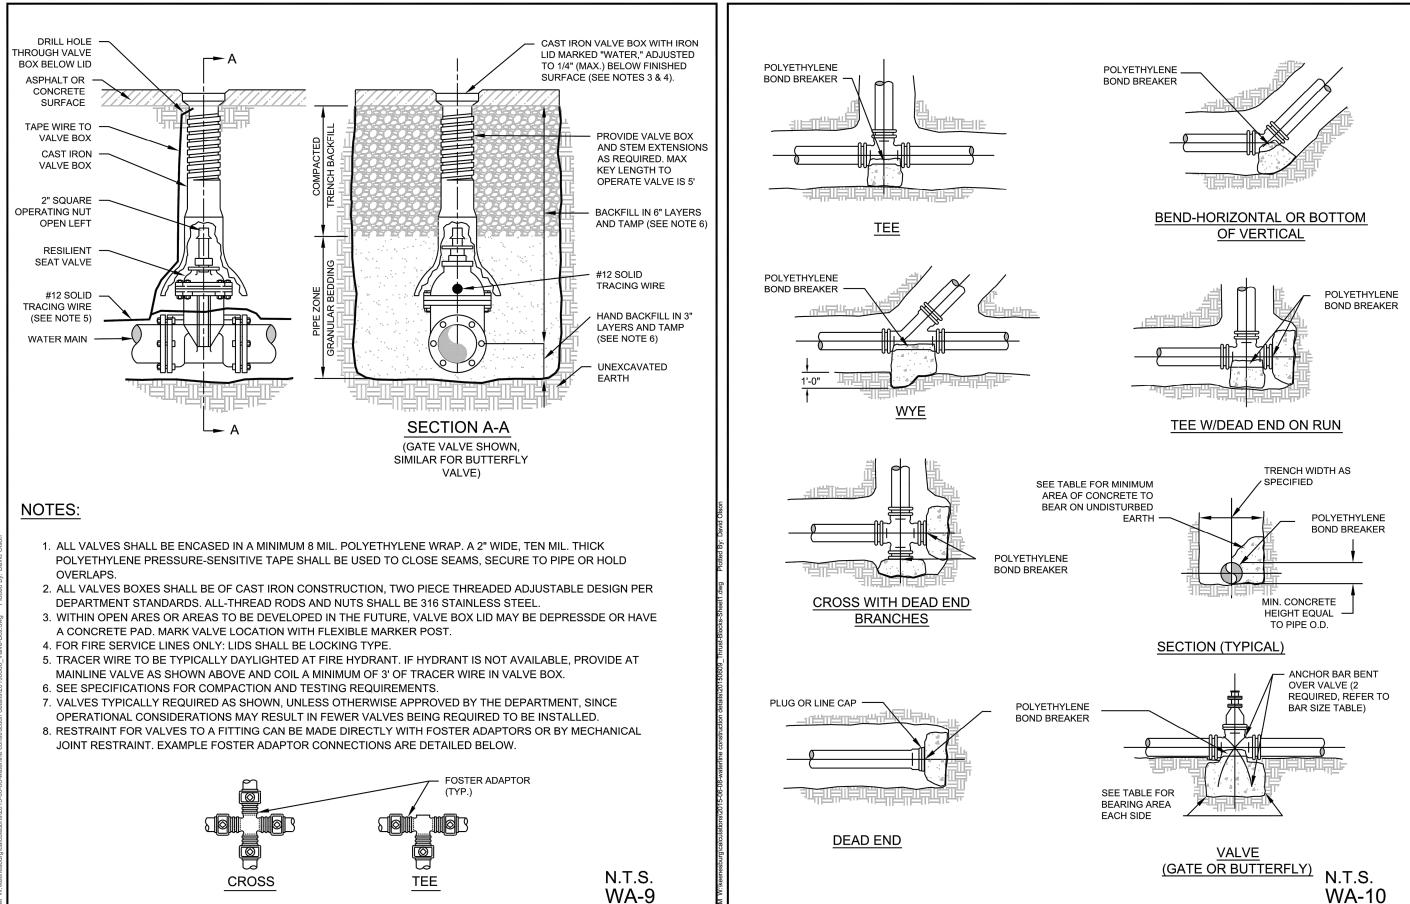


**TELEST** 

STANDARD FORGED

WATERWORKS

PENTAGON HEAD -

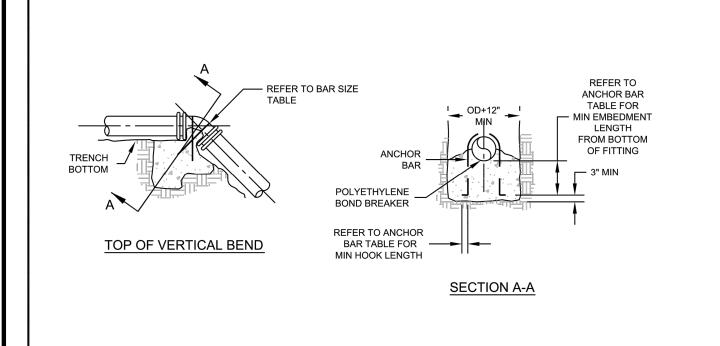

#### VOL. CONCRETE FOR 100 PSI TEST PRESSURE (CU FT)

PIPE		BENDS	
SIZE	45°	22 ½°	11 ¼°
6"	18.6	9.5	4.7
8"	32.0	16.3	8.2
12"	68.1	34.7	17.5
16"	118.3	60.3	30.3

FOR TEST PRESSURE GREATER THAN 100 PSI, ADJUST CONCRETE VOLUMES BY MULTIPLYING TABLE VALUES BY CORRECTION FACTOR "F"

#### ANCHOR BAR INFORMATION FOR 100 PSI TEST PRESSURE

CONCRETE VOLUME	REBAR SIZE	MIN EMBEDMENT LENGTH	MIN HOOK LENGTH
60 CF	NO. 4	8"	8"
90 CF	NO. 5	12"	10"
133 CF	NO. 6	16"	12"

N.T.S. WA-10

#### THRUST BLOCK BEARING AREAS (SQ-FT) FOR INTERNAL STATIC PRESSURE OF 100 PSI AND SOIL BEARING CAPACITY OF 1000 PSF

DIAM (IN)	90° BEND	45° BEND	22½° BEND	11¼° BEND	DEAD ENDS, VALVES & TEES, PLUGGED CROSS BRANCHES
3	1.7	0.9	0.5	0.2	1.2
4	2.6	1.4	0.7	0.4	1.8
6	5.3	2.9	1.5	0.7	3.7
8	9.1	4.9	2.5	1.3	6.4
12	19.4	10.5	5.3	2.7	13.7
16	33.6	18.2	9.3	4.7	23.8


## NOTES:

- POLYETHYLENE BOND BREAKER SHALL BE INSTALLED BETWEEN ALL FITTINGS AND CONCRETE.
- ALL THRUST BLOCKING SHALL BE CAST-IN-PLACE CONCRETE WITH A MINIMUM YIELD 28 DAY STRENGTH OF 2000 P.S.I. 3. THRUST BLOCKING SHALL BE CAST AGAINST UNDISTURBED SOIL. FORMS SHALL BE USED AS REQUIRED TO OBTAIN ADEQUATE BEARING AREA AND TO CONFINE THE CONCRETE. THRUST BLOCKING SHALL BEAR ON THE FITTING OR END
- CAP ONLY AND WILL NOT BE ALLOWED TO SPILL OVER THE JOINT OR AGAINST THE PIPE. 4. THE CITY MAY REQUIRE LARGER THRUST BLOCKS THAN SPECIFIED IF SOILS ARE DETERMINED TO PROVIDE LESS THAN 1000 PSF BEARING CAPACITY.
- 5. IN THE ABSENCE OF SOIL BEARING CAPACITY INFORMATION USE 1000 PSF. BEARING AREAS FOR ANY PRESSURE AND SOIL BEARING CAPACITY MAY BE OBTAINED BY MULTIPLYING THE TABULATED BEARING AREAS BY A CORRECTION FACTOR "F": F= (ACTUAL SPECIFIED TEST PRESSURE IN PSI)/(100 PSI)
- (ACTUAL SOIL BEARING CAPACITY IN PSF)/(1000 PSF) 7. EXAMPLE: CALCULATE THE BEARING AREA FOR 8"-90" BEND WITH A STATIC INTERNAL PRESSURE OF 150 PSI AND SOIL BEARING CAPACITY OF 3000 PSF.

#### FROM TABLE BEARING AREA = 9.1 SF


 $F = \frac{(150 \text{ PSI})/(100 \text{ PSI})}{(100 \text{ PSI})} = 0.5$ 

(3000 PSF)/(1000 PSF) REQUIRED BEARING AREA ON UNDISTURBED SOIL = (0.5)(9.1 SF) =4.55 SF

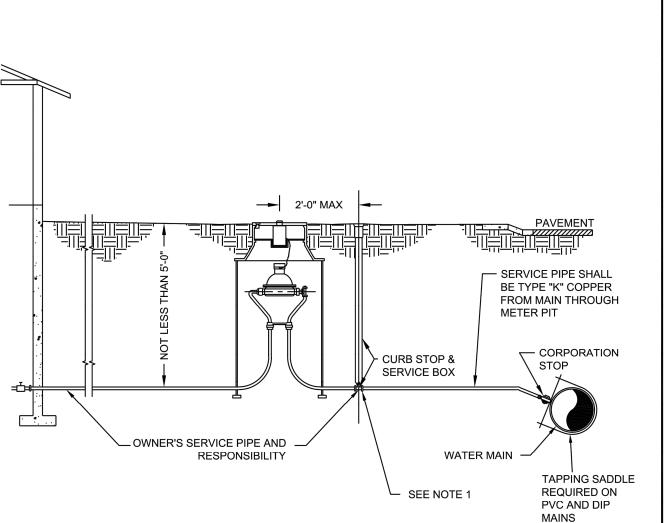

TELESTO

- PLACEMENT OF CURB STOP BOX MAY VARY FROM A MAXIMUM OF 1 FOOT OUTSIDE THE PROPERTY LINE TO A MAXIMUM OF 1 FOOT INSIDE THE PROPERTY LINE. PLACEMENT OF CURB STOP BOX OUTSIDE THE PROPERTY LINE IS PREFERRED. PUBLIC WORKS DEPARTMENT'S RESPONSIBILITY SHALL BE THE WATER MAIN, CORPORATION STOP, SERVICE PIPING UP TO THE CURB STOP, AND THE TUBE NUT ON THE STREET SIDE OF THE CURB STOP. OWNERS RESPONSIBILITY SHALL BE UP TO
- AN INCLUDING THE CURB STOP AND BOX. SHOULD ANY SITUATION ARISE OTHER THAN SHOWN CONCERNING THE DEPTH OR OBSTRUCTION OF SERVICE LINE OR THE
- PLACEMENT OF THE METER PIT OR STOP BOX, CALL TOWN'S PUBLIC WORKS DEPARTMENT. 4. REFER TO WATER AND SEWER STANDARD DRAWINGS AND CONSTRUCTION SPECIFICATIONS FOR METER INSTALLATION
- REQUIREMENTS. 5. SEE DETAIL WA-11 FOR METER SETTING

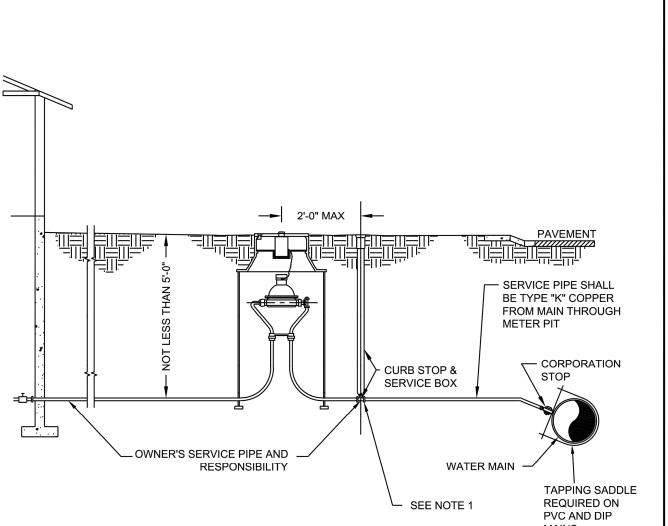

VALVE BOX

# 1. NOT FOR INSTALLATION IN ROADWAYS OR PARKING AREAS.

- BRICK BEARING SURFACE

- 2. IF SURFACE IS NOT TO FINAL GRADE AT TIME OF INSTALLATION OF METER, OR GRADE CHANGES AFTER INSTALLATION,
- OWNER MUST ADJUST PIT TO MEET SPECIFICATIONS. 3. METER SETTING MUST BE INSPECTED BEFORE BACKFILLING. FOR INSPECTION CALL TOWN DEPARTMENT OF PUBLIC WORKS, LOCATION OF METER SHALL BE 2 FEET DOWNSTREAM OF THE CURB STOP UNLESS OTHERWISE PLACED BY METER

THRUST BLOCKS

SHEET 1 OF 3

GROUND SURROUNDING METER

METER INSTALLATION DIMENSIONS

14 1/4" | 9 5/16" | 8 15/16" | 17 1/4" | 11 1/16" | 11 1/4" | 6"

PIT SHALL SLOPE AWAY FROM

LID AT 2% MINIMUM GRADE

ALUMINUM DOUBLE LID

MODEL M-70 OR EQUAL)

**METER** SIZE

CONE (CASTINGS INC.

INSTALL TOP LID

\_\_ ½" ABOVE GRADE

- SERVICES. 4. NO CONCRETE FLOOR TO BE POURED IN METER PIT.
- 5. NO SPRINKLER SYSTEM CONNECTIONS SHALL BE MADE IN THE METER PIT. SPRINKLER PIT SHALL BE MINIMUM 5 FT DOWNSTREAM FROM METER PIT, MEASURED EDGE TO EDGE.
- 6. NO MAJOR LANDSCAPING OR STRUCTURES SHALL BE LOCATED WITHIN 4 FT OF THE METER PIT. 7. IF PRESSURE REDUCING VALVE IS REQUIRED BY PLUMBING CODE, IT SHALL BE INSTALLED INSIDE THE BUILDING,
- IMMEDIATELY FOLLOWING THE MAIN WATER SHUT OFF VALVE.
- 8. COPPER SHALL SHOW NO VISIBLE CRIMPING. 9. REFER TO WATER & SEWER CONSTRUCTION SPECIFICATIONS, CURRENT VERSION, FOR PRODUCT SPECIFICATIONS.

WA-12

TELEST •

THRUST BLOCKS SHEET 2 OF 3



THRUST BLOCKS SHEET 3 OF 3



N.T.S.

WA-10



SERVICE LINE, STOP BOX AND METER



N.T.S.

WA-11

SETTING FOR 3/4" & 1" METER

NITIAL SUBMITTAL 06/30/20 DRAWNG SIZE 24" X 36" SURVEY DATE 10/02/2020 SURVEY FIRM SURVEY FIRM JOB NO. CO3490 DRAWING NAME 3490-Cover, Notes, & Details.dw **SHEET** 62 **OF** 68

COMPANIES


MSP

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SUBDIVIS

ST

## LEGEND

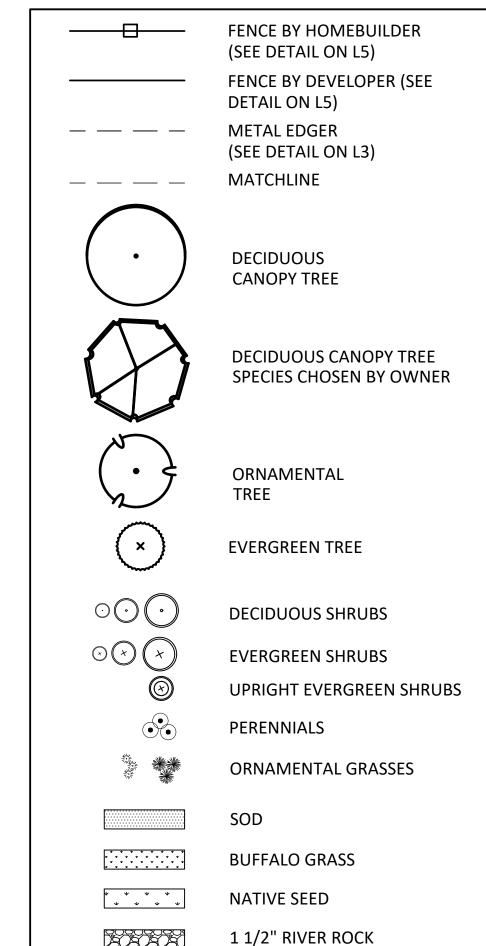

IMPERIAL HONEYLOCUST ESPRESSO KENTUCKY COFFEETREE

TCW THORNLESS COCKSPUR HAWTHORNE

SILVER FOUNTAIN BUTTERFLY BUSH

DRAWING SIZE 24" X 36"

DRAWING NAME 3490 LANDSCAPE PLAN.dwg **SHEET** 63 **OF** 68

LO1

SURVEY FIRM

SURVEY DATE 10/02/2020


METAL EDGER

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# LANDSCAPE NOTES

- 1. LOT STREET TREES, SOD, AND BACKYARD TREES ARE TO BE INSTALLED BY THE HOMEBUILDER.
- BACKYARD TREES ARE TO BE CHOSEN BY THE HOMEOWNER FROM THE LIST PROVIDED ON L04 PLANT SCHEDULE.
- 3. ANY TREES PLANTED IN THE SIGHT DISTANCE TRIANGLE SHOULD BE LIMBED UP TO 6'

## LEGEND

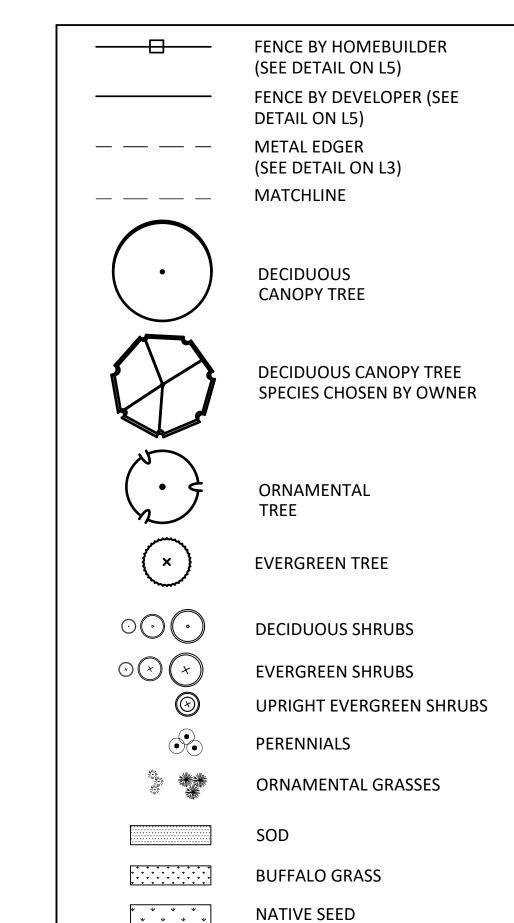

## LANDSCAPE PLANT LIST

#### **DECIDUOUS CANOPY TREES**

1 1/2" RIVER ROCK

HERITAGE OAK EMERALD SUNSHINE ELM SHADEMASTER HONELOCUST IMPERIAL HONEYLOCUST ESPRESSO KENTUCKY COFFEETREE BIGTOOTH MAPLE STATE STREET MAPLE SSM OHIO BUCKEYE WESTERN CATALPA COMMON HACKBERRY CHB GKB GINKGO SKYMASTER OAK LITTLE LEAF LINDEN COMMON HORSECHESTNUT NIOBE WEEPING WILLOW

# ORNAMENTAL TREES

TCW THORNLESS COCKSPUR HAWTHORNE

PLAINS COTTONWOOD

#### **EVERGREEN TREES**

BOP EMERALD ARROW BOSNIAN PINE
PON PONDEROSA PINE
PVP VANDERWOLF'S LIMBER PINE
RMJ ROCKY MOUNTAIN JUNIPER

#### **DECIDUOUS SHRUBS**

GFS GOLDFLAME SPIREA
BSF SILVER FOUNTAIN BUTTERFLY BUSH
FRS FRINGED SAGE

# **EVERGREEN SHRUBS**

MPA PANCHITO MANZANITA
COJ COLOGREEN JUNIPER
GGA GOLDEN GLOBE ARBORVITAE

### ORNAMENTAL GRASSES

BLUE OAT GRASS KARL FOERSTER FEATHER REED GRASS

n Schultz
Ryar
AM,
9: 23: 32
/2021
/02/9
PLAN.dwg,
Let
LANDSCAPE
\3490
Landscape`
\sbui
\Draw
keenesburg`
Summerfield
,co3490 –
ż

TOWN OF KEENESBURG

VISTA

COMPANIES

MSP

FOR AND ON BEHALF OF BASELINE CORPORATION

INITIAL SUBMITTAL 5/10/2021

DRAWING SIZE 24" X 36"

SURVEY FIRM SURVEY DATE
SURVEY FIRM 10/02/2020

PREPARED UNDER THE DIRECT SUPERVISION OF


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 SURVEY DATE


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 10/02/2020


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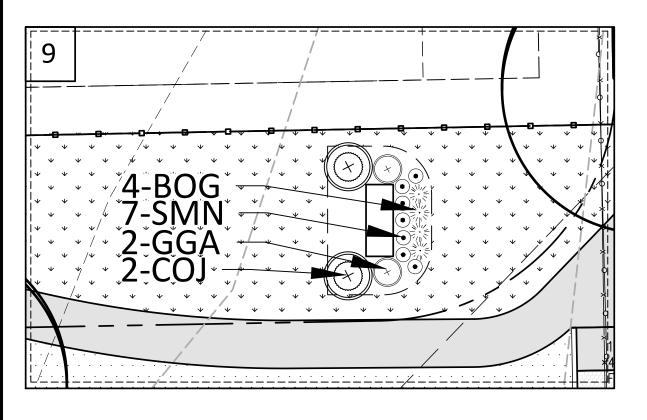
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 3490 LANDSCAPE PLAN.dwg


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 64
 OF
 68




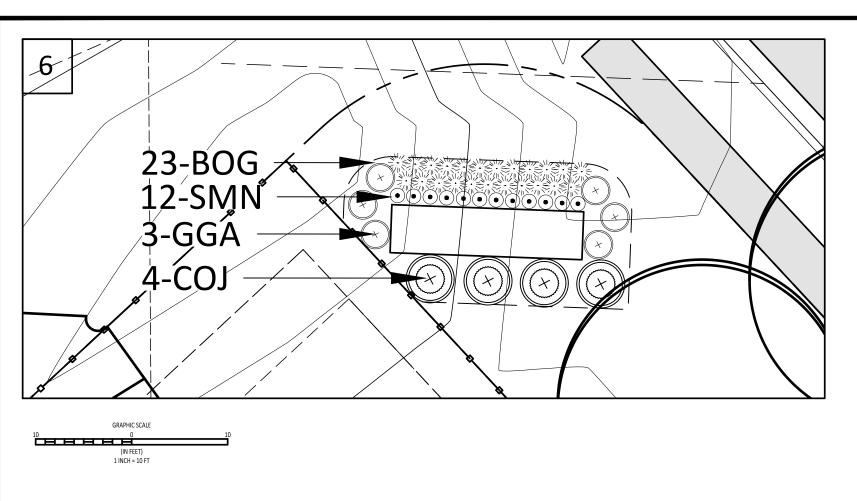


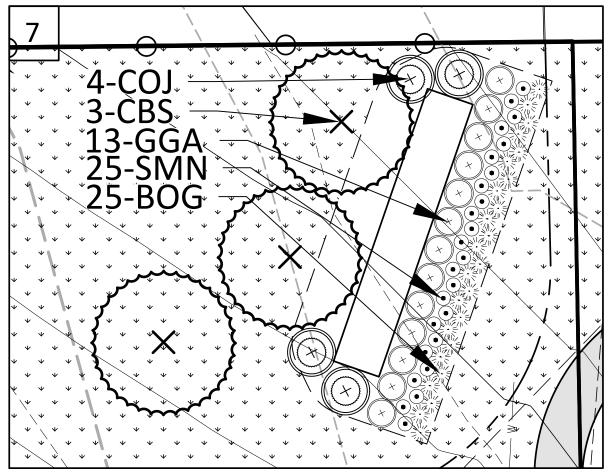


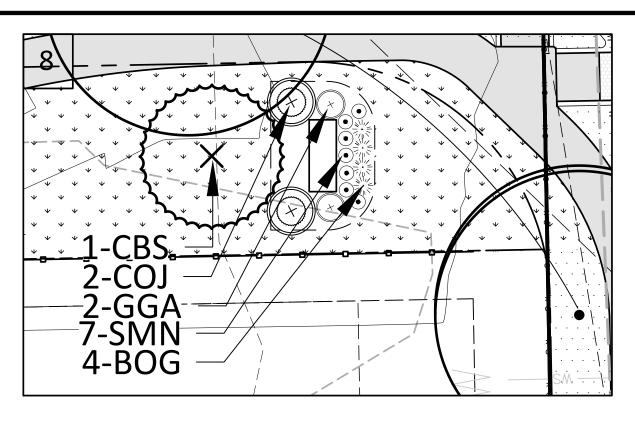

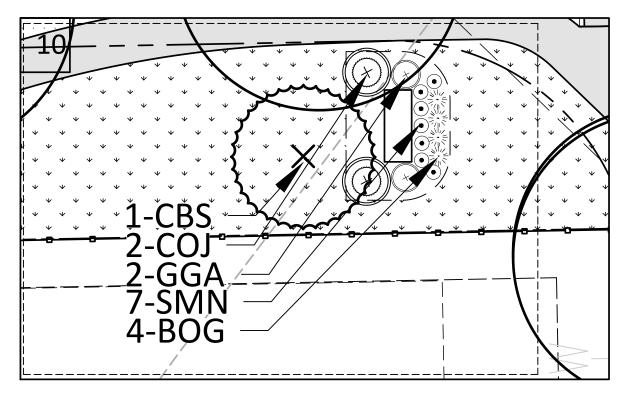

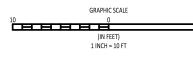

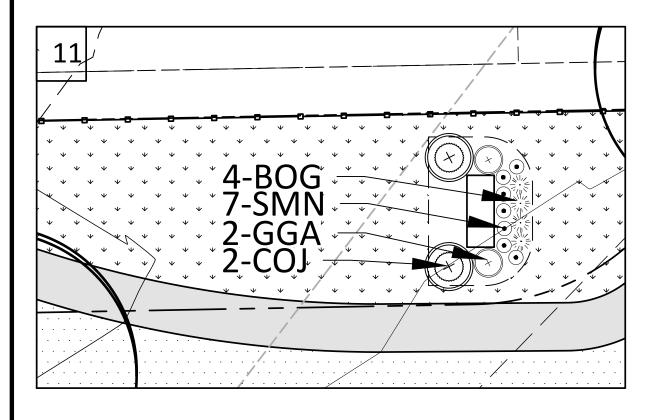

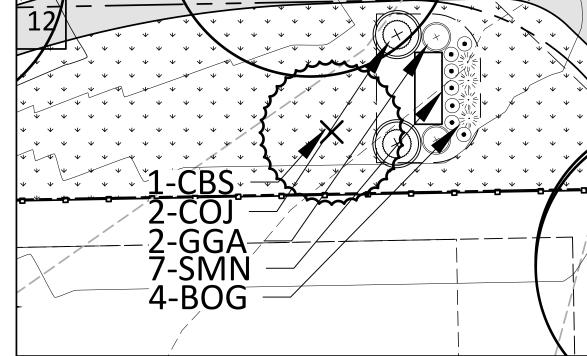



GRAPHIC SCALE

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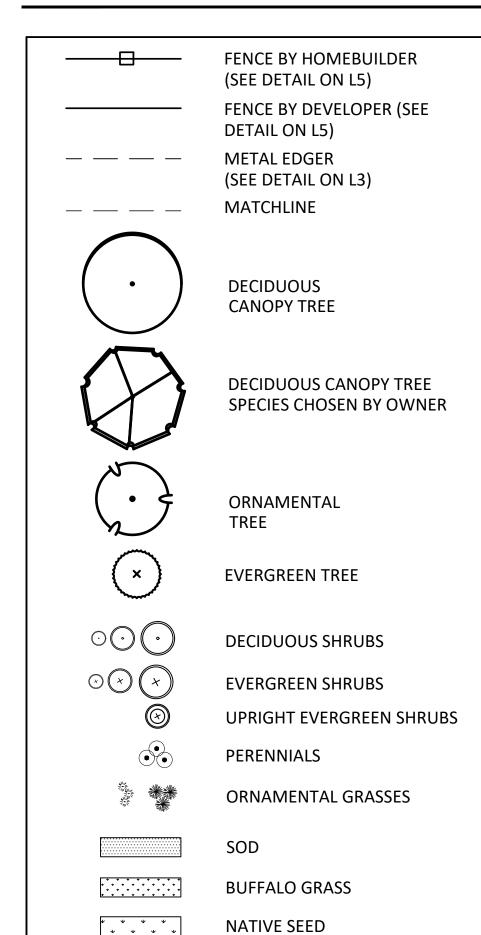
(IN FEET)

1 INCH = 10 FT



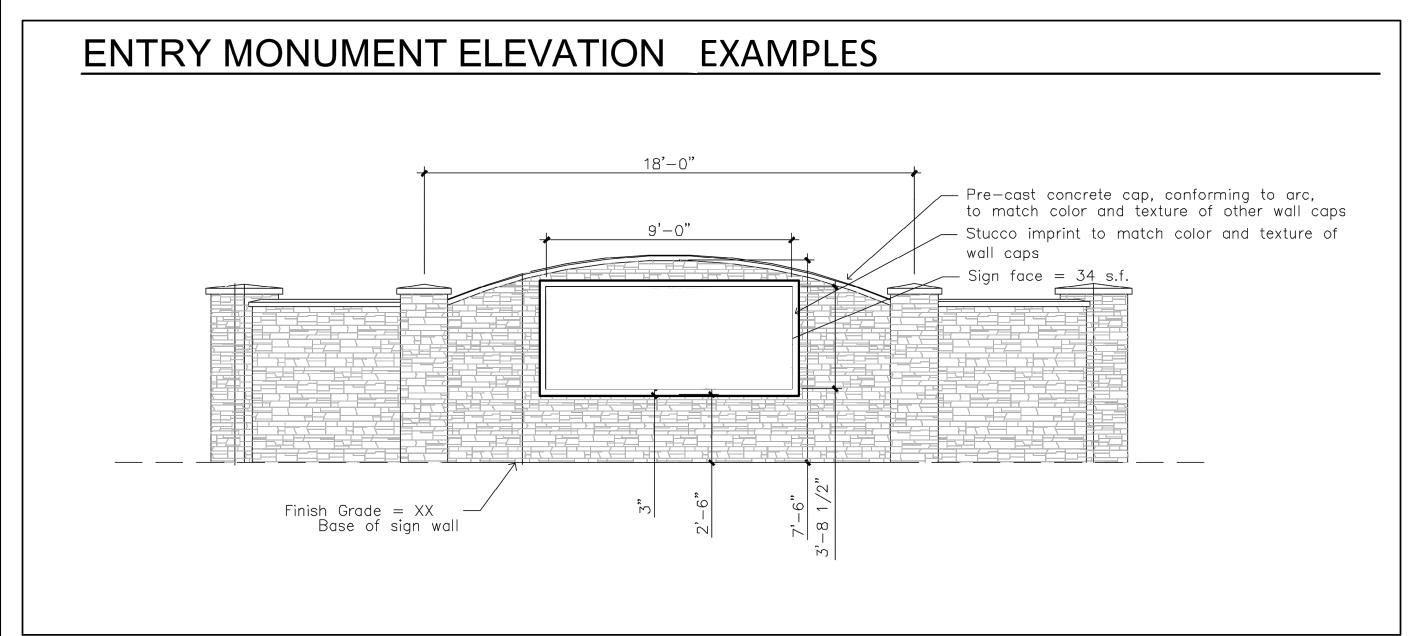
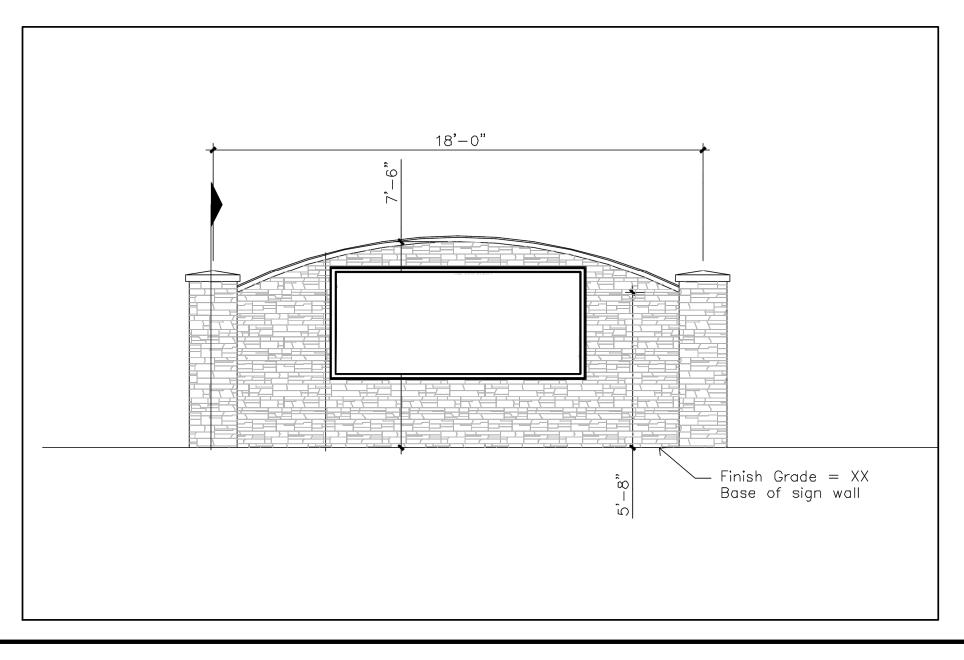
#### LEGEND



## LANDSCAPE PLANT LIST

## DECIDUOUS CANOPY TREES

1 1/2" RIVER ROCK

MSP COMPANIES

**WISTA** 

FOR AND ON BEHALF OF BASELINE CORPORATION

DRAWING SIZE 24" X 36"

DRAWING NAME
3490 LANDSCAPE PLAN.dwg
SHEET 65 OF 68

**SURVEY DATE** 10/02/2020

SURVEY FIRM SURVEY FIRM

DECID	0003 CANOT I TILLS
HTO ESE	HERITAGE OAK EMERALD SUNSHINE ELM
SMH	SHADEMASTER HONELOCUST
IMH EKC	IMPERIAL HONEYLOCUST ESPRESSO KENTUCKY COFFEETREE
BTM	BIGTOOTH MAPLE
SSM	STATE STREET MAPLE
OBE CAT	OHIO BUCKEYE WESTERN CATALPA
СНВ	COMMON HACKBERRY
GKB	GINKGO
SKO LLL	SKYMASTER OAK LITTLE LEAF LINDEN
CHC WWN	COMMON HORSECHESTNUT NIOBE WEEPING WILLOW
PCW	PLAINS COTTONWOOD

#### ORNAMENTAL TREES

TCW THORNLESS COCKSPUR HAWTHORNE

# **EVERGREEN TREES**

ВОР	EMERALD ARROW BOSNIAN PI
PON	PONDEROSA PINE
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# **DECIDUOUS SHRUBS**

GFS	GOLDFLAME SPIREA
BSF	SILVER FOUNTAIN BUTTERFLY BUSH
FRS	FRINGED SAGE

## **EVERGREEN SHRUBS**

MPA	PANCHITO MANZANITA
COJ	COLOGREEN JUNIPER
GGA	GOLDEN GLOBE ARBORVITAE

# ORNAMENTAL GRASSES

BOG	BLUE OAT GRASS
FRG	KARL FOERSTER FEATHER REED GRASS

#### GENERAL

- ALL LANDSCAPING SHALL BE INSTALLED PRIOR TO ISSUANCE OF CERTIFICATE OF OCCUPANCY, UNLESS EXCEPTION HAS BEEN GRANTED BY THE MUNICIPALITY OR COUNTY OFFICIALS.
- 2. THE LANDSCAPE PLANS AND SPECIFICATIONS SHOULD BE FOLLOWED AS CLOSELY AS POSSIBLE. THE OWNER'S REPRESENTATIVE AND LANDSCAPE ARCHITECT SHOULD BE NOTIFIED IF ANY SUBSTITUTIONS OR ALTERATIONS ARE NEEDED.
- 3. THE CONTRACTOR SHALL COORDINATE INSPECTION AND APPROVAL OF ALL MATERIALS AND PRODUCTS PRIOR TO INSTALLATION.
- 4. THE CONTRACTOR IS EXPECTED TO KNOW AND UNDERSTAND ANY LOCAL MUNICIPAL AND COUNTY CODES AND SPECIFICATIONS FOR LANDSCAPE AND IRRIGATION. IN CASES OF DISCREPANCIES THE HIGHER OF THE TWO STANDARDS SHALL HAVE PRECEDENCE.
- 5. THE GENERAL CONTRACTOR IS RESPONSIBLE FOR REMOVING ALL EXISTING VEGETATION (EXCEPT WHERE NOTED TO REMAIN). THE CONTRACTOR SHALL MARK ALL UTILITIES BEFORE BEGINNING PLANTING AND IRRIGATION OPERATIONS. SHOULD ACTUAL UTILITY LOCATION BE SUBSTANTIALLY DIFFERENT THAN THOSE SHOWN ON THE PLANS, THE CONTRACTOR SHALL NOTIFY THE GENERAL CONTRACTOR AND OWNER FOR DIRECTION BEFORE PROCEEDING FURTHER.
- 6. THE LANDSCAPE CONTRACTOR SHALL ENSURE POSITIVE DRAINAGE EXISTS IN ALL LANDSCAPE AREAS. ALL LANDSCAPE AREAS SHALL MAINTAIN SLOPE AWAY FROM FOUNDATIONS PER GEOTECHNICAL REPORT RECOMMENDATIONS. SURFACE DRAINAGE SHALL NOT FLOW TOWARD STRUCTURES AND FOUNDATIONS. NO DAMMING OF WATER SHOULD OCCUR AGAINST SIDEWALKS, CURBS, TURF THATCH, OR OTHER LANDSCAPE MATERIALS. MINIMUM SLOPES ON LANDSCAPE AREAS SHALL BE 2%; MAXIMUM SLOPE SHALL BE 25% UNLESS SPECIFICALLY IDENTIFIED ON THE PLANS OR APPROVED BY THE OWNER'S REPRESENTATIVE.
- 7. INSTALLATION, MAINTENANCE, AND REPLACEMENT OF ALL IMPROVEMENTS SHOWN ON THE APPROVED LANDSCAPE PLAN IN THE PLANNING DEPARTMENT SHALL BE THE RESPONSIBILITY OF THE DEVELOPER, HIS SUCCESSORS AND DELEGATES.
- 8. LANDSCAPING SHALL NOT INTERFERE WITH TRAFFIC VISIBILITY AND THE GENERAL FUNCTION AND SAFETY OF ANY GAS, ELECTRIC, WATER, SEWER, TELEPHONE, CABLE, OR OTHER UTILITY EASEMENT.

#### WARRANTY

- 1. UNLESS SPECIFIED IN THE CONTRACT DOCUMENTS OR SPECIFICATIONS, THE CONTRACTOR SHALL WARRANTY ALL CONTRACTED WORK AND MATERIALS FOR A PERIOD OF ONE (1) YEAR AFTER SUBSTANTIAL COMPLETION HAS BEEN ISSUED FOR THE PROJECT BY THE OWNER'S REPRESENTATIVE.
- 2. CONTRACTOR SHALL PROVIDE LANDSCAPE PROTECTION, MAINTENANCE, AND IRRIGATION INCLUDING SUPPLEMENTAL WATERING PER SPECIFICATIONS UNTIL SUBSTANTIAL COMPLETION HAS BEEN ISSUED UNLESS OTHERWISE INSTRUCTED PER OWNER'S REPRESENTATIVE.

#### **PLANTS**

- 1. THE PLANT SCHEDULE IS FOR CONTRACTOR'S CONVENIENCE ONLY. PLANT QUANTITIES SHOULD BE VERIFIED BY THE CONTRACTOR. GRAPHIC QUANTITIES TAKE PRECEDENCE OVER WRITTEN QUANTITIES. OVERALL PLANT QUANTITY AND QUALITY SHALL BE CONSISTENT WITH THE PLANS.
- THE OWNER'S REPRESENTATIVE AND LANDSCAPE ARCHITECT RETAIN THE RIGHT TO INSPECT AND TAG ALL PLANT MATERIAL PRIOR TO SHIPPING TO THE SITE. THE OWNER'S REPRESENTATIVE AND LANDSCAPE ARCHITECT MAY REJECT PLANT MATERIAL IF IT IS DAMAGED, DISEASED, OR DECLINING IN HEALTH. PLANT MATERIAL SHALL BE HEALTHY, WELL-BRANCHED, AND WELL PROPORTIONED, FREE FROM DISEASE, INJURY, INSECTS, AND WEED ROOTS.
- ALL PLANT MATERIAL SHALL MEET OR EXCEED CURRENT AMERICAN STANDARD FOR NURSERY STOCK ISSUED BY THE AMERICAN ASSOCIATION OF NURSERYMEN, INC. (ANSI Z60.1-1990) AND THE COLORADO NURSERY ACT AND ACCOMPANYING RULES AND REGULATIONS. PLANT MATERIAL GROWN IN USDA HARDINESS ZONES 1, 2, 3, 4, AND 5 IS PREFERRED.
- 4. THE CONTRACTOR SHALL VERIFY PLANT MATERIAL SIZES WITH OWNER'S REPRESENTATIVE PRIOR TO PURCHASING, SHIPPING OR STOCKING OF PLANT MATERIALS. PLANTS SHALL EQUAL OR EXCEED THE MEASUREMENTS SPECIFIED IN THE PLANT LIST, WHICH ARE MINIMUM ACCEPTABLE SIZES.
- 5. THE OWNER'S REPRESENTATIVE MAY OPT TO DOWN OR UPSIZE THE PLANT MATERIAL AT THEIR DISCRETION BASED ON SELECTION, AVAILABILITY, OR ENHANCEMENTS TO THE PROJECT. ALL CHANGES, INCLUDING RE-STOCKING CHARGES, SHALL BE APPROVED IN WRITING PRIOR TO INSTALLATION THROUGH A CHANGE ORDER REQUEST TO OWNER'S REPRESENTATIVE FOR APPROVAL.
- 6. ALL PLANT LOCATIONS ARE DIAGRAMMATIC. ACTUAL LOCATIONS SHALL BE VERIFIED WITH THE LANDSCAPE ARCHITECT OR DESIGNER PRIOR TO PLANTING. THE LANDSCAPE CONTRACTOR SHALL ENSURE THAT ALL REQUIREMENTS OF THE PERMITTING AUTHORITY ARE MET (I.E., MINIMUM PLANT QUANTITIES, PLANTING METHODS, TREE PROTECTION METHODS, ETC.)
- 7. NO SUBSTITUTIONS OF PLANT MATERIALS SHALL BE ALLOWED WITHOUT THE WRITTEN PERMISSION OF THE LANDSCAPE ARCHITECT. IF SOME OF THE PLANTS ARE NOT AVAILABLE, THE LANDSCAPE CONTRACTOR SHALL NOTIFY THE LANDSCAPE ARCHITECT IN WRITING (VIA PROPER CHANNELS).

#### IRRIGATION

- ALL PROPOSED LANDSCAPE AREAS SHALL BE IRRIGATED BY AN AUTOMATIC UNDERGROUND IRRIGATION SYSTEM. REFER TO IRRIGATION PLANS FOR TYPES AND LIMITS OF IRRIGATION. THE SYSTEM SHALL BE PROPERLY ZONED TO SEPARATE PLANT REQUIREMENTS, TURF ZONES, AND NATIVE SEED AREAS.
- 2. CONTRACTOR SHALL REVIEW AND COMPLY WITH ALL GEOTECHNICAL REPORT STIPULATIONS KEEPING ALL IRRIGATION LINES, HEADS, AND EMITTERS OUTSIDE THE MINIMUM DISTANCES SPECIFIED. IN NO CASE SHALL IRRIGATION BE EMITTED

- WITHIN THE MINIMUM DISTANCES OF BUILDING OR WALL FOUNDATIONS.

  3. CONTRACTOR SHALL COORDINATE ALL INSTALLATION OF IRRIGATION EQUIPMENT AND LINES SO THAT IT DOES NOT INTERFERE WITH PLANTING LOCATIONS.

  LANDSCAPE MATERIAL LOCATIONS SHALL HAVE PRECEDENCE OVER IRRIGATION LINES AND EQUIPMENT. IF INSTALLED IN LOCATIONS OBSTRUCTING THE INTENDED USE, THE IRRIGATION EQUIPMENT SHALL BE RELOCATED.
- 4. IRRIGATION ADJACENT TO EXISTING TREES AND LANDSCAPE TO REMAIN SHALL BE HAND DUG.
- 5. EVERGREEN TREES SHALL BE LOCATED A MINIMUM OF FIFTEEN FEET (15') AWAY FROM IRRIGATION ROTOR HEADS.

#### SOIL PREPARATION

- 1. BEFORE COMMENCING WORK, THE LANDSCAPE CONTRACTOR SHALL ENSURE THAT ALL SEWER, WATER, IRRIGATION, GAS, ELECTRIC, CABLE, PHONE AND OTHER PIPELINES OR CONDUITS AND EQUIPMENT ARE LOCATED ON SITE.
- 2. SURFACE GRADING TO INCLUDE REMOVAL OF EXISTING VEGETATION, WEEDS, DEBRIS, CLODS AND ROCKS LARGER THAN ½" FROM THE SITE. DISPOSE OF ACCUMULATED DEBRIS AS DIRECTED BY THE OWNER OR OWNER'S REPRESENTATIVE.
- 3. THE CONTRACTOR SHALL TAKE MEASURES AND ASSUME MAINTENANCE AND MANAGEMENT OF EROSION CONTROL, SURFACE RUNOFF, AND SOIL EROSION AND SEDIMENT FROM THE SITE PER STORM WATER MANAGEMENT PLANS / PROGRAMS IN PLACE.
- 4. THE CONTRACTOR SHALL INSPECT ALL CONDITIONS FOR RETENTION OF WATER IN PLANTING AREAS TO MAKE SURE THERE IS ADEQUATE DRAINAGE IN ALL LANDSCAPE AREAS.
- 5. THE SITE SHOULD BE PROVIDED TO THE CONTRACTOR WITHIN +/- 0.1 FOOT OF FINISH
- GRADE. CONTRACTOR SHALL VERIFY THE ROUGH GRADING AND SITE CONDITIONS.
  7. ALL GRADES SHALL BE WITHIN +/- 1/8" OF FINISHED GRADES AS SHOWN ON THE PLANS.
- 8. THE CONTRACTOR SHALL BE RESPONSIBLE FOR CREATING SUITABLE SOIL MEDIUM THAT ENSURES HEALTHY PLANT GROWTH. SOIL SAMPLES ARE RECOMMENDED FOR ANALYSIS OF ORGANIC MATTER RECOMMENDATIONS REQUIRED FOR THE SOIL FOR HEALTHY PLANT GROWTH.
- 9. TO THE MAXIMUM EXTENT FEASIBLE, TOPSOIL THAT IS REMOVED DURING CONSTRUCTION ACTIVITY SHALL BE CONSERVED FOR LATER USE ON AREAS REQUIRING REVEGETATION AND LANDSCAPING.
- 10. BEFORE PLANTS ARE INSTALLED, ALL LANDSCAPE AREAS SHALL BE THOROUGHLY LOOSENED TO A DEPTH OF 8"-12" AND AMENDED PER SPECIFICATIONS AND MUNICIPAL REQUIREMENTS.
- 11. ALL LANDSCAPE AREAS SHALL RECEIVE ORGANIC SOIL PREPARATION AT 5 cu.yrds/1,000sf OR AS NOTED IN THE SOIL SAMPLE ANALYSIS.

#### TREES

- 1. TREES SHALL NOT BE LOCATED IN DRAINAGE SWALES, DRAINAGE AREAS, OR UTILITY EASEMENTS. CONTACT OWNER'S REPRESENTATIVE FOR RELOCATION OF PLANTS IN QUESTIONABLE AREAS PRIOR TO INSTALLATION.
- 2. TREE CENTERS SHALL NOT BE PLACED CLOSER THAN EIGHT FEET (8') FOR EVERGREEN TREES AND SIX FEET (6') FOR ORNAMENTAL TREES FROM A SIDEWALK, PARKING, STREET OR DRIVE LANE. NOTIFY OWNER'S REPRESENTATIVE IF TREE LOCATIONS CONFLICT WITH THESE STANDARDS.
- EVERGREEN TREES SHALL NOT BE USED IN THE TREE LAWN OR WITHIN EIGHT FEET (8') OF A PUBLIC WALK.
- 4. ALL TREES ARE TO BE STAKED AND GUYED FOR A PERIOD OF ONE (1) YEAR. THE CONTRACTOR SHALL BE RESPONSIBLE FOR REMOVING STAKES AT THE END OF ONE (1) YEAR FROM ACCEPTANCE OF LANDSCAPE INSTALLATION PER APPROVAL BY OWNER'S REPRESENTATIVE.
- 5. ALL TREES IN SEED OR TURF AREAS SHALL RECEIVE MULCH RINGS. ALL TREE RINGS AND PERENNIAL BEDS SHALL BE MULCHED WITH A 3" DEPTH OF GORILLA HAIR CEDAR MULCH.

#### MULCH & EDGING

- PRIOR TO THE PLACEMENT OF MULCH AND WEED FABRIC, A GRANULAR, PRE-EMERGENT, WEED CONTROL AGENT SHALL BE ADDED TO ALL PLANTING BEDS IN ACCORDANCE WITH THE MANUFACTURER'S INSTRUCTION, EXCEPT AROUND ORNAMENTAL GRASSES.
- 2. SHRUB, GROUNDCOVER AND PERENNIAL BEDS ARE TO BE CONTAINED BY 4" x 14 GAUGE GALVANIZED, GREEN, ROLL TOP, INTERLOCKING TYPE EDGER, SURE-LOC OR APPROVED EQUAL. EDGER IS NOT REQUIRED WHEN ADJACENT CURBS, WALLS, WALKS OR SOLID FENCES WITHIN 3" OF PRE-MULCHED FINAL GRADE. EDGER SHALL NOT BE REQUIRED TO SEPARATE MULCH TYPES UNLESS SPECIFIED ON THE PLANS. PERFORATED EDGER IS ONLY USED BETWEEN SOD/NATIVE GRASS AND MULCH AREAS WHERE PONDING OF WATER OCCURS. EDGER SHALL NOT RESTRICT THE FREE FLOW OF DRAINAGE OR DAM WATER IN ANY CASE.
- 3. ALL SHRUB BEDS ARE TO BE MULCHED WITH MIN. FOUR INCH (4") DEPTH OF 1"-2" ROUNDED RIVER ROCK MULCH OVER SPECIFIED GEOTEXTILE WEED CONTROL FABRIC (RE: PLANS). NO WEED CONTROL FABRIC IS REQUIRED IN GROUNDCOVER, ANNUAL OR PERENNIAL AREAS. CONTRACTOR TO SUBMIT SAMPLE OF ALL MULCHES TO LANDSCAPE ARCHITECT AND OWNER FOR APPROVAL PRIOR TO CONSTRUCTION.
- 4. ALL 5' NON-IRRIGATED CLEAR BOUNDARY ZONES SHOULD BE MULCHED WITH A FOUR INCH (4") DEPTH OF ROUNDED RIVER ROCK MULCH OVER SPECIFIED GEOTEXTILE WEED CONTROL FABRIC.
- 5. NO EXPOSED GROUND SHALL BE LEFT SHOWING ANYWHERE ON THE PROJECT AFTER MULCH HAS BEEN INSTALLED.
- 6. SHREDDED CEDAR WOOD MULCH SHALL BE INSTALLED AT THE BASE OF EACH PLANT AS FOLLOWS: TREES, 48" DIAMETER CIRCLE; SHRUBS, 18" DIAMETER CIRCLE AT A 3" DEPTH.

#### LANDSCAPE PLANT LIST

	QTY.	COMMON NAME	BOTANICAL NAME	SIZE & COND.	NOTES
DECIDU	OUS CANOPY TREES	S ————————————————————————————————————			
HTO	27	HERITAGE OAK	QUERCUS ROBUR X MACROCARPA 'CLEMENS'	2" CAL. B&B	
ESE SMH	22	EMERALD SUNSHINE ELM SHADEMASTER HONEYLOCUST	ULMUS PROPINQUA 'JFS-BIEBERICH' GLEDITSIA TRIACANTHOS INERMIS 'SHADEMASTER'	2" CAL. B&B	
IMH	32 23	IMPERIAL HONEYLOCUST	GLEDITSIA TRIACANTHOS INERNIS SHADENIASTER GLEDITSIA TRIACANTHOS INERNIS 'IMPCOLE'	2" CAL. B&B 2" CAL. B&B	
EKC	22	ESPRESSO KENTUCKY COFFEETREE	GYMNOCLADUS DIOICUS 'ESPRESSO'	2" CAL. B&B	
BTM	21	BIGTOOTH MAPLE	ACER GRANDIDENTATUM	2" CAL. B&B	
SSM	16	STATE STREET MAPLE	ACER MIYABEI 'MORTON' STATE STREET	2" CAL. B&B	
OBE CAT	16 20	OHIO BUCKEYE WESTERN CATALPA	AESCULUS GLABRA CATALPA SPECIOSA	2" CAL. B&B 2" CAL. B&B	
CHB	20	COMMON HACKBERRY	CELTIS OCCIDENTALIS	2" CAL. B&B	
GKB	10	GINKGO	GINKGO BILOBA	2" CAL. B&B	
SKO	4	SKYMASTER OAK	QUERCUS ROBUR 'PYRAMICH'	2" CAL. B&B	
LLL	5	LITTLE LEAF LINDEN	TILIA CORDATA	2" CAL. B&B	
CHC WWN	5	COMMON HORSECHESTNUT NIOBE WEEPING WILLOW	QUERCUS ROBUR 'PYRAMICH' SALIX ALBA 'TRISTIS'	2" CAL. B&B	
PCW	2	PLAINS COTTONWOOD	POPULUS DELTOIDES	2" CAL. B&B 2" CAL. B&B	
1 000	J	1 L/ MINO OOT FORWOOD	1 Of OLOO BELTOIBEO	2 CAL. DOD	
ORNAN	MENTAL TREES —				
TCW	5	THORNLESS COCKSPUR HAWTHORNE	CRATAEGUS CRUS-GALI INERMIS	1.5" CAL. B&B	
DECIDI	LIOUS TREES (BACI	KYARD TREES TO BE CHOSI	EN BY HOMEOWNER FROM THIS LIS	ST)	
	OCCO TREES (Brio			•	
CCP	-	CHANTICLEER PEAR PRINCESS KAY PLUM	PYRUS CALLERYANA PRUNUS CERASIFERA 'NEWPORT'	2" CAL., B&B 2" CAL., B&B	
PKP SPR	-	SPRING SNOW CRABAPPLE	MALUS x 'SPRING SNOW'	2" CAL., B&B	
MAA	- -	MANCHURIAN CHERRY	PRUNUS MAACKII	2" CAL., B&B	
SBC	-	SHADBLOW SERVICEBERRY	AMELANCHIER CANADENSIS	2" CAL., B&B	
EVERG	REEN TREES				
BOP	10	EMERALD ARROW BOSNIAN PINE	PINUS LEUCODERMIS 'EMERALD ARROW'	6' HT. B&B	
PON	3	PONDEROSA PINE	PINUS PONDEROSA	6' HT. B&B	
PVP	9	VANDERWOLF'S LIMBER PINE	PINUS FLEXILIS 'VANDERWOLF'S PYRAMID'	6' HT. B&B 6' HT. B&B	
RMJ CBS	9 6	ROCKY MOUNTAIN JUNIPER COLORADO SPRUCE	JUNIPERUS SCOPULORUM PICEA PUNGENS 'GLOBOSA'	6' HT. B&B	
	•				
DECIDI	UOUS SHRUBS —				
GFS	52	GOLDFLAME SPIREA	SPIRAEA x BUMALDA 'GOLDFLAME'	5 GAL. CONT.	
BSF	2	SILVER FOUNTAIN BUTTERFLY BUSH	BUDDLEJA ALTERNIFOLIA 'ARGENTEA'	5 GAL. CONT.	
FRS	12	FRINGED SAGE	ARTEMISIA FRIGIDA	5 GAL. CONT.	
F\/FRA	GREEN SHRUBS —				
MPA	75	PANCHITO MANZANITA	ARCTOSTAPHYLOS 'PANCHITO'	5 GAL. CONT.	
COJ	30	COLOGREEN JUNIPER	JUNIPERUS SCOPULORUM 'COLOGREEN'	5 GAL. CONT.	
GGA	61	GOLDEN GLOBE ARBORVITAE	THUJA OCCIDENTALIS 'GOLDEN GLOBE'	5 GAL. CONT.	
	MENTAL GRASSES				
ORNAN	040	BLUE OAT GRASS	HELICTOTRICHON SEMPERVIRENS 'SAPHIRSPRUDEL'		
BOG	216				
	35	KARL FOERSTER FEATHER REED GRASS	CALAMAGROSTIS ACUTIFLORA 'KARL FOERSTER'	1 GAL. CONT.	
BOG	35	KARL FOERSTER FEATHER REED GRASS	CALAMAGROSTIS ACUTIFLORA 'KARL FOERSTER'	1 GAL. CONT.	

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COMPANIES

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PREPARED UNDER THE DIRECT SUPERVISION OF

FOR AND ON BEHALF OF BASELINE CORPORATION

NITIAL SUBMITTAL 5/10/2021

DRAWING SIZE 24" X 36"

3490 LANDSCAPE PLAN.dwg
SHEET 66 OF 68

L04

SURVEY FIRM SURVEY FIRM JOB NO.

DRAWING NAME

SURVEY DATE 10/02/2020

CO3490

N:\co3490 — Summerfield — Keenesburg\Drawings\Landscape\3490 LANDSCAPE PLAN.dwg, 6/30/2021 9:24:18 AM, Ryan Schu

1 SPECIFIED MULCH

AMENDED SOIL IN PLANTING BED 2 PER SPECIFICATIONS. TILL SOIL TO A DEPTH OF EIGHT INCHES.

(3) FINISH GRADE (TOP OF MULCH)

4 AMENDED TOPSOIL

5 EXISTING SUBGRADE


1. BROKEN OR CRUMBLING ROOT-BALLS WILL BE REJECTED 2. CARE SHOULD BE TAKEN NOT TO

DAMAGE THE SHRUB OR

ROOT-BALL WHEN REMOVING IT FROM ITS CONTAINER 3. ALL JUNIPERS SHOULD BE PLANTED SO THE TOP OF THE ROOT-BALL OCCURS ABOVE THE FINISH GRADE OF THE MULCH

4. DIG PLANT PIT TWICE AS WIDE AND HIGH AS THE CONTAINER

LAYER

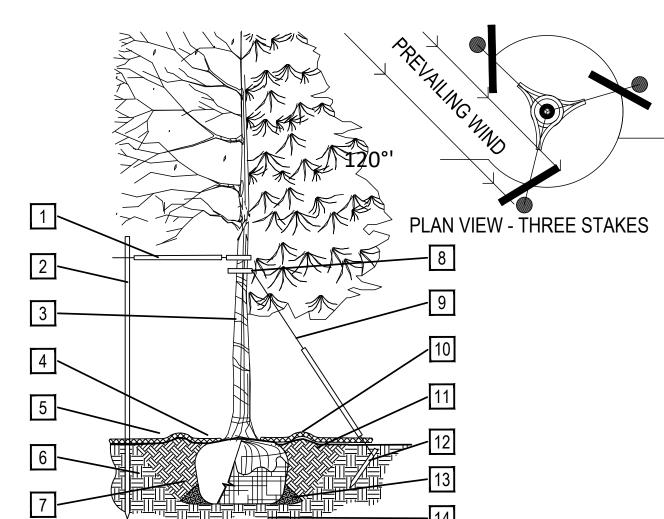

ROOT BALL DIAMETER

TREE PLANTING DETAIL

PRUNING NOTES:

ALL PRUNING SHALL COMPLY WITH ANSI A300 STANDARDS. DO NOT HEAVILY PRUNE THE TREE AT PLANTING. PRUNE ONLY

 ${\bf 120}^{\bf GROSSOVER\ LIMBS,\ CO-DOMINANT\ LEADERS\ AND\ BROKEN\ BRANCHES.}$  SOME INTERIOR TWIGS AND LATERAL BRANCHES MAY BE PRUNED. HOWEVER, DO NOT REMOVE THE TERMINAL BUDS OF BRANCHES THAT EXTEND TO THE EDGE OF THE CROWN.

STAKING NOTES:

FINISHED GRADE - TOP OF SOD

SHALL BE FLUSH WITH TOP OF

STEEL EDGER - DRILL (16) 1/2" DIA. HOLES 1" O.C. MIN. AT ALL

DRAINING AREAS IN ORDER TO ENSURE ADEQUATE DRAINAGE

1. THERE SHALL BE NO EXPOSED

2. CONTRACTOR SHALL INSTALL

STAKES AS REQUIRED BY THE

(5) LOW POINTS OR POORLY

THATCH LAYER AND TOP OF

1 MULCH OR CRUSHER FINES

**EDGER** 

4 SUBGRADE

6 EDGER STAKE

MANUFACTURER.

SHARP / JAGGED EDGES.

2 TURF THATCH

(3) AMENDED SOIL PER SPECIFICATIONS

STAKE TREES PER FOLLOWING SCHEDULE, THEN REMOVE AT END OF FIRST GROWING SEASON.

1-1/2" CALIPER SIZE - MIN. 1 STAKE ON SIDE OF PREVAILING WIND (GENERALLY N.W. SIDE)

1.2  $1-\frac{1}{2}$  - 3" CALIPER SIZE - MIN. 2 STAKES - ONE ON N.W. SIDE, ONE ON S.W. SIDE (OR PREVAILING WIND SIDE AND 180° FROM THAT SIDE)

1.3 3" CALIPER SIZE AND LARGER - 3 STAKES PER DIAGRAM WIRE OR CABLE SHALL BE MIN. 12 GAUGE, TIGHTEN WIRE OR CABLE ONLY ENOUGH TO KEEP FROM SLIPPING. ALLOW FOR SOME TRUNK MOVEMENT. NYLON STRAPS SHALL BE LONG ENOUGH TO ACCOMMODATE 1-1" OF GROWTH AND BUFFER ALL BRANCHES FROM WIRE.

1 PLACE MIN. ½" PVC PIPE AROUND EACH WIRE. EXPOSED WIRE SHALL BE MAX. 2" EACH SIDE

(2) 6 FT. UNTREATED WOOD POST (MIN. 1.5" DIAMETER). ALL SHALL BE DRIVEN OUTSIDE ROOTBALL AND IN UNDISTURBED SOIL.

(3) TREE WRAP TO BE INSTALLED ONLY FROM OCTOBER 1 THROUGH APRIL 30. (DECIDUOUS ONLY)

(4) PLANT TREE SO THAT FIRST ORDER MAJOR ROOT IS 1"-2" ABOVE FINAL GRADE.

(5) 3" DEEP WOOD MULCH RING PLACED A MINIMUM OF 4 FT. IN DIAMETER. DO NOT PLACE MULCH IN CONTACT WITH TREE TRUNK (FINISHED GRADE REFERENCES TOP OF MULCH).

(6) 1:1 SLOPE ON SIDES OF PLANTING

(7) REMOVE ALL TWINE, ROPE, BURLAP AND WIRE FROM ENTIRE ROOT BALL AND TRUNK

GALVANIZED WIRE, MIN. 12 GAUGE CABLE - TWIST WIRE ONLY TO KEEP FROM SLIPPING.

4-6" HIGH WATER SAUCER IN NON-TURF AREAS. (1) BACKFILL WITH BLEND OF

**EXISTING SOIL AND A MAXIMUM** 20% (BY VOLUME) ORGANIC MATERIAL. WATER THOROUGHLY WHEN BACKFILLING

2 FT. STEEL T-POST. ALL SHALL BE DRIVEN BELOW GRADE AND **OUTSIDE ROOTBALL IN** UNDISTURBED SOIL.

PLACE SOIL AROUND ROOT BALL FIRMLY, DO NOT COMPACT OR TAMP. SETTLE SOIL WITH WATER TO FILL ALL AIR POCKETS.

14) PLACE ROOT BALL ON UNDISTURBED SOIL TO PREVENT SETTLEMENT.

SCALE: 3/16" = 1'-0"

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FOR AND ON BEHALF OF BASELINE CORPORATION

DRAWING SIZE 24" X 36"

3490 LANDSCAPE PLAN.dwg **SHEET** 67 **OF** 68

SURVEY FIRM

SURVEY FIRM

JOB NO.

SURVEY DATE 10/02/2020

CO3490

SHRUB PLANTING

O.C. SPACING

SCALE: 1-1/2" = 1'-0"

2 AMENDED PLANTING BED TILLED TO A DEPTH OF 6"

3 CENTER OF PLANT

WHEN PLANTED ON A CURVE ORIENT ROWS TO FOLLOW

THE LONG AXIS OF AREAS WHERE PLANTS ARE MASSED.

① SPECIFIED MULCH TO A DEPTH OF 4"

PERENNIAL / ORNAMENTAL GRASS LAYOUT

SCALE: 1" = 1'-0"

4" DEPTH MIN. COMPACTED CRUSHER FINES WITH STABILIZER / TACKIFIER. REF: MATERIAL SCHEDULE SHEET L-X

2 SLOPE ADJACENT GRADE AWAY

COMPACTED SUBGRADE PER (3) GEOTECHNICAL RECOMMENDATIONS. METAL EDGER TO DIVIDE

4 CRUSHER FINES FROM LANDSCAPE BED AND/OR SOD

**COMPACTION NOTES:** 


COMPACT WET IN (2) 2" LIFTS FOR BEST RESULTS.

USE A SMALL (4') RIDING ROLLER TO COMPACT WHERE POSSIBLE.

CROWN CRUSHER FINES TRAIL IN FLAT AREAS (AS SHOWN). CROSS-SLOPE TRAIL AT 1-2% WITH GRADE WHERE TOPOGRAPHY DICTATES.

CRUSHER FINES

SCALE: 3/4" = 1'-0"

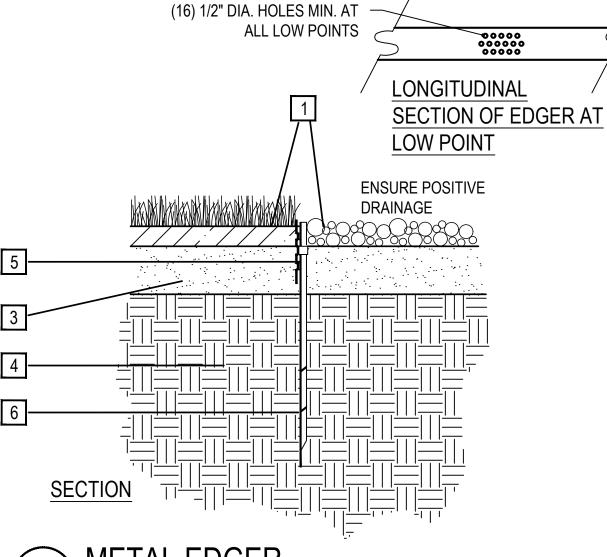


METAL EDGER

SCALE: 1" = 1'-0"






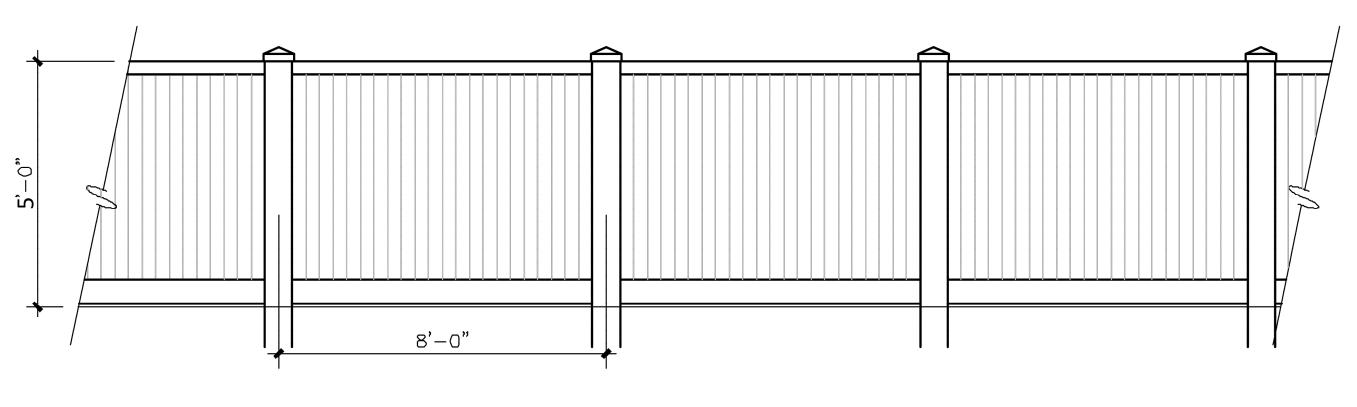

## HOMEOWNER REAR FENCE

N.T.S.

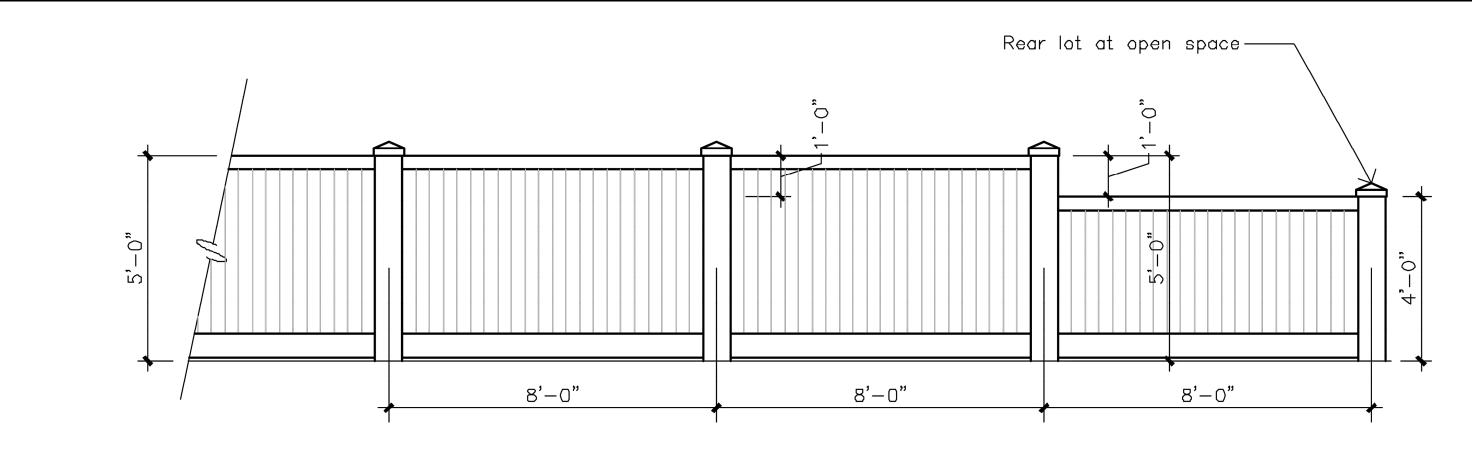

SIDE YARD FENCE AT REAR YARDS ADJACENT TO OPEN SPACE

## NATURE PLAY EXAMPLES







