#### **GEOTECHNICAL ENGINEER:**

OLSSON 3990 FOX STREET DENVER, CO 80216 CONTACT: LINDSAY TITA PH: (303) 237-2072 EMAÌL: Itita@olsson.com

# LANDSCAPE ARCHITECT:

7250 N. 16TH STREET SUITE 210 PHOENIX, AZ 85020 CONTACT: AMY SCHWENNER, PLA PH: (602) 748-1000 EMAÌL: aschwenner@olsson.com

SURVEYOR: OLSSON 1525 RALEIGH ST, SUITE 400 DENVER, CO 80204 CONTACT: NICHOLAS SCHRADER PH: (303) 347-3114 EMAÎL: nschrader@olsson.com

500 COOPERATIVE WAY BRIGHTON, CO 80603 CONTACT: HECTOR AVENDANO PH: (720) 685-5623 EMAÎL: havendano@unitedpower.com

WATER / SANITARY SEWER /

STORM SEWER: TOWN OF KEENESBURG PUBLIC WORKS 91 W. BROADWAY AVENUE KEENESBURG, CO 80643 CONTACT: MARK GRAY PH: (303) 437-4970 EMAIL: pwdirector@rtebb.net

#### TELEPHONE: CENTURYLINK CONTACT: BOB RAMSEY PH: (720) 244-3078 EMAÌL: bob.ramsey@lumen.com

GAS: ATMOS ENERGY 710 COUNTY ROAD 59 KEENESBURG, CO 80643

## STATE DEPT. OF TRANS.:

10601 W. 10TH ST. GREELEY, CO 80634 CONTACT: TIM BILOBRAN PH: (970) 350-2163 EMAÌL: timothy.bilobran@state.co.us

### **BENCHMARKS**:

BM#1-3" BRASS CAP IN CONCRETE, STAMPED "NATIONAL GEODETIC SURVEY ACD1" LYING FIVE FEET WEST OF A CONCRETE IRRIGATION DITCH NEAR THE INTERSECTION OF COUNTY ROAD 18 AND NORTH CEDAR STREET, AND THIRTY FEET NORTH OF THE CENTERLINE OF COUNTY ROAD 18. ELEV.=5015.39 (NAVD 88)

BM#2-#5 REBAR WITH RED PLASTIC CAP SET FLUSH WITH THE GROUND ALONG THE SOUTH SIDE OF THE PROJECT ON THE SOUTH SIDE THE PROJECT BETWEEN PIPPIN LANE AND THE ON RAMP. ELEV.=4996.68 (NAVD 88)

#### FLOOD ZONE:

ACCORDING TO F.E.M.A. FLOOD INSURANCE RATE MAP NUMBER: 08123C2157E, EFFECTIVE DATE: JANUARY 20, 2016, THIS PROPERTY LIES IN ONE OF THE FOLLOWING FLOOD ZONES: - OTHER AREA - ZONE X: AREAS DETERMINED TO BE OUTSIDE THE 0.2% ANNUAL CHANCE FLOODPLAIN.

## **BASIS OF BEARINGS:**


BEARINGS BASED ON THE NORTH LINE OF THE NORTHWEST QUARTER OF SECTION 26, TOWNSHIP 2 NORTH, RANGE 64 WEST OF THE 6TH P.M. BEING MONUMENTED AT THE NORTHWEST CORNER OF THE SAID NORTHWEST QUARTER BY FOUND 3.25" ALUMINUM CAP IN RANGE BOX STAMPED "2014 LS 37971" FROM WHICH THE NORTHEAST CORNER OF SAID NORTHWEST QUARTER, BEING MARKED BY A FOUND 2.5" ALUMINUM CAP IN RANGE BOX (BEING ILLEGIBLE) BEARS N89°26'13"E, A DISTANCE OF 2638.80 FEET.


## LEGAL DESCRIPTION:

LOT 5, MARKET STREET BUSINESS CENTER, TOWN OF KEENESBURG, COUNTY OF WELD, STATE OF COLORADO



WHERE & MEANS MORE.

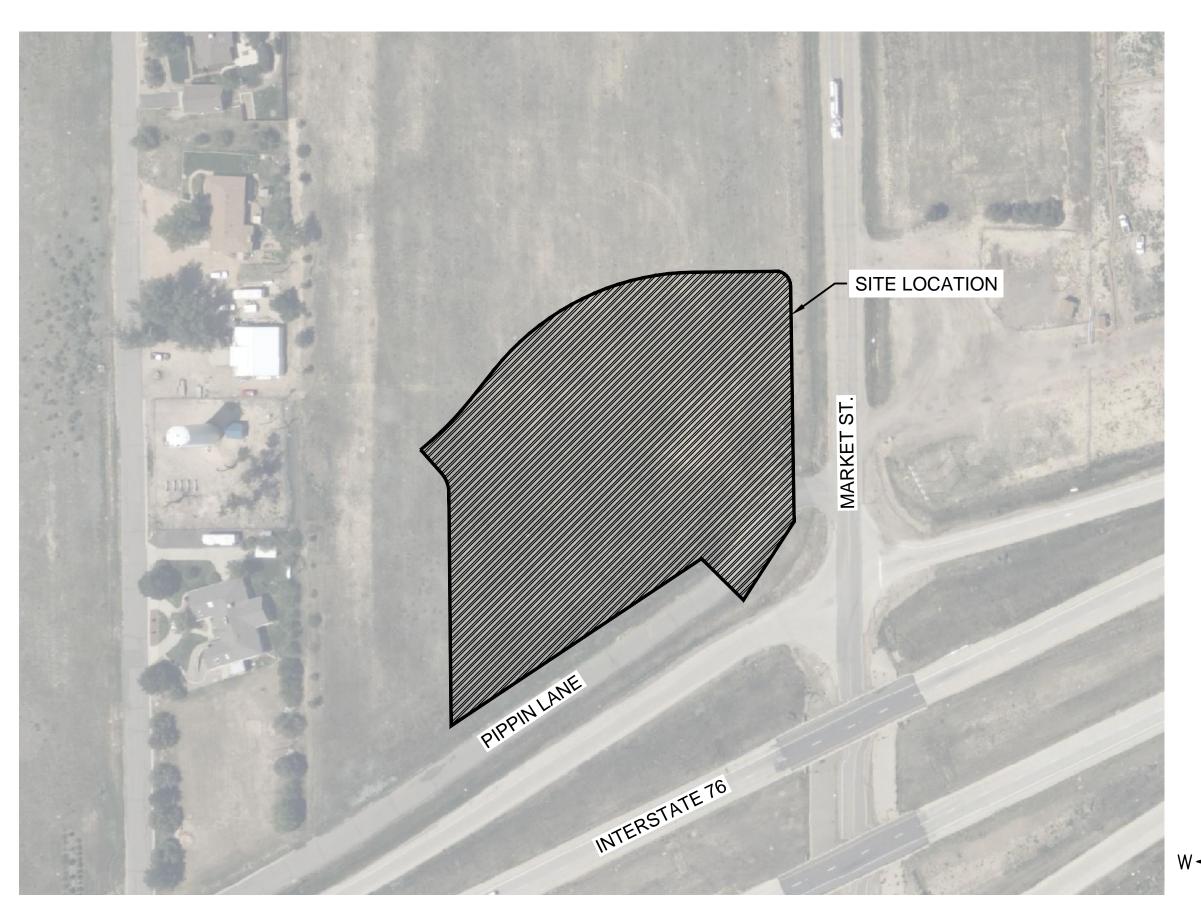

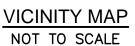

ZONING INFORMATION					
CH - HIGHWAY COMMERCIAL					
MINIMUM LOT AREA	10,000 S.F.				
MINIMUM LOT WIDTH	50'				
SITE AREA PER UNIT	NO REQUIREMENT				
FRONT YARD SETBACK (NORTH)	25'				
LEFT SIDE YARD SETBACK (WEST)	10'				
RIGHT SIDE YARD SETBACK (EAST)	10'				
REAR YARD SETBACK (SOUTH)	10'				
MAXIMUM HEIGHT	35'				
MAXIMUM BUILDING COVERAGE	80%				
MAXIMUM IMPERVIOUS COVERAGE	80%				
MAXIMUM FLOOR AREA RATIO	0.75				

DEVELOPMENT PLANS STORE #2906 240 MARKET STREET KEENESBURG, CO 80643 MARKET ST. & WELD COUNTY RD. 18 KEENESBURG, CO

REV	SHEET INDEX					
	1	COVER SHEET	C0.0			
	2	OVERALL SITE PLAN	C1.0			
	3	ENLARGED SITE PLAN	C1.1			
	4	ENLARGED SITE PLAN	C1.2			
	5	GRADING PLAN	C2.0			
	6	DRAINAGE PLAN	C2.1			
	7	PRELIMINARY UTILITY PLAN	C3.1			
	8	LANDSCAPE PLAN	L1.0			
	9	LANDSCAPE DETAILS & NOTES	L1.1			
	10	PHOTOMETRIC PLAN	SE1.1			
	11	EXTERIOR ELEVATIONS	A1.1			
	12	CANOPY ELEVATIONS	A1.2			
	13	DIESEL CANOPY ELEVATIONS	A1.3			
	14	TRASH ENCLOSURE ELEVATIONS	A1.4			
	15	SIGN ELEVATIONS	A1.5			

OUTE DATA							
SITE DATA							
STORE	TYPE	MARKETPLACE					
CANOPY / DISPENS	ER ARRANGEMENT	FUEL - 8 DISPENSERS (DOUBLE) DIESEL - 3 DISPENSERS					
TYPE (	OF USE	CONVENIENCE STORE WITH FUEL					
	HIGHEST BUILDING ELEVATION	22'-7" (MIN.)					
HEIGHT	TOP OF PARAPET ELEVATION	21'-0" & 17'-10" (MIN.)					
	CANOPY	HIGHEST ELEVATION 20'-10" (MIN.) 17'-6" TOP OF FASCIA (MIN.) 15'-6" CLEARANCE (MIN.)					
GROSS FL	OOR AREA	5,997 S.F.					
GROSS CAI	NOPY AREA	7,299 S.F.					
GROSS L	OT AREA	±118,931 S.F. ±2.73 ACRES					
F.	∖R	0.112					
BUILDING (	COVERAGE	5,997 S.F. (5.0%)					
LANDSCAPE	COVERAGE	34,284 S.F. (28.8%)					
	VE/SIDEWALK RAGE	78,650 S.F. (66.2%)					
BICYCLE	PARKING	1					
	STANDARD	19					
REQUIRED PARKING	ADA	1					
REQUIRED PARKING	TOTAL	20					
	PARKING R	ATIO = 1 CAR / 300 S.F.					
	STANDARD	29					
	ADA	2					
PROVIDED PARKING	DIESEL	5					
	TOTAL	36					
	PARKING RATIO = 1.80 CARS / 300 S.F.						



TOWN PLANNING APPROVAL

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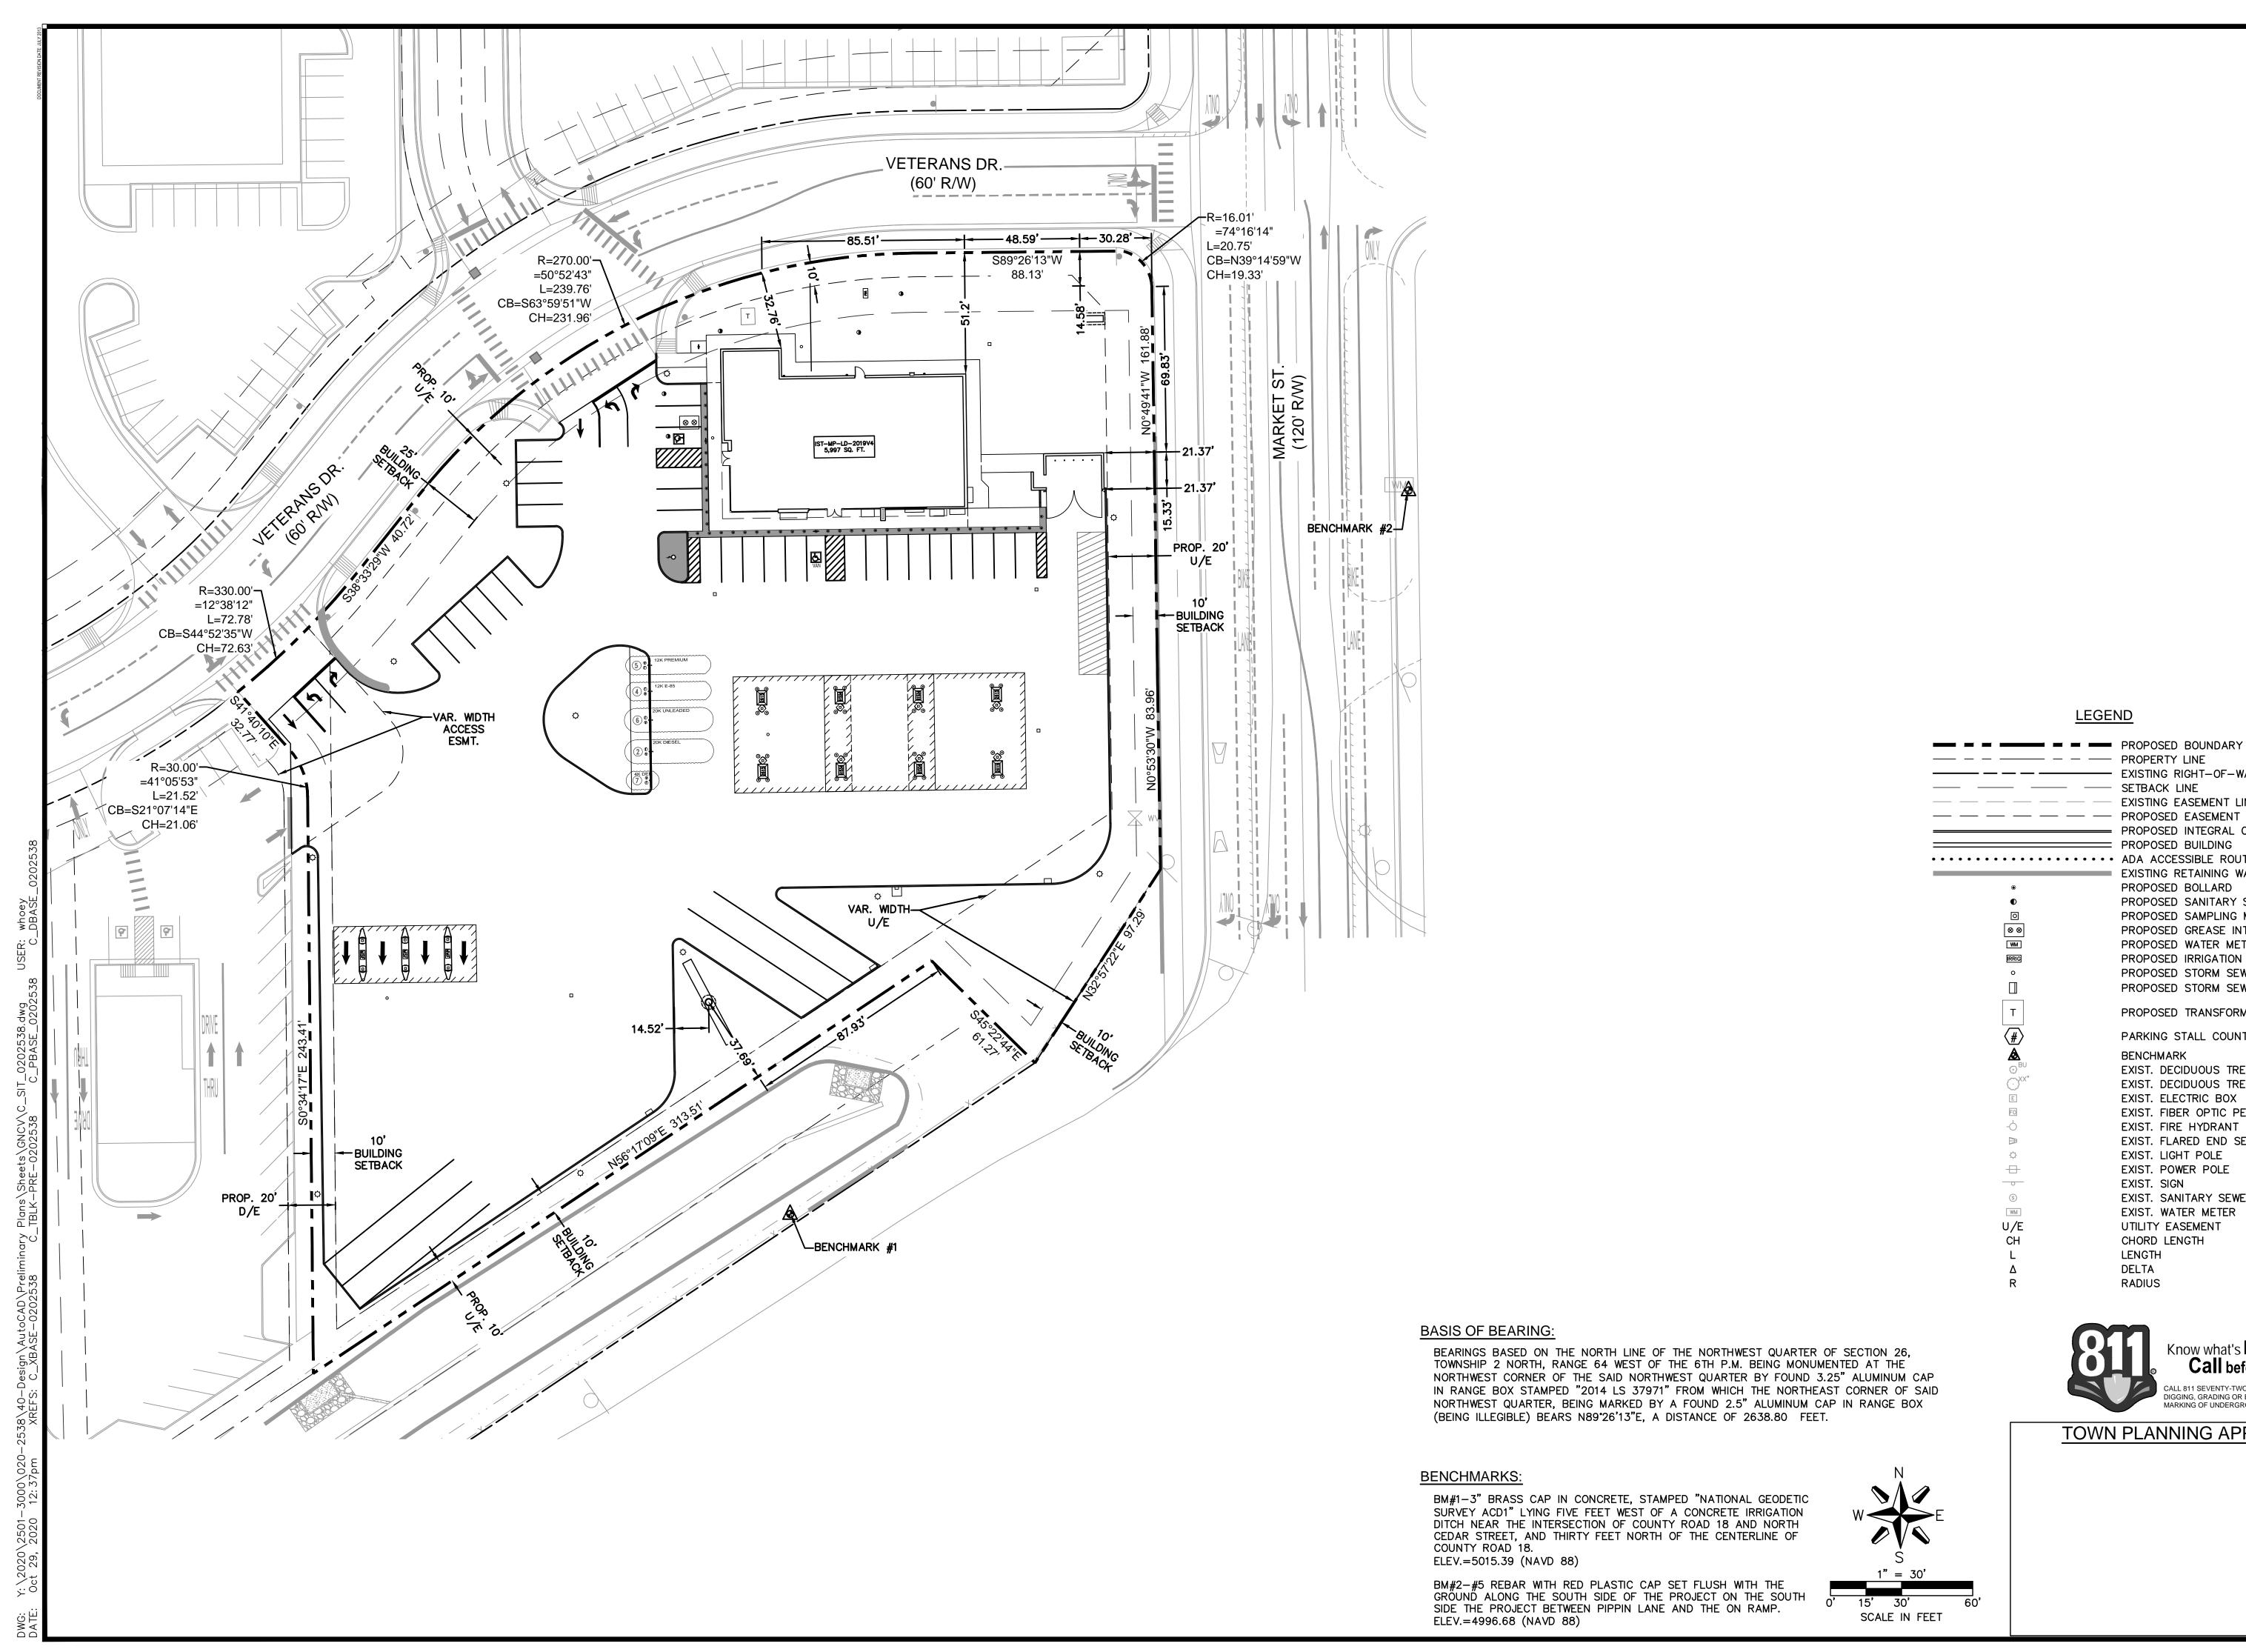


1459 Grand Avenue Des Moines, Iowa 50309 P: 515-226-0128 F: 515-223-9873

KEENESBURG SHEET 240 MARKET COVER #2906

KG PROJECT TEAM: RDM: TOM CARRICO SDM: RYAN HALDER CPM: PERRY DEPHILLIPS

10/23/2020



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00

SBURG,

KEENE

#2906

KG PROJECT TEAM:

RDM: TOM CARRICO

SDM: RYAN HALDER

CPM: PERRY DEPHILLIPS

STREET

MARKET

40

PLAN

SITE

— — PROPOSED EASEMENT LINE — PROPOSED INTEGRAL CONCRETE CURB PROPOSED BUILDING • • • • • • • • • • • • • • • • ADA ACCESSIBLE ROUTE EXISTING RETAINING WALL PROPOSED BOLLARD PROPOSED SANITARY SEWER CLEANOUT PROPOSED SAMPLING MANHOLE PROPOSED GREASE INTERCEPTOR PROPOSED WATER METER PROPOSED IRRIGATION METER PROPOSED STORM SEWER CLEANOUT PROPOSED STORM SEWER STRUCTURE

PROPOSED TRANSFORMER

EXISTING RIGHT—OF—WAY LINE

PARKING STALL COUNT PER BAY BENCHMARK EXIST. DECIDUOUS TREE EXIST. DECIDUOUS TREE EXIST. ELECTRIC BOX EXIST. FIBER OPTIC PEDESTAL EXIST. FIRE HYDRANT EXIST. FLARED END SECTION EXIST. LIGHT POLE EXIST. POWER POLE EXIST. SIGN

EXIST. SANITARY SEWER MANHOLE EXIST. WATER METER UTILITY EASEMENT CHORD LENGTH LENGTH

DELTA RADIUS

> Know what's **below.** Call before you dig. CALL 811 SEVENTY-TWO HOURS PRIOR TO DIGGING, GRADING OR EXCAVATING FOR THE MARKING OF UNDERGROUND MEMBER UTILITIES.

TOWN PLANNING APPROVAL


**LEGEND** 

— PROPERTY LINE

— — EXISTING EASEMENT LINE

10/23/2020

SHEET NUMBER: 2 OF 15

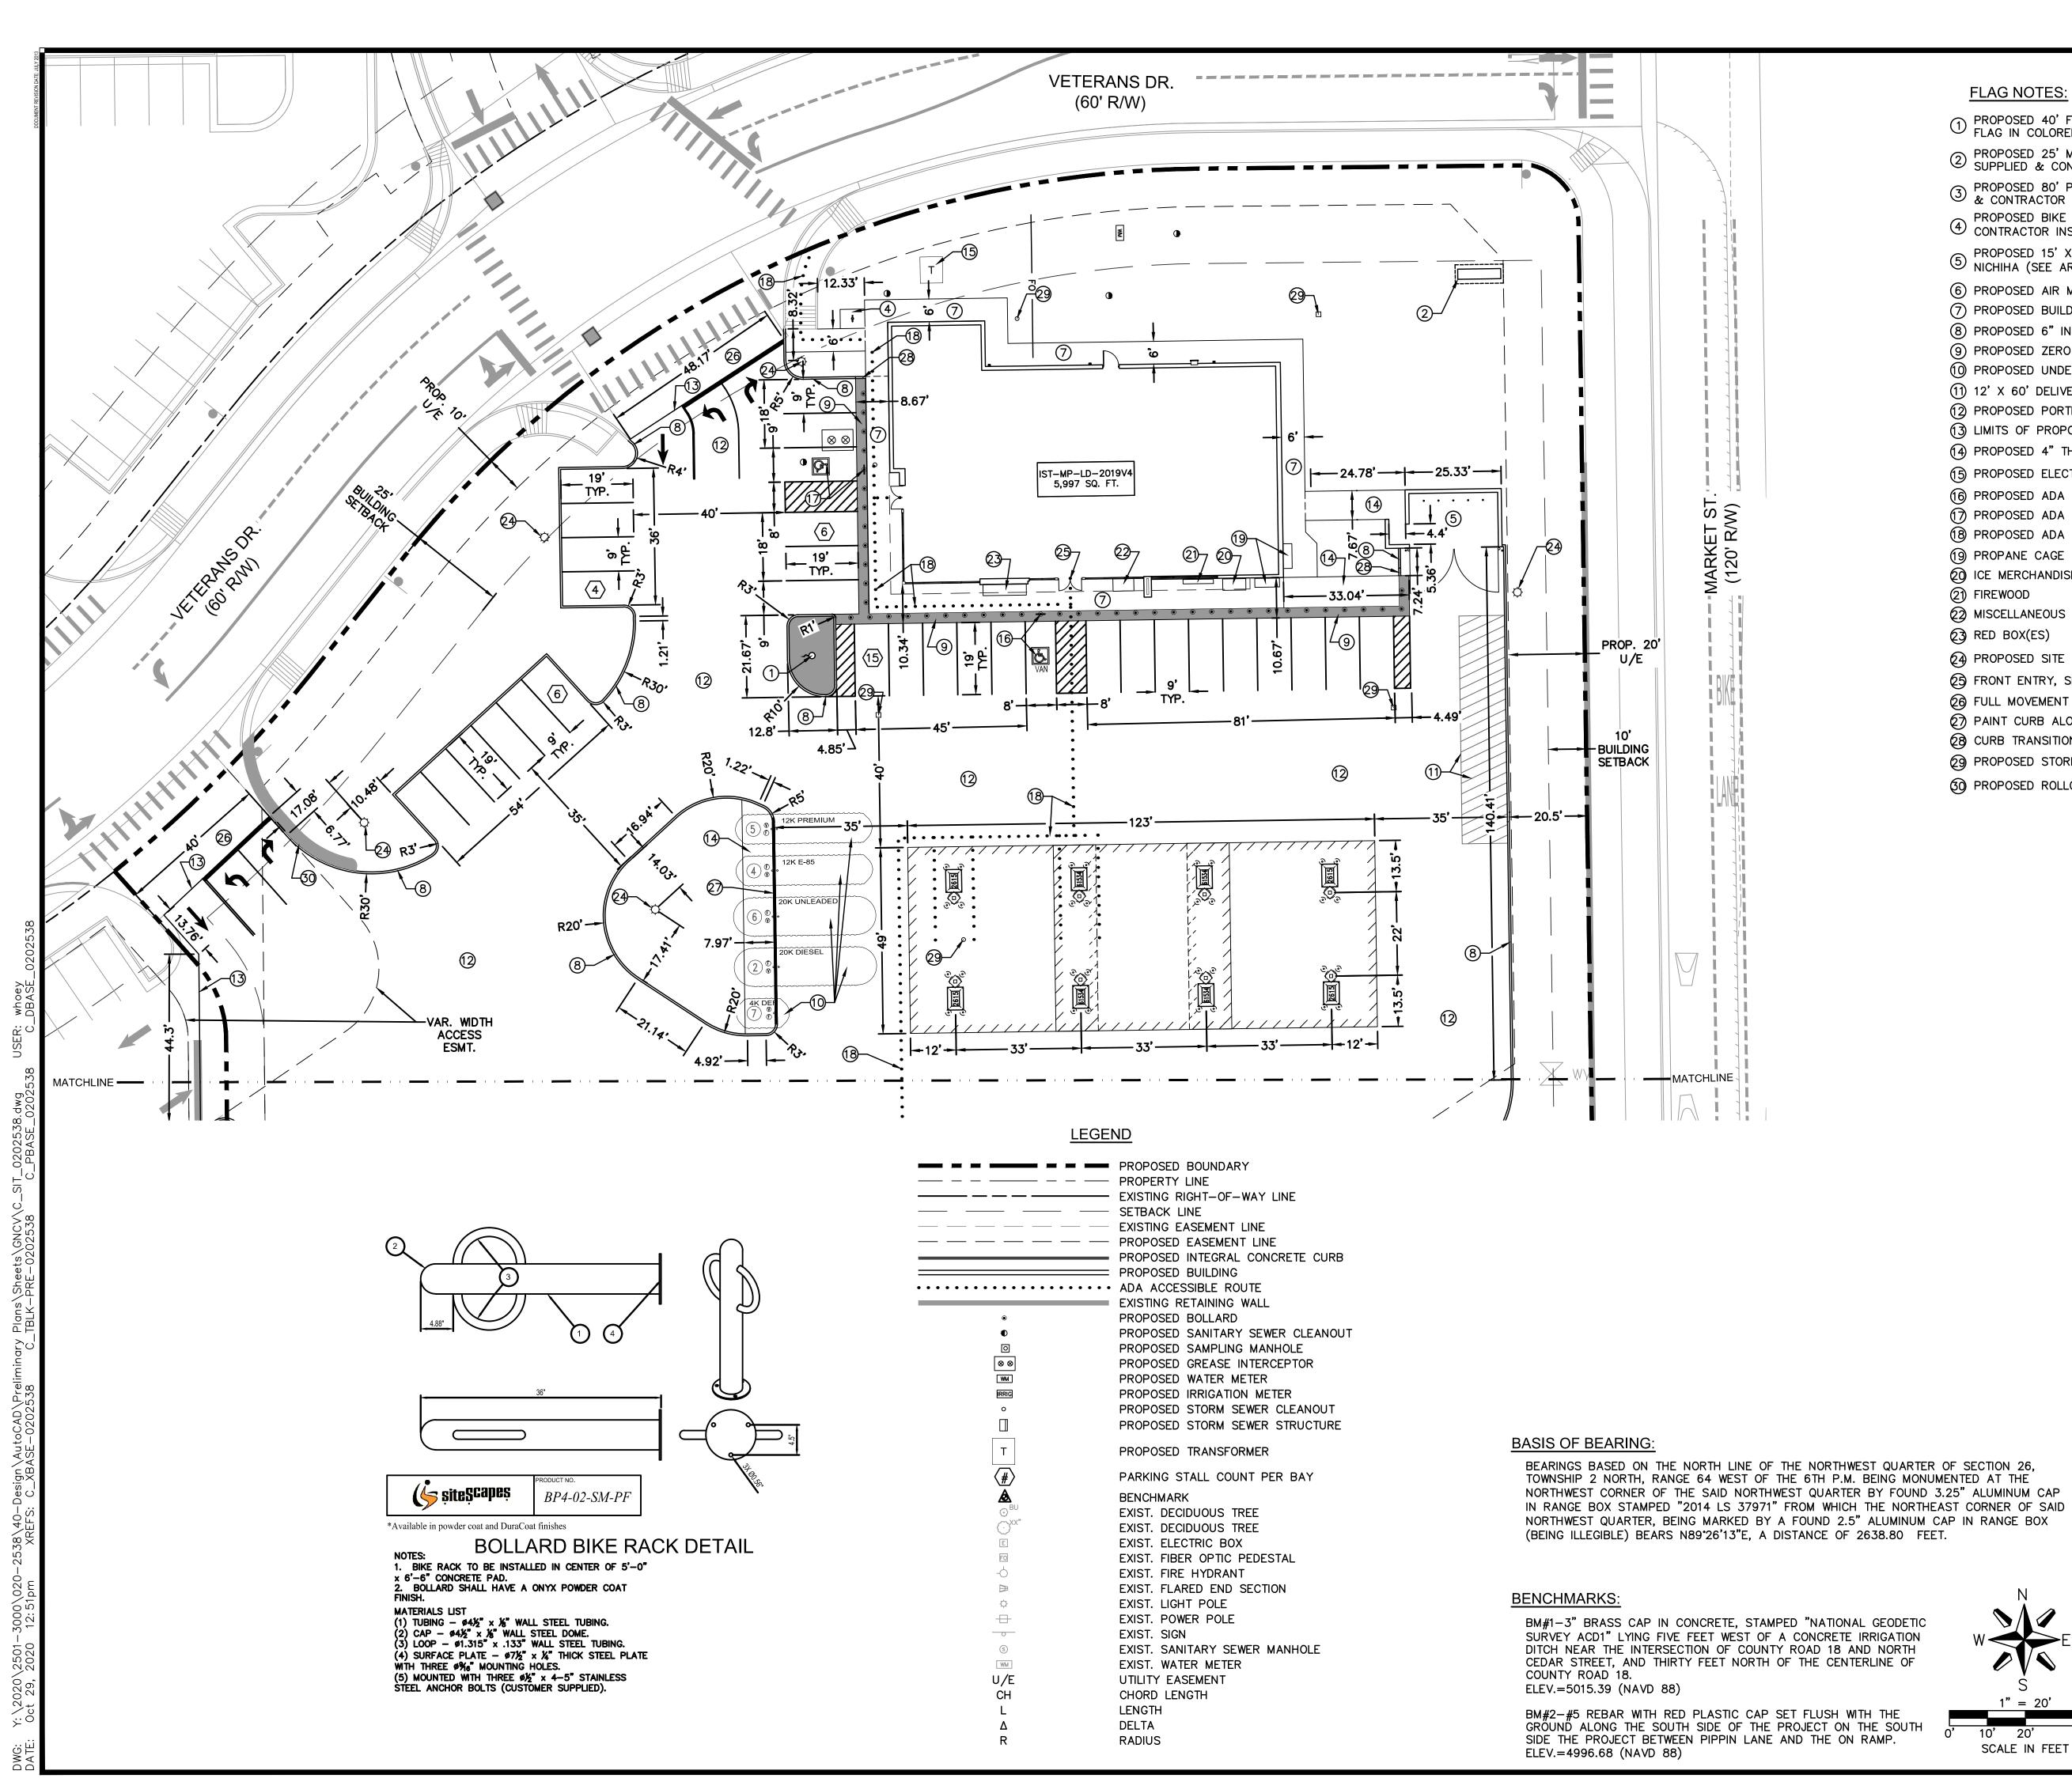


#### FLAG NOTES:

- 1 PROPOSED 40' FLAGPOLE WITH 8'x12' AMERICAN FLAG IN COLORED CONCRETE ISLAND
- 2 PROPOSED 25' MONUMENT SIGN, OWNER SUPPLIED & CONTRACTOR INSTALLED
- 3 PROPOSED 80' POLE SIGN, OWNER SUPPLIED & CONTRACTOR INSTALLED
- PROPOSED BIKE RACK, OWNER SUPPLIED & 4 CONTRACTOR INSTALLED (SEE DETAIL ON THIS SHEET)
- ⑤ PROPOSED 15' X 25' TRASH ENCLOSURE WITH NICHIHA (SEE ARCHITECTURAL PLANS FOR DETAILS)
- (6) PROPOSED AIR MACHINE ON 4' X 4' PAD
- (7) PROPOSED BUILDING SIDEWALK
- (8) PROPOSED 6" INTEGRAL CURB
- (9) PROPOSED ZERO CURB WITH BOLLARDS
- (10) PROPOSED UNDERGROUND STORAGE TANK LOCATIONS
- (11) 12' X 60' DELIVERY VEHICLE LOADING ZONE
- (12) PROPOSED PORTLAND CEMENT CONCRETE PAVEMENT
- (13) LIMITS OF PROPOSED PAVEMENT
- (14) PROPOSED 4" THICK CONCRETE SITE SIDEWALK, WIDTH PER PLAN
- (15) PROPOSED ELECTRIC TRANSFORMER (SEE SHEET C3.1)
- (16) PROPOSED ADA VAN PARKING STALL & BOLLARD MOUNTED SIGN
- (17) PROPOSED ADA PARKING STALL & BOLLARD MOUNTED SIGN
- (18) PROPOSED ADA ACCESSIBLE ROUTE
- (19) PROPANE CAGE
- (20) ICE MERCHANDISE
- (21) FIREWOOD
- 22 MISCELLANEOUS MERCHANDISE
- 23) RED BOX(ES)
- 24) PROPOSED SITE LIGHT POLE (SEE SHEET C3.1)
- (25) FRONT ENTRY, SEE ARCHITECTURAL PLANS
- 26 FULL MOVEMENT ACCESS

SCALE IN FEET

- (27) PAINT CURB ALONG FRONT OF TANKS YELLOW
- (28) CURB TRANSITION TO PAVEMENT
- 29 PROPOSED STORM STRUCTURE (SEE SHEET C2.1)
- (3) PROPOSED ROLLOVER PAVEMENT

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1459 Grand Avenue Des Moines, Iowa 50309 P: 515-226-0128 F: 515-223-9873

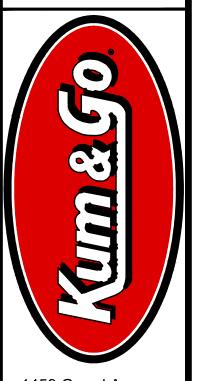SBURG STREET KEENE

SITE **MARKET** ENLARGED 40

KG PROJECT TEAM: RDM: TOM CARRICO SDM: RYAN HALDER CPM: PERRY DEPHILLIPS


2906

TOWN PLANNING APPROVAL

(now what's **below.** Call before you dig. CALL 811 SEVENTY-TWO HOURS PRIOR TO DIGGING, GRADING OR EXCAVATING FOR THE

10/23/2020

SHEET NUMBER: 3 OF 15

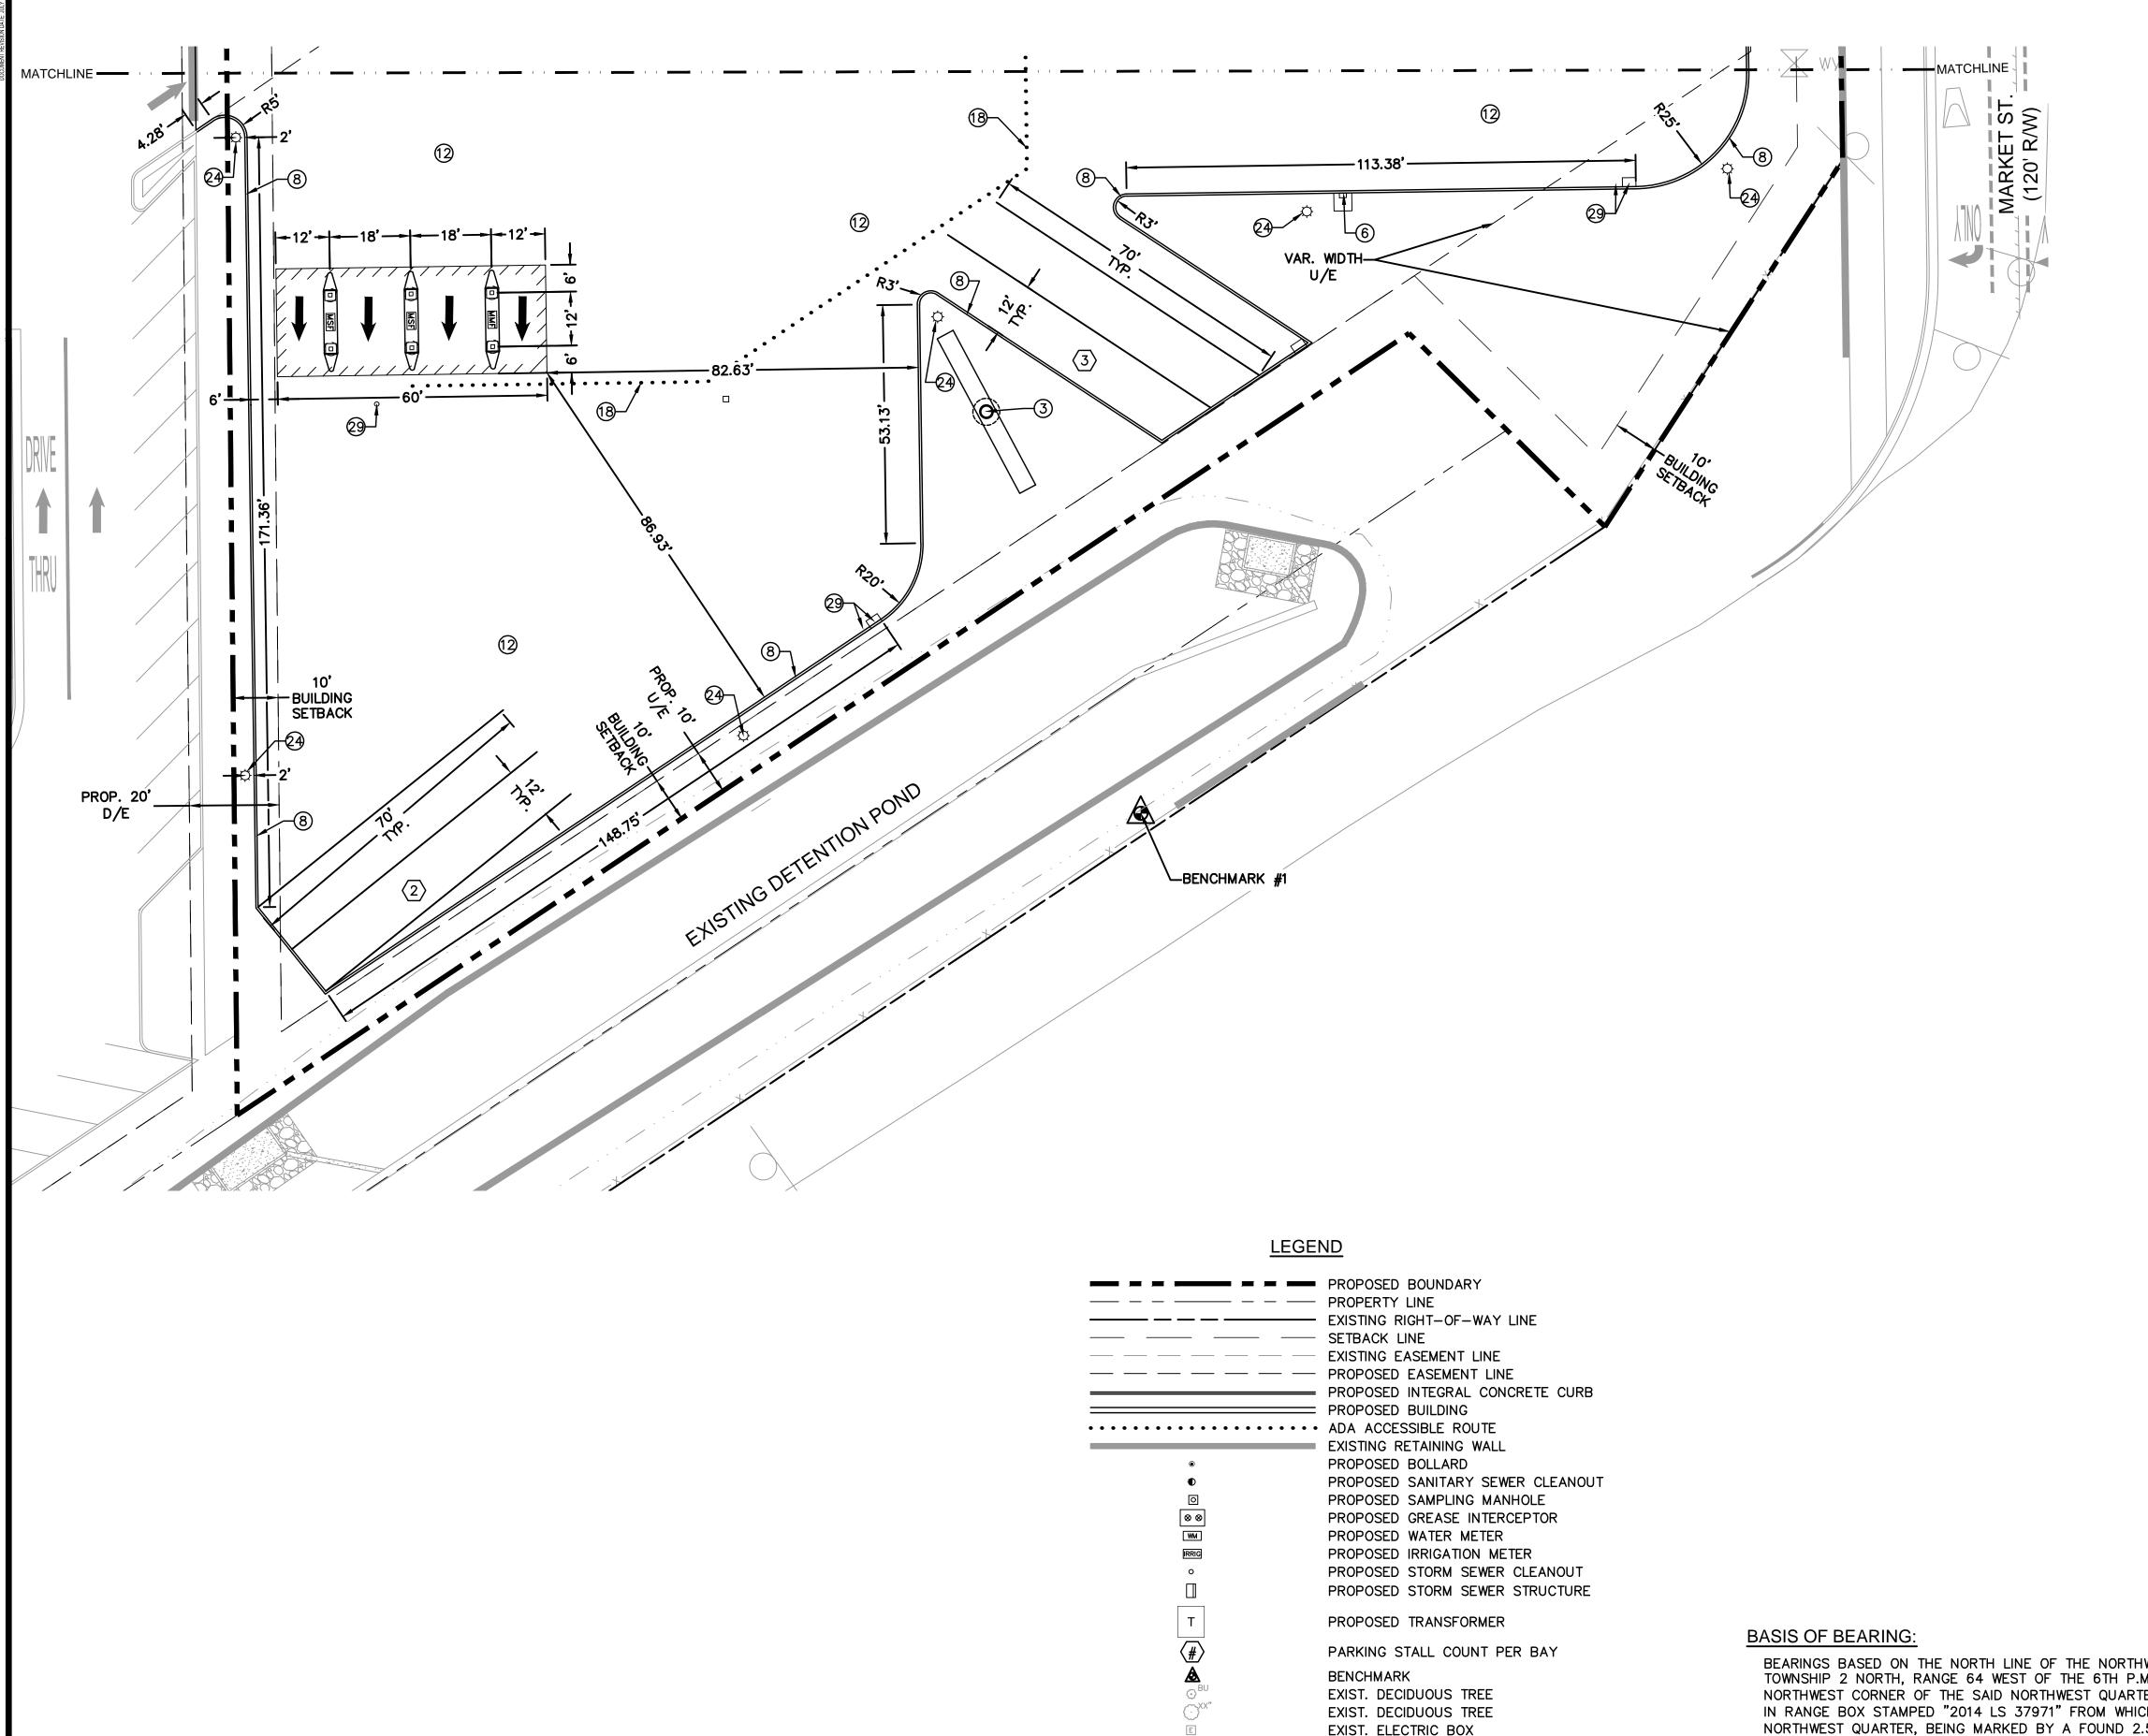

### **FLAG NOTES:**

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- 2 PROPOSED 25' MONUMENT SIGN, OWNER SUPPLIED & CONTRACTOR INSTALLED
- 3 PROPOSED 80' POLE SIGN, OWNER SUPPLIED & CONTRACTOR INSTALLED
- PROPOSED BIKE RACK, OWNER SUPPLIED & CONTRACTOR INSTALLED (SEE DETAIL ON THIS SHEET)
- 5 PROPOSED 15' X 25' TRASH ENCLOSURE WITH NICHIHA (SEE ARCHITECTURAL PLANS FOR DETAILS)
- (6) PROPOSED AIR MACHINE ON 4' X 4' PAD
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## **BENCHMARKS**:

EXIST. FIBER OPTIC PEDESTAL

EXIST. FLARED END SECTION

EXIST. SANITARY SEWER MANHOLE

EXIST. FIRE HYDRANT

EXIST. LIGHT POLE

EXIST. POWER POLE

EXIST. WATER METER

UTILITY EASEMENT

CHORD LENGTH

LENGTH

DELTA


RADIUS

EXIST. SIGN

U/E

BM#1-3" BRASS CAP IN CONCRETE, STAMPED "NATIONAL GEODETIC SURVEY ACD1" LYING FIVE FEET WEST OF A CONCRETE IRRIGATION DITCH NEAR THE INTERSECTION OF COUNTY ROAD 18 AND NORTH CEDAR STREET, AND THIRTY FEET NORTH OF THE CENTERLINE OF COUNTY ROAD 18. ELEV.=5015.39 (NAVD 88)

BM#2-#5 REBAR WITH RED PLASTIC CAP SET FLUSH WITH THE GRÖUND ALONG THE SOUTH SIDE OF THE PROJECT ON THE SOUTH SIDE THE PROJECT BETWEEN PIPPIN LANE AND THE ON RAMP. ELEV.=4996.68 (NAVD 88)

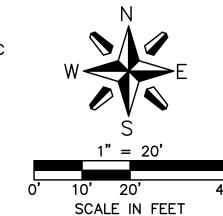



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Des Moines, Iowa

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8

SBURG,

KEENE

#2906

KG PROJECT TEAM:

RDM: TOM CARRICO

SDM: RYAN HALDER

CPM: PERRY DEPHILLIPS

STREET

MARKET

40

SITE

ENLARGED

BY REGULATORY

IS SUBJECT TO CHANGE. THIS

BE USED FOR CONSTRUCTION.

SHEET NUMBER: 4 OF 15

FLOOD ZONE:

DENOTED ON FIRM MAP):

ACCORDING TO F.E.M.A. FLOOD INSURANCE RATE MAP NUMBER: 08123C2157E, EFFECTIVE DATE: JANUARY 20,

- OTHER AREA - ZÓNE X: AREAS DETERMINED TO BE OUTSIDE THE 0.2% ANNUAL CHANCE FLOODPLAIN.

2016, THIS PROPERTY LIES IN ONE OF THE FOLLOWING FLOOD ZONES (AMBIGUITY DUE TO ZONES NOT

- OTHER AREA - ZONE D: AREAS IN WHICH FLOOD HAZARDS ARE UNDETERMINED, BUT POSSIBLE.

## FLAG NOTES:

- ① ADA ACCESSIBLE STALL AND AISLE, NOT TO EXCEED 2.00% GRADE IN ANY DIRECTION
- (2) MATCH EXISTING GRADE, CONTRACTOR SHALL FIELD VERIFY
- 3 ALL LIDS FOR UNDERGROUND TANKS TO BE 1" ABOVE FINISHED GRADE
- (4) PROPOSED CONCRETE INTEGRAL CURB
- (5) PROPOSED CONCRETE PAVEMENT
- (6) CONSTRUCT TRANSITION CURB/SIDEWALK PAVEMENT, LENGTH PER PLAN
- (7) CONSTRUCT 2'-0" TRANSITION OF CURB TO PAVEMENT
- (8) PROPOSED STORM SEWER STRUCTURE, SEE SHEET C2.1
- TYPICAL UNDERGROUND STORAGE TANK OVERDIG LIMITS
- 10 PROPOSED ADA ACCESSIBLE ROUTE

#### LEGEND

LEGE	<u>ND</u>
— LOD — — — — — 5000 — — 5000 — — — — — — — —	PROPOSED BOUNDARY EXISTING RIGHT-OF-WAY LINE PROPOSED INTEGRAL CONCRETE CURB PROPOSED BUILDING LIMITS OF DISTURBANCE PROPOSED DEVELOPMENT MASS GRADING CONTOUR PROPOSED CONTOUR BREAK IN GRADE PROPOSED BOLLARD PROPOSED SANITARY SEWER CLEANOUT PROPOSED SAMPLING MANHOLE PROPOSED GREASE INTERCEPTOR PROPOSED WATER METER PROPOSED IRRIGATION METER PROPOSED STORM SEWER CLEANOUT PROPOSED STORM SEWER STRUCTURE  PROPOSED TRANSFORMER
BU OXXX"  E FO	BENCHMARK EXIST. DECIDUOUS TREE EXIST. DECIDUOUS TREE EXIST. ELECTRIC BOX EXIST. FIBER OPTIC PEDESTAL EXIST. FIRE HYDRANT EXIST. FLARED END SECTION EXIST. LIGHT POLE EXIST. POWER POLE EXIST. SIGN EXIST. SANITARY SEWER MANHOLE EXIST. WOOD POST EXIST. WOOD POST


## NOTE:

THE UNDERGROUND UTILITIES SHOWN HAVE BEEN LOCATED FROM FIELD SURVEY INFORMATION AND EXISTING DRAWINGS. THE ENGINEER/SURVEYOR MAKES NO GUARANTEES THAT THE UTILITIES SHOWN COMPRISE ALL SUCH UTILITIES IN THE AREA, EITHER IN-SERVICE OR ABANDONED. THE ENGINEER/SURVEYOR FURTHER DOES NOT WARRANT THAT THE UTILITIES SHOWN ARE IN THE EXACT LOCATION INDICATED, THE ENGINEER/SURVEYOR HAS NOT PHYSICALLY LOCATED THE UNDERGROUND UTILITIES. THIS INCLUDES PRIVATE AND PUBLIC UTILITIES.

## **BENCHMARKS**:

BM#1-3" BRASS CAP IN CONCRETE, STAMPED "NATIONAL GEODETIC SURVEY ACD1" LYING FIVE FEET WEST OF A CONCRETE IRRIGATION DITCH NEAR THE INTERSECTION OF COUNTY ROAD 18 AND NORTH CEDAR STREET, AND THIRTY FEET NORTH OF THE CENTERLINE OF COUNTY ROAD 18. ELEV.=5015.39 (NAVD 88)

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8 KEENESBURG STREET PLAN

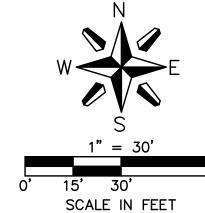
GRADING 240 MARKET

KG PROJECT TEAM: RDM: TOM CARRICO SDM: RYAN HALDER CPM: PERRY DEPHILLIPS

#2906

10/23/2020


SHEET NUMBER: 5 OF 15

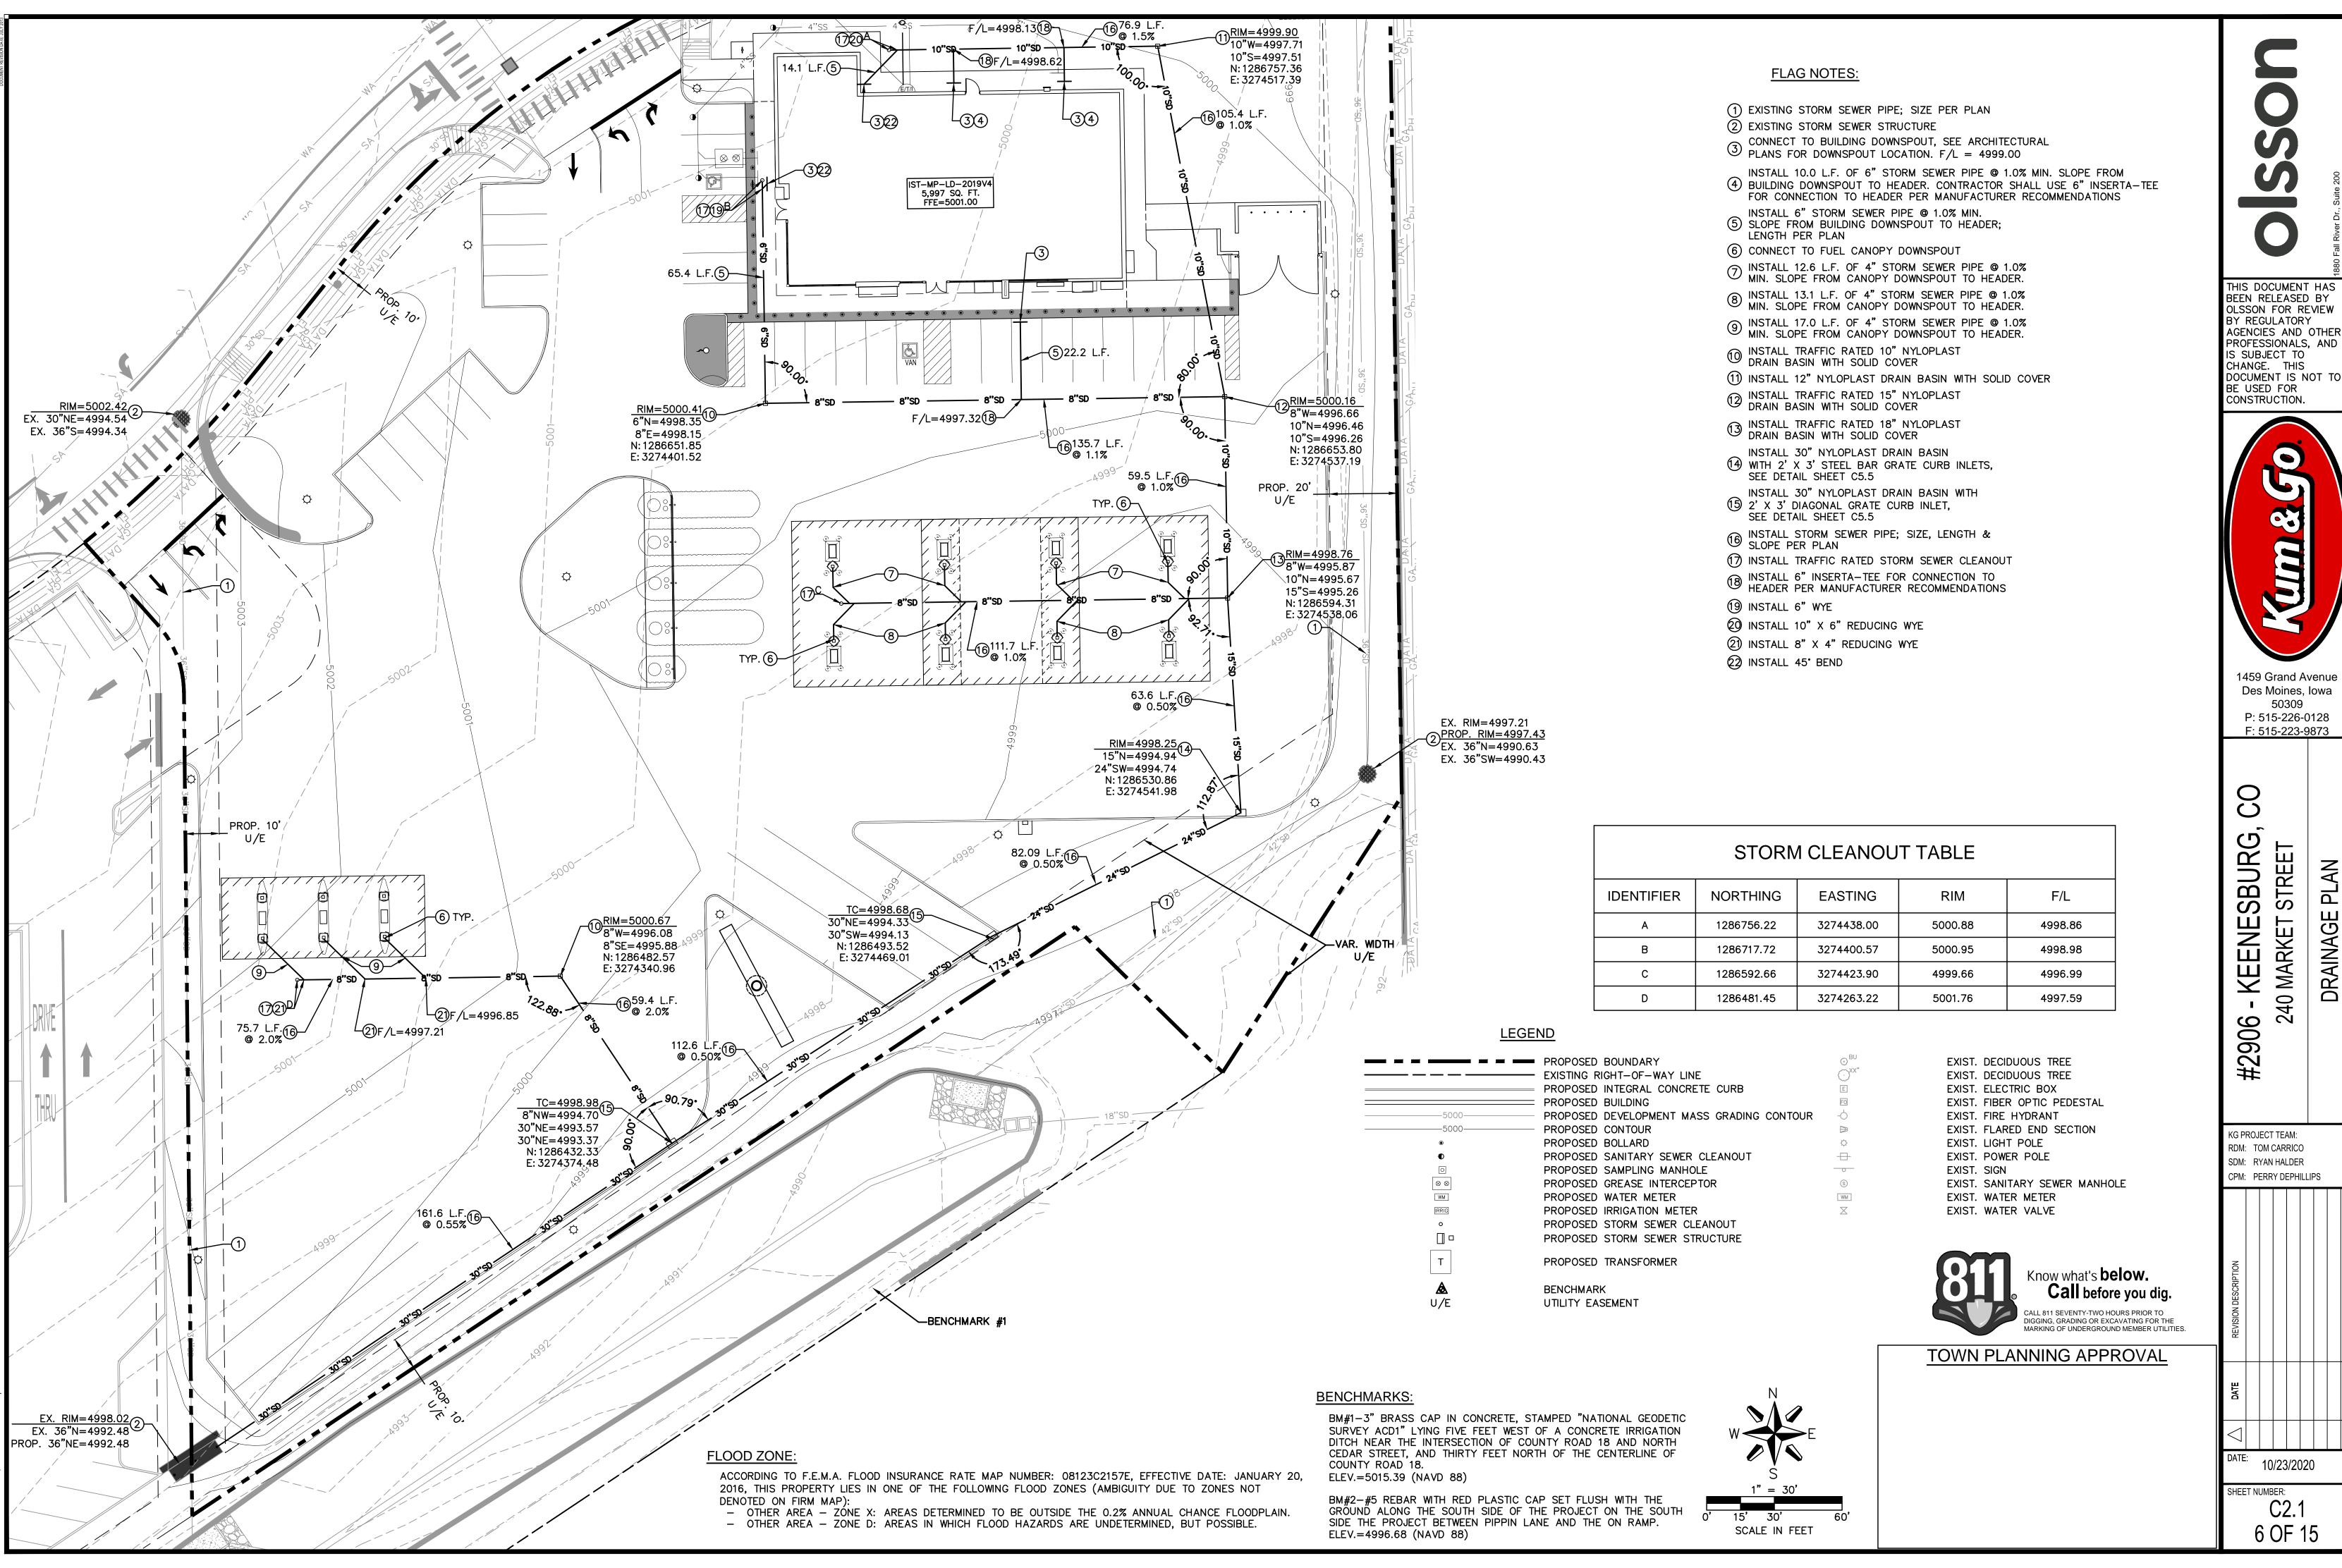


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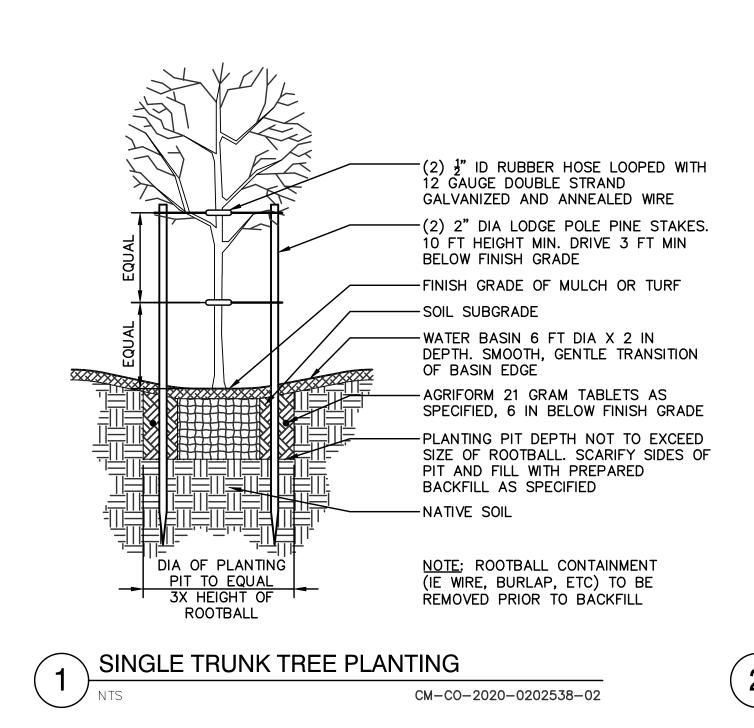
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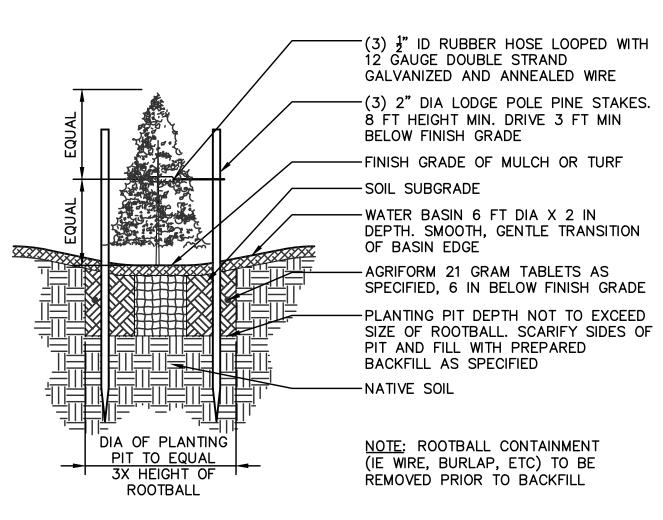
DRAINAGE






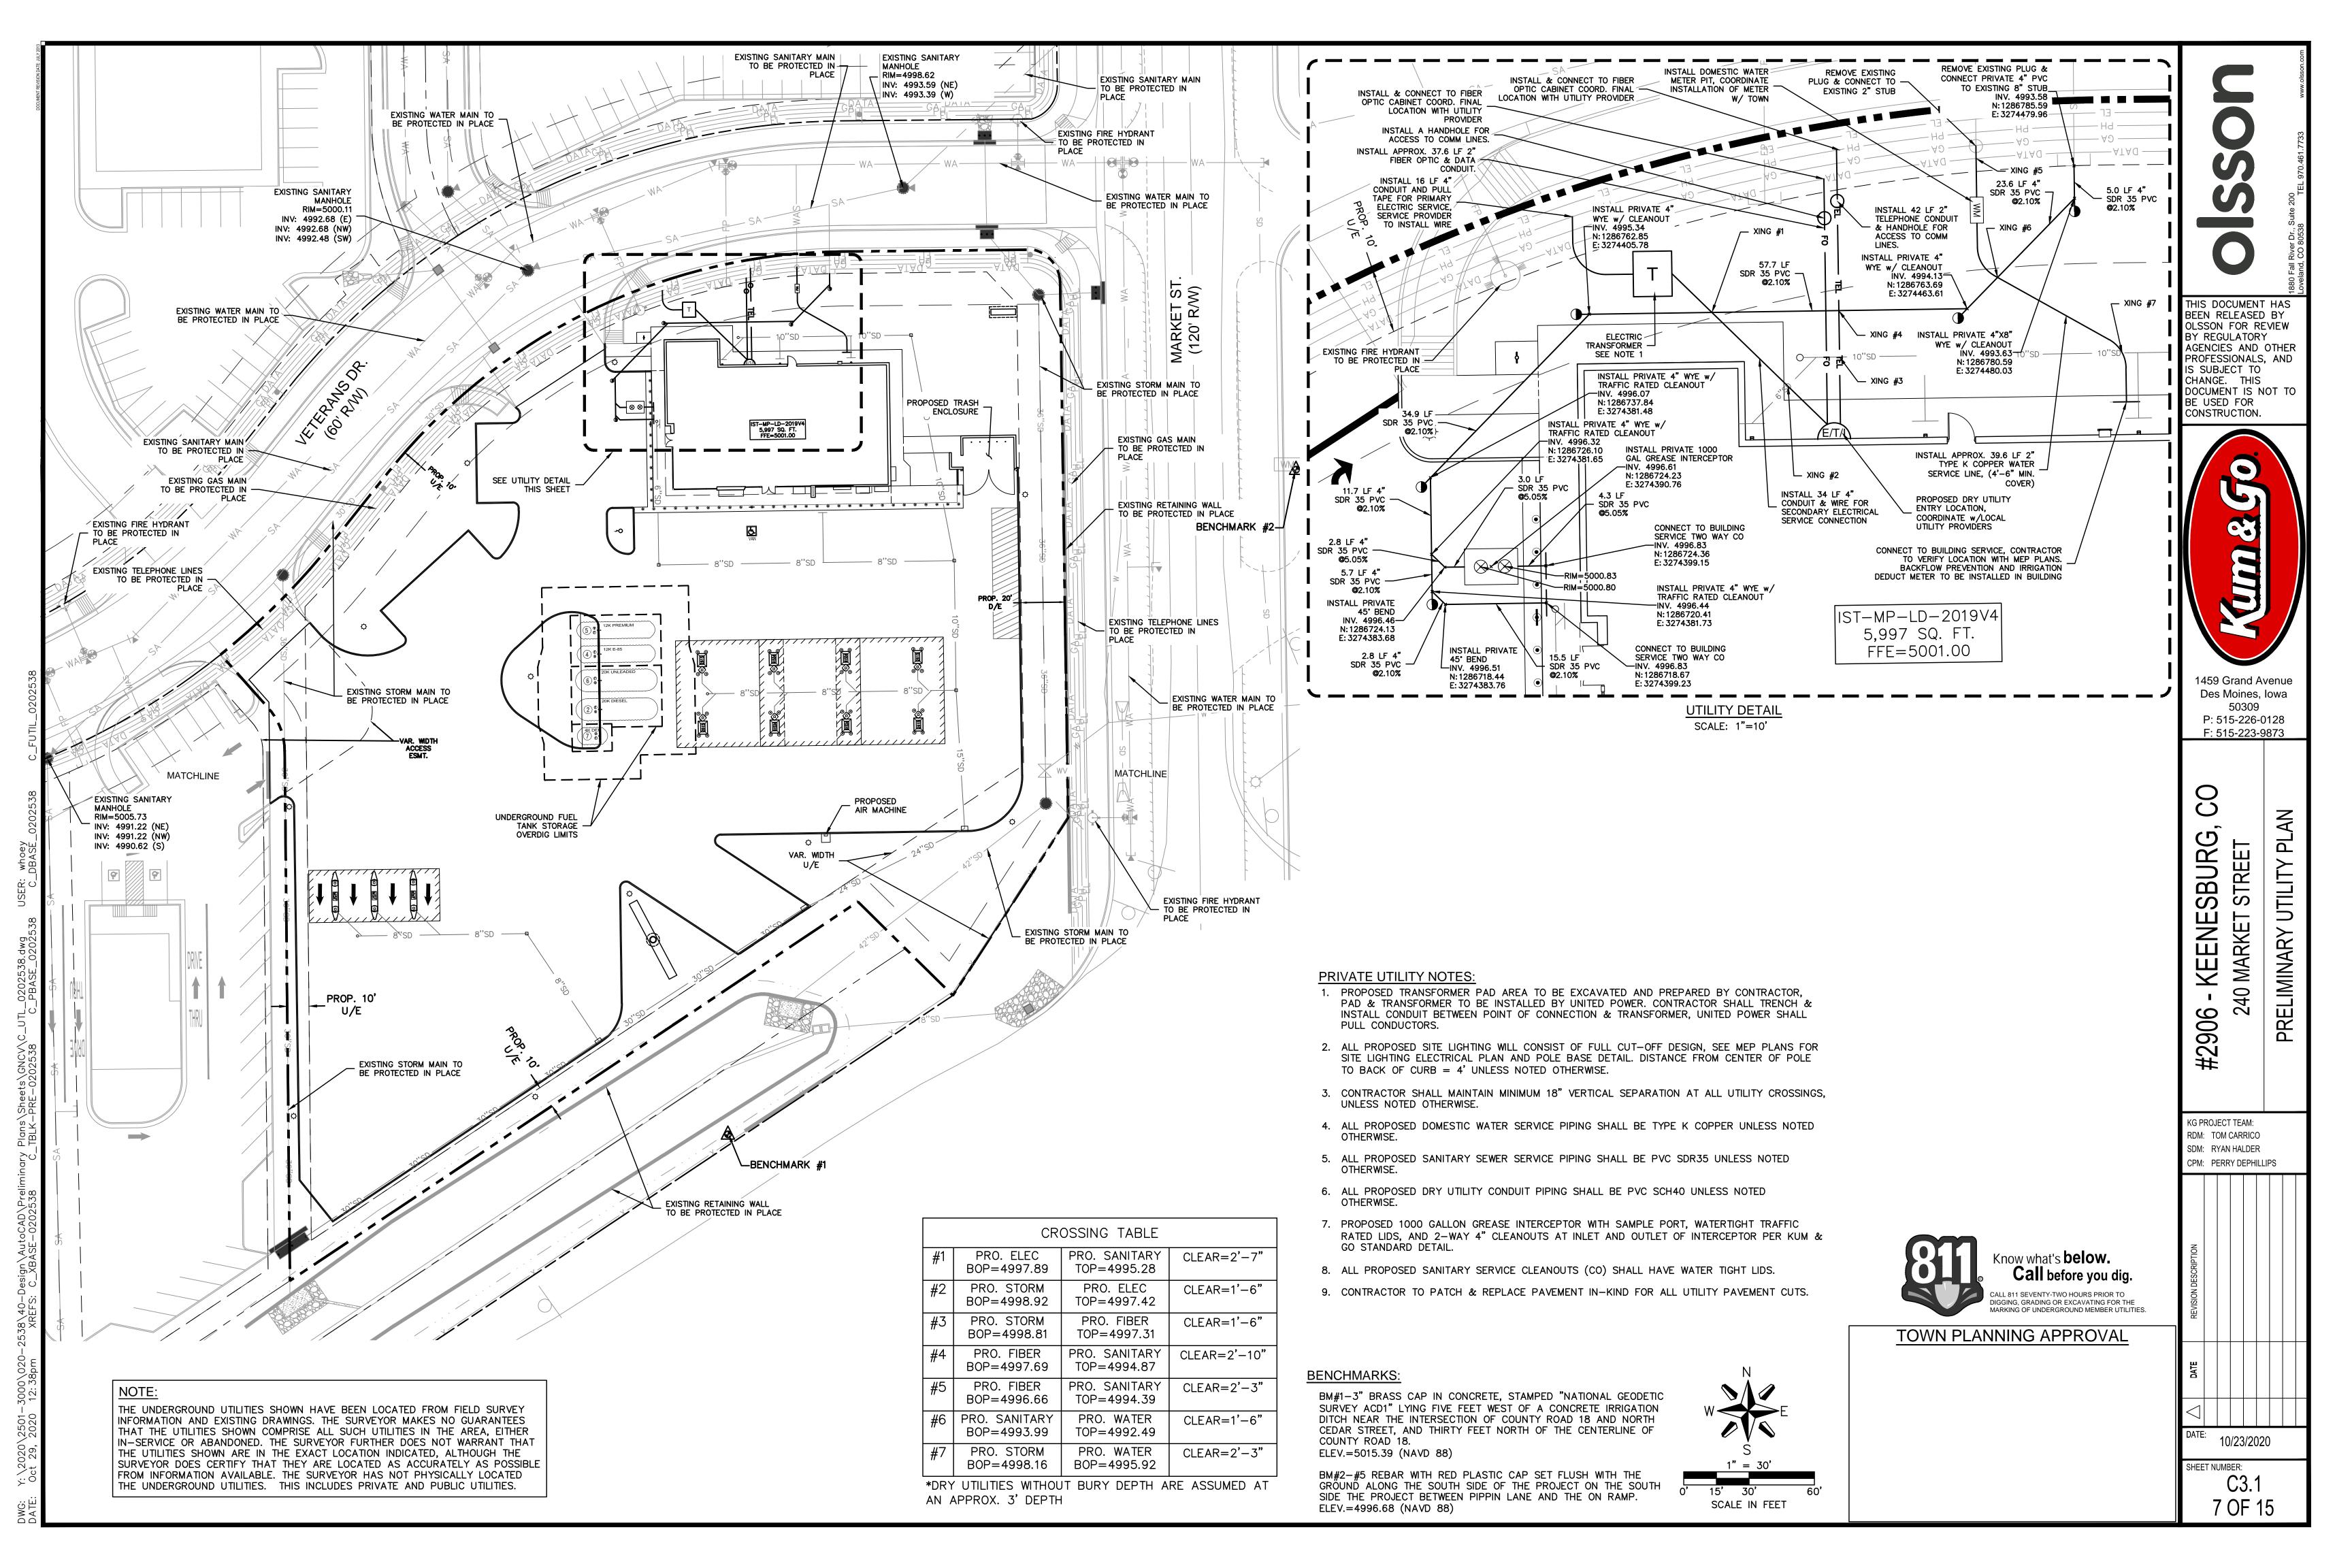


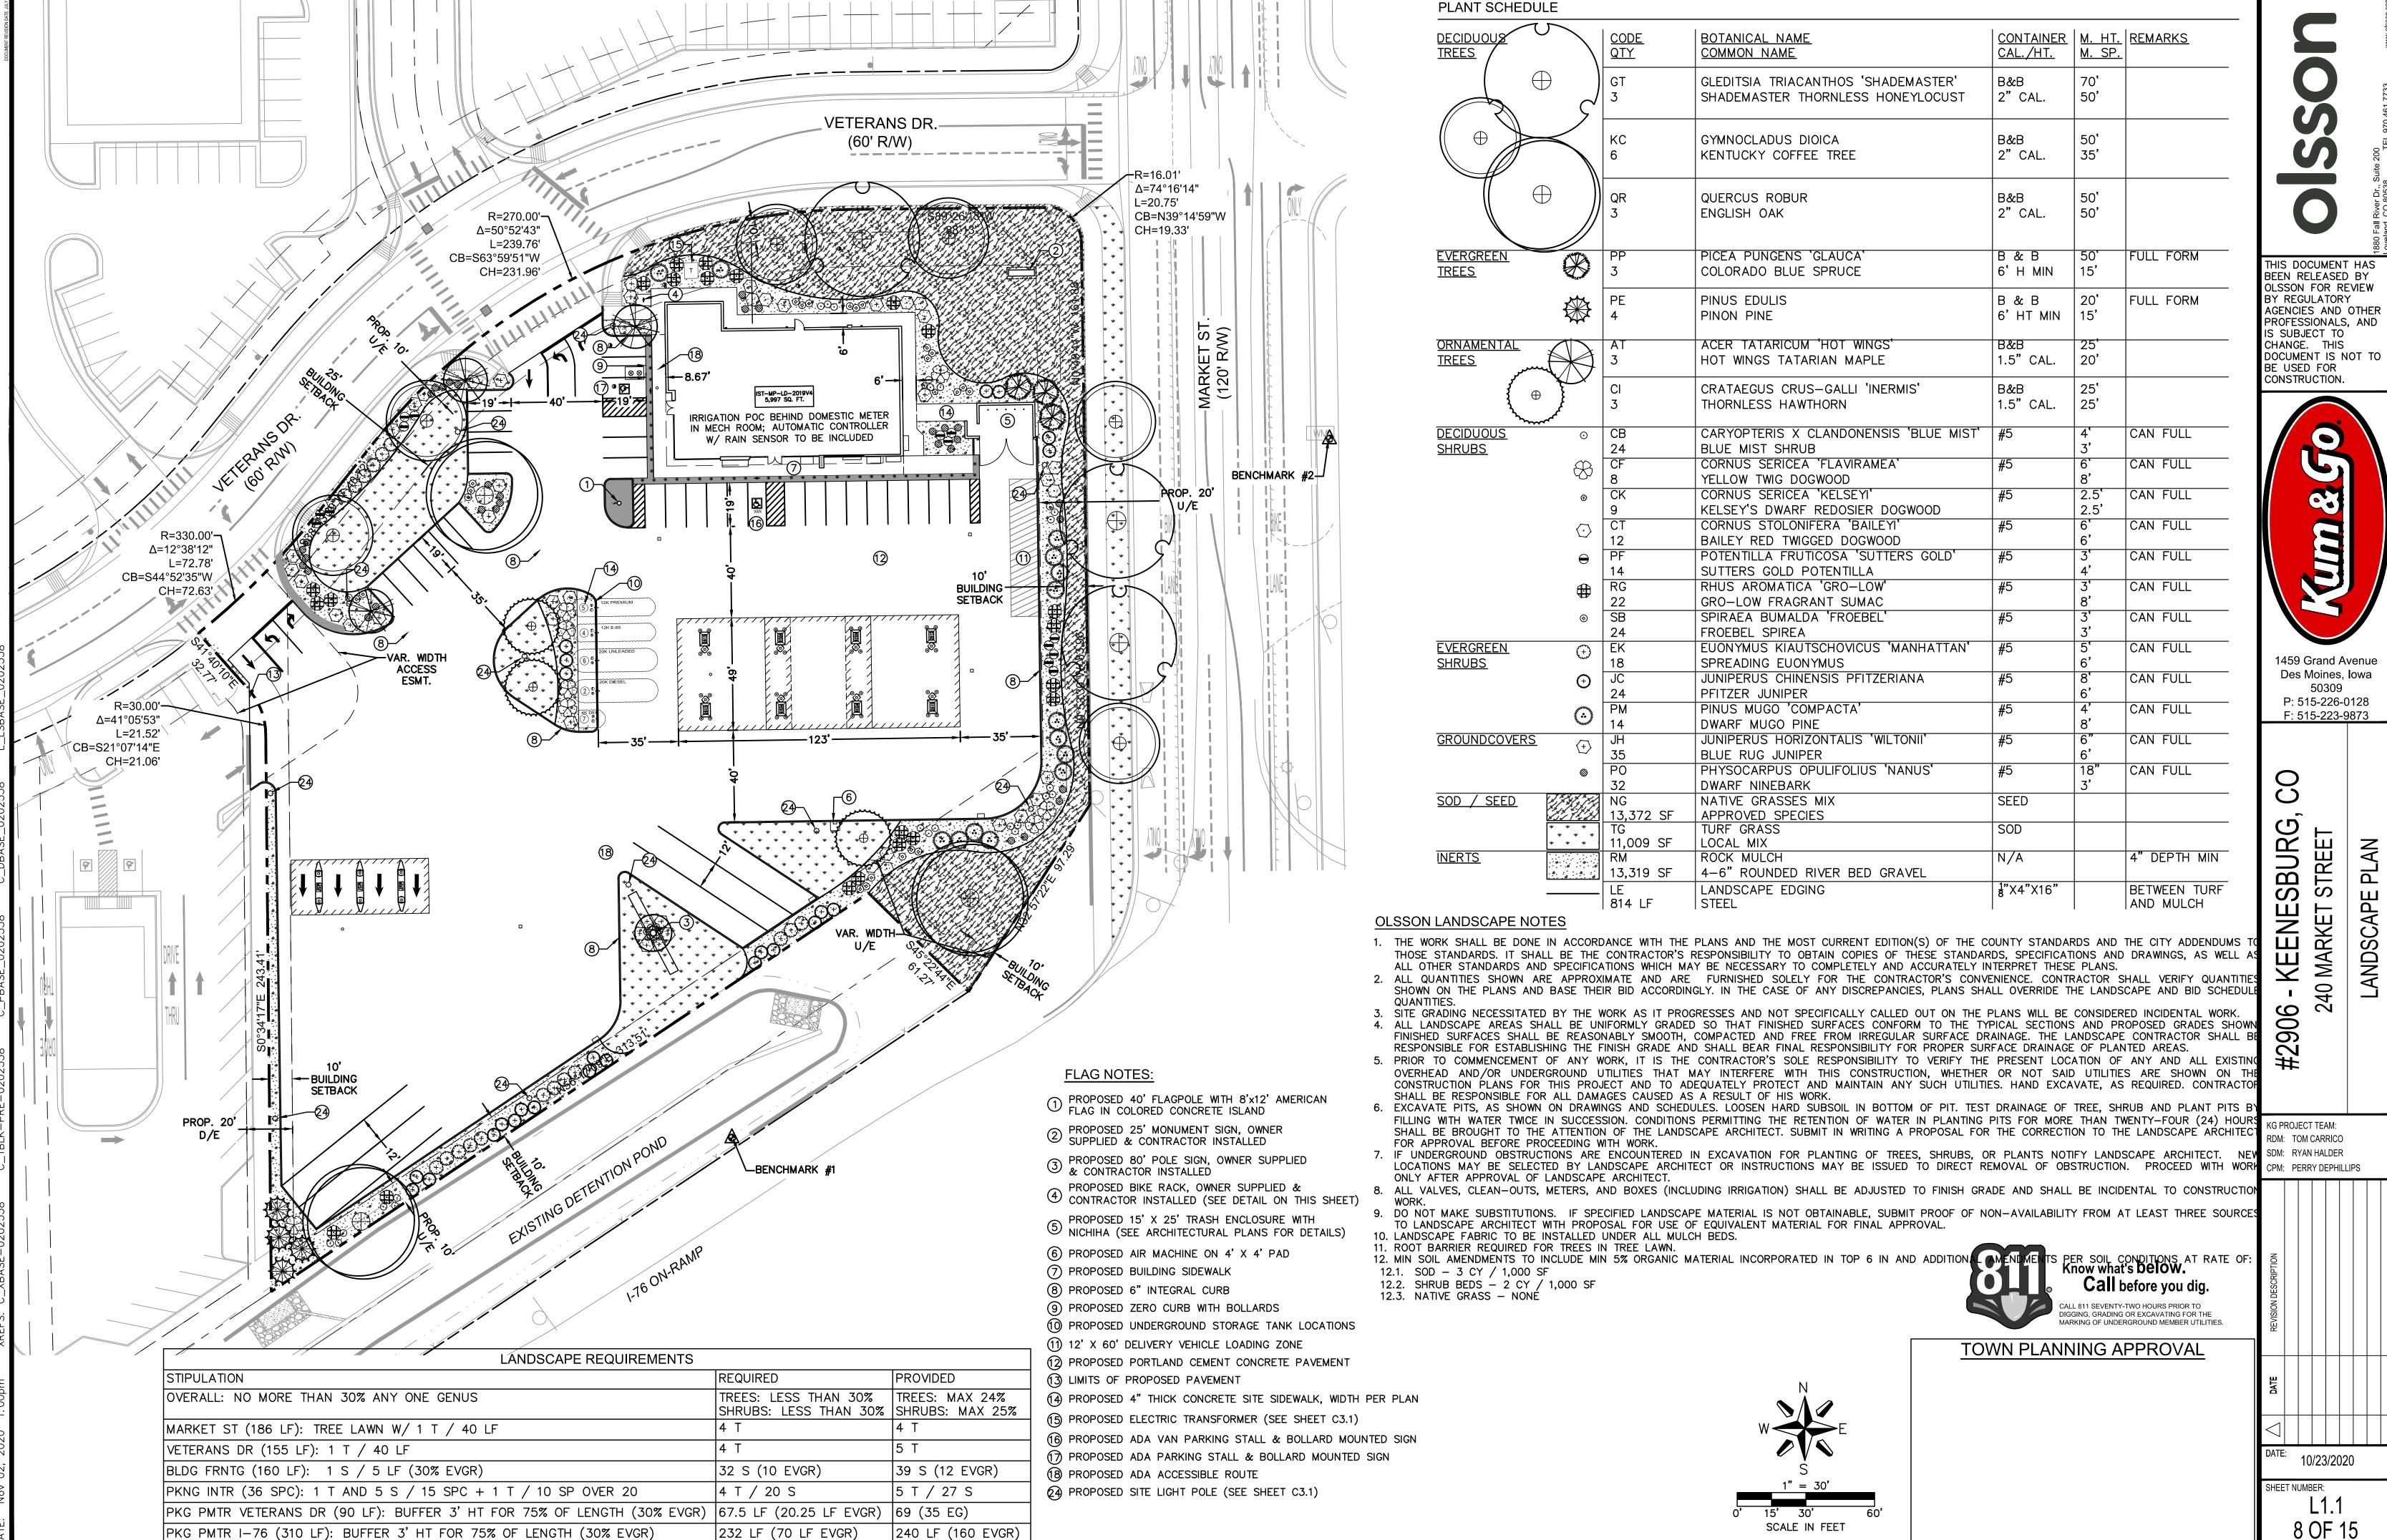



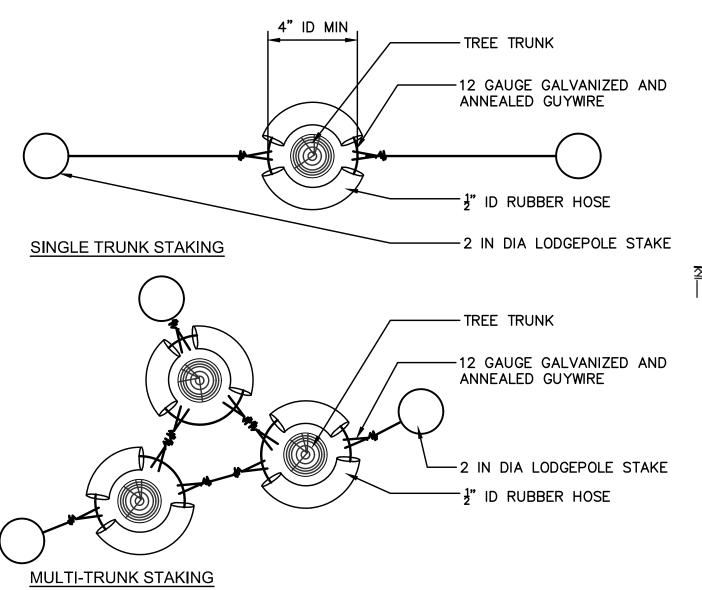

CM-CO-2020-0202538-04

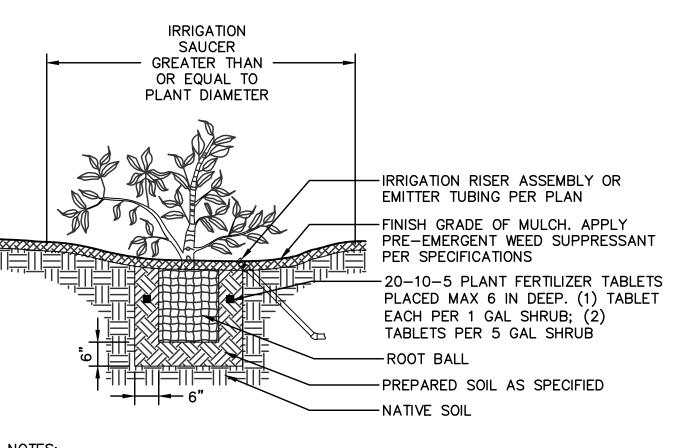


NOTES:

1. SCARIFY PERIMETER OF PLANT PITS PRIOR TO BACKFILL 2. TEST PLANT PITS FOR DRAINAGE: CONSTRUCT AN EXAMPLE IRRIGATION SAUCER FOR ENGINEER'S APPROVAL PRIOR TO PLACING MULCH

CM-CO-2020-0202538-05

SHRUB PLANTING

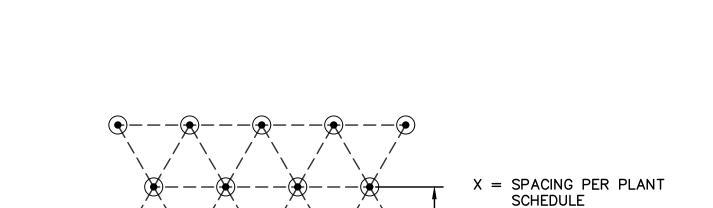


Y = 0.86X

NOTES:

1. PLANT ALL GROUNDCOVERS ON CENTER AND IN A TRIANGLE PATTERN


2. SIZE OF PLANT MATERIAL SHALL BE AS NOTED ON PLANT SCHEDULE



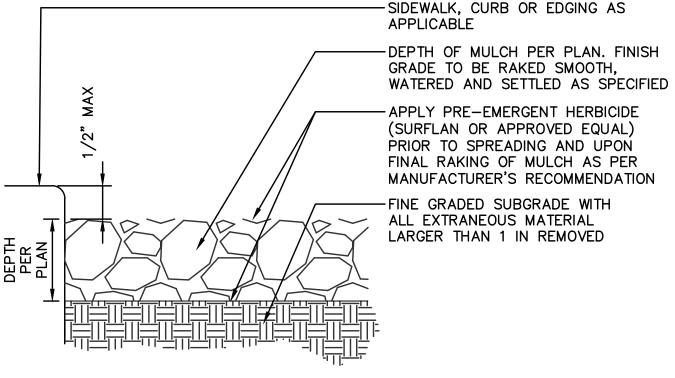


CM-CO-2020-0202538-25

NOTES:
1. MULCH TYPE, SIZE AND COLOR AS NOTED IN LANDSCAPE SCHEDULE 2. CONTRACTOR TO SUBMIT MULCH SAMPLE FOR APPROVAL PRIOR TO CONSTRUCTION 3. LANDSCAPE FABRIC TO BE INSTALLED UNDER ALL MULCH BEDS
4. ROOT BARRIER TO BE INSTALLED AT ALL PAVEMENT TO PLANTING BED CONNECTIONS

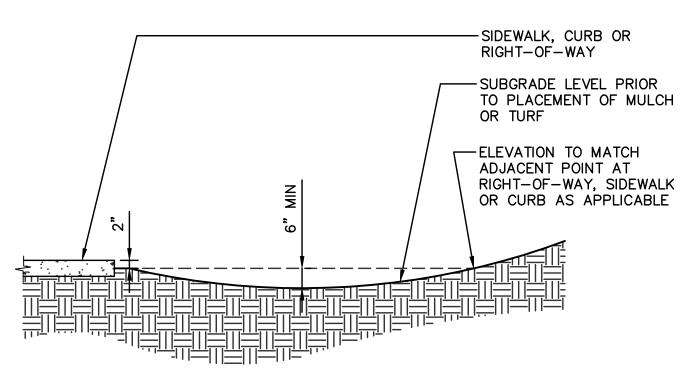

TREE STAKING - PLAN VIEW

NOTE: IRRIGATION SWALE TO BE APPROVED PRIOR TO PLACEMENT OF PLANTS, TURF OR MULCH

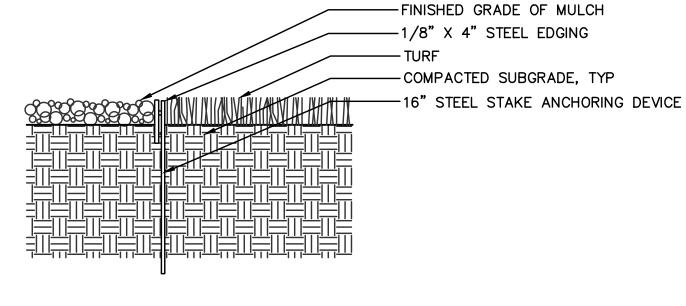

NOTES:

1. EDGING SHALL BE FLUSH WITH FINISHED GRADE OF MULCH

2. LANDSCAPE ARCHITECT SHALL APPROVE STEEL EDGING TYPE AND ANCHOR PRIOR TO INSTALLATION

7	IRRIGATION SWALE	
' )	NTS	CM-CO-2020-0202538-08

STEEL EDGING CM-CO-2020-0202538-24

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STREET

240 MARKET

S

LANDSCAPE DETAILS

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KEENESBURG,

#2906

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BE USED FOR

CONSTRUCTION.


10/23/2020

SHEET NUMBER: 9 OF 15

TOWN PLANNING APPROVAL

EVERGREEN TREE PLANTING

**MULCH APPLICATION** CM-CO-2020-0202538-09

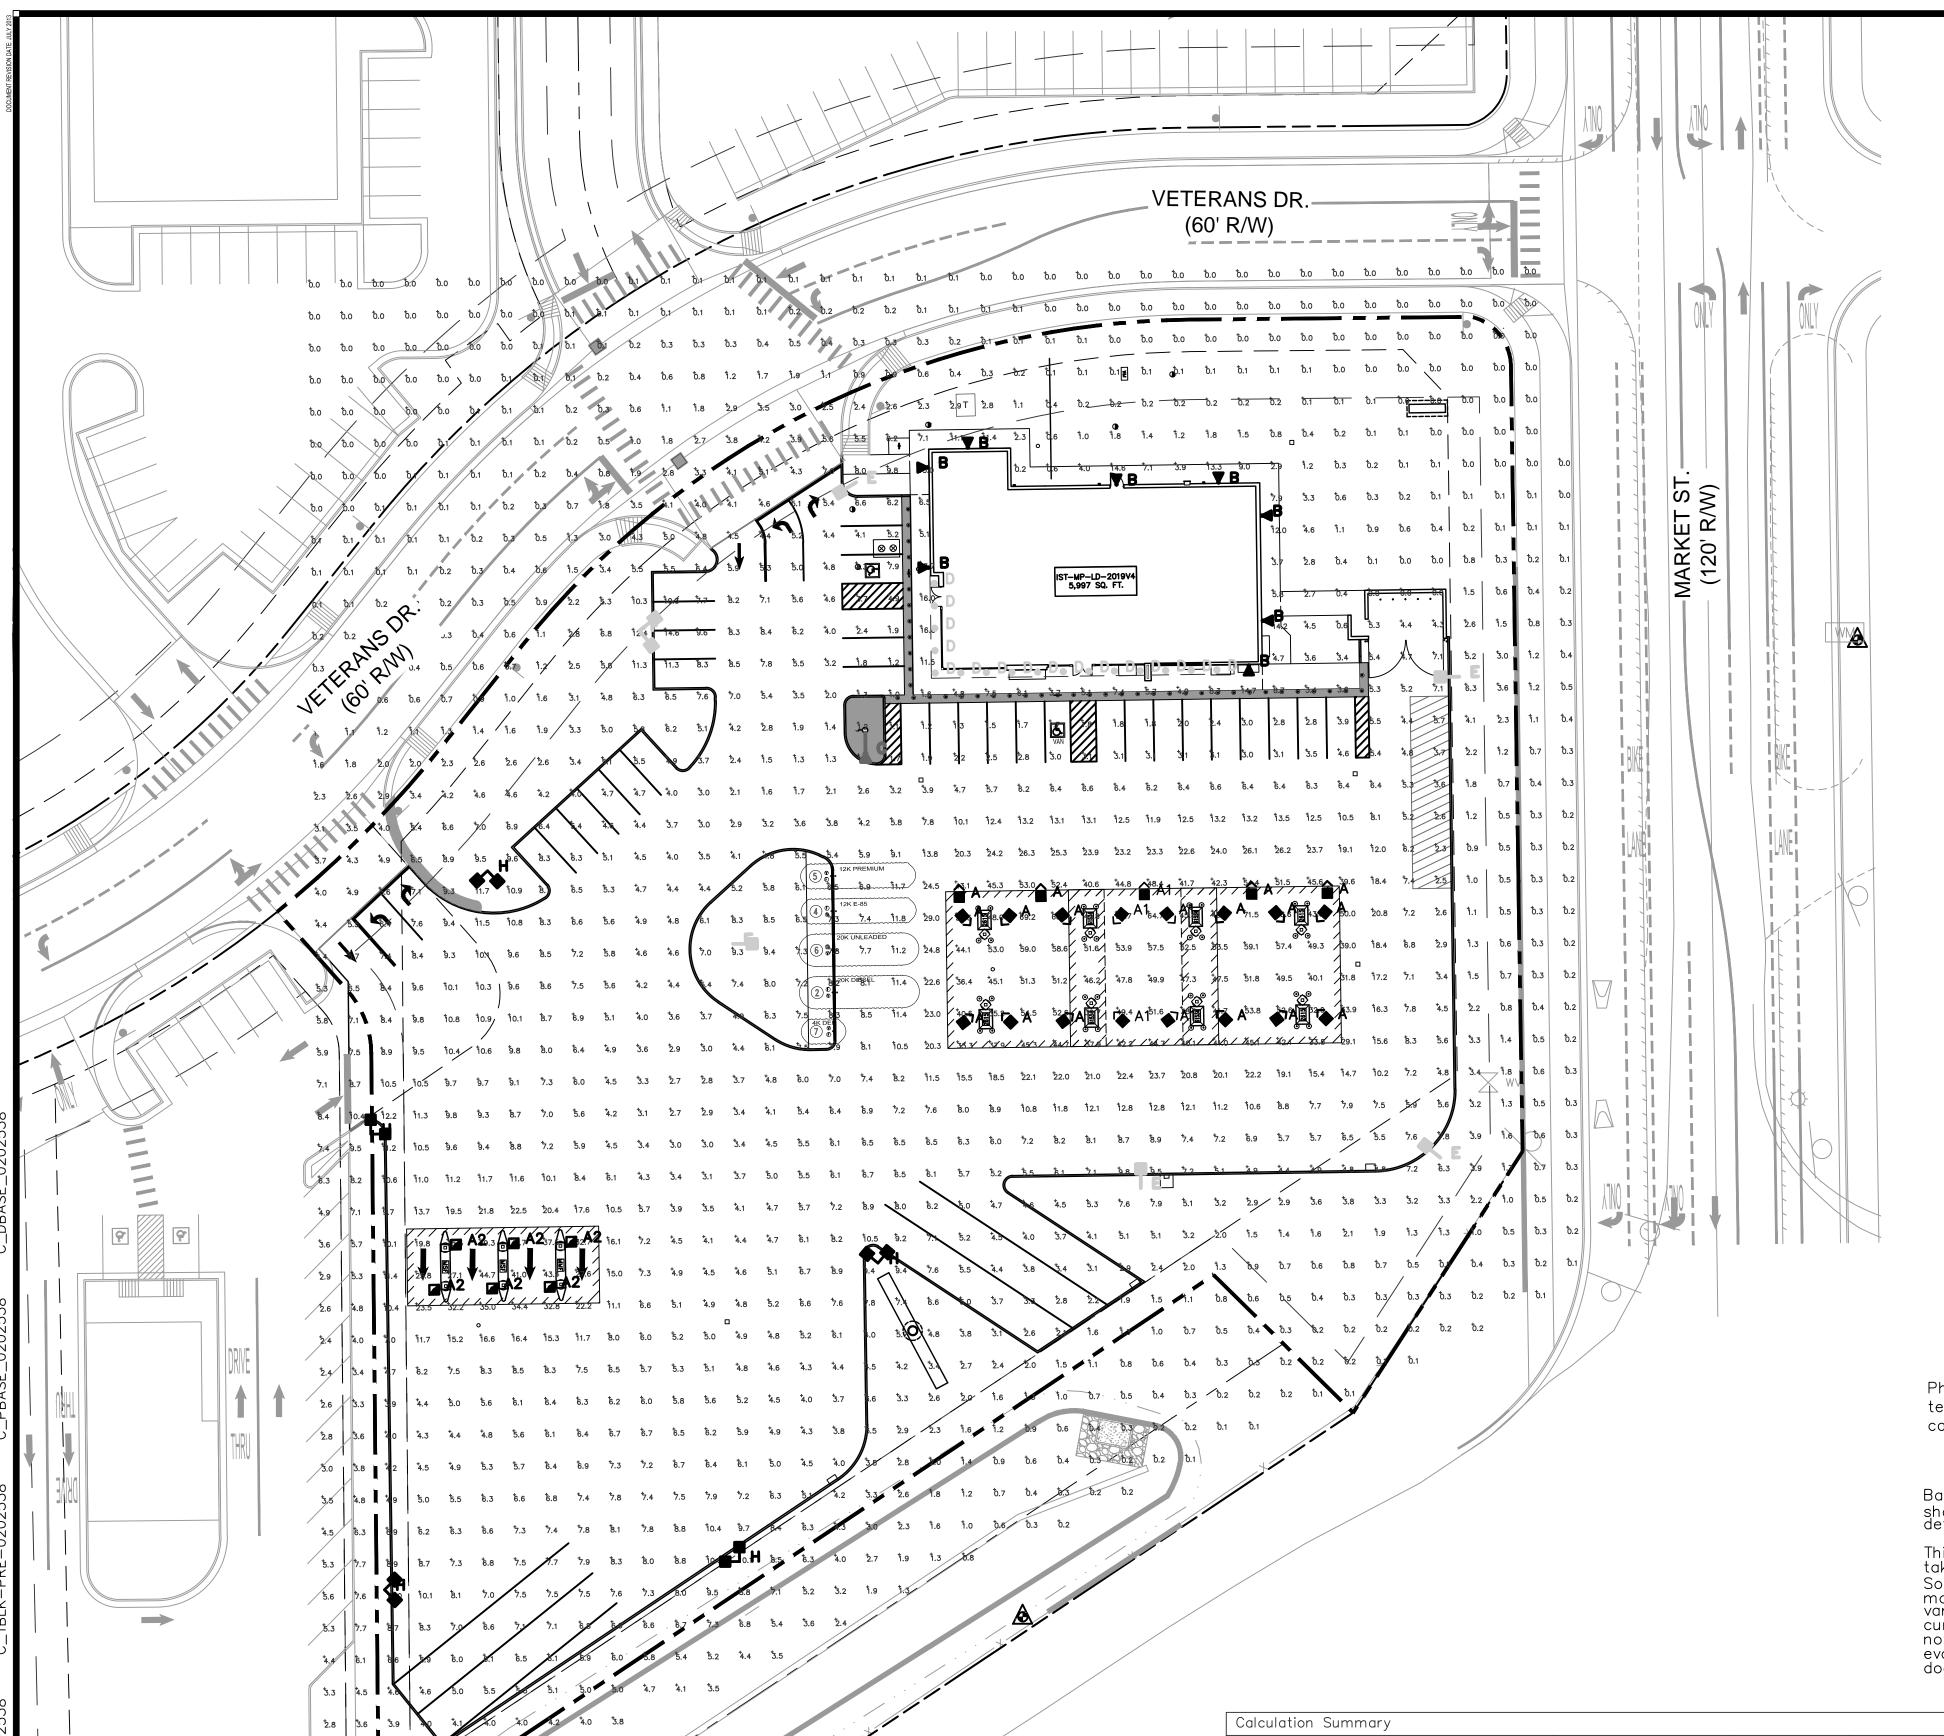








Photometric data for fixture types "B & D" are based upon another manufacturer's test and as a result can not be verified by LSI Industries for this calculation.

Based on the information provided, all dimensions and luminaire locations shown represent recommended positions. The engineer and/or architect must determine the applicability of the layout to existing or future field conditions.

This lighting plan represents illumination levels calculated from laboratory data taken under controlled conditions in accordance with The Illuminating Engineering Society (IES) approved methods. Actual performance of any manufacturer's luminaires may vary due to changes in electrical voltage, tolerance in lamps/LED's and other variable field conditions. Calculations do not include obstructions such as buildings, curbs, landscaping, or any other architectural elements unless noted. Fixture nomenclature noted does not include mounting hardware or poles. This drawing is for photometric evaluation purposes only and should not be used as a construction document or as a final document for ordering product.

Calculation Summary							
Label	CalcType	Units	Avg	Max	Min	Avg/Min	Max/Min
ALL CALC POINTS	Illuminance	Fc	6.95	71.5	0.0	N.A.	N.A.
INSIDE PUMP FACE_Side_2	Illuminance	Fc	35.33	38.0	28.7	1.23	1.32
DIESEL CANOPY	Illuminance	Fc	33.12	44.7	19.8	1.67	2.26
GAS CANOPY	Illuminance	Fc	44.55	71.5	28.7	1.55	2.49
INSIDE CURB	Illuminance	Fc	8.15	54.4	1.0	8.15	54.40

Luminaire Sc	chedule								
Symbol	Qty	Label	Arrangement	Description	LLD	UDF	LLF	Arr. Lum. Lumens	Arr. Watts
	16	А	SINGLE	SCV-LED-23L-SCFT-50 - 15.5' MH	1.000	1.000	1.000	24361	191.5
	5	A1	SINGLE	SCV-LED-23L-SCFT-50 - 17.5' MH	1.000	1.000	1.000	24361	191.5
	6	A2	SINGLE	SCV-LED-15L-SC-50-16' MH	1.000	1.000	1.000	15410	103
	8	В	SINGLE	WST LED P2 40K VW MVOLT — 11' MH — FIXTURE BY LITHONIA LIGHTING	1.000	1.000	1.000	3512	25
	1	С	SINGLE	TLFL-LED-20L- 4' MH	1.000	1.000	1.000	18768	187.91
0	16	D	SINGLE	DNR52609 LED6-40K - 9' MH - FIXTURE BY ATLANTIC LIGHTING	1.000	1.000	1.000	1579	23.8
	5	Е	SINGLE	SLM-LED-18L-SIL-FT-50-70CRI-BLK-SINGLE-16' POLE+2.5'BASE	1.000	1.000	1.000	19664	148.5
\$	1	F	2 @ 90 DEGREES	SLM-LED-18L-SIL-FT-50-70CRI-BLK-D90-16' POLE+2.5'BASE	1.000	1.000	1.000	39328	297
2	5	Н	2 @ 90 DEGREES	SLM-LED-36L-SIL-FT-50-70CRI-D90-30'POLE+2.5'BASE	1.000	1.000	1.000	75630	635.6

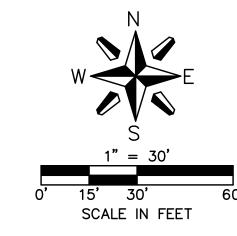



TOWN PLANNING APPROVAL

SHEET NUMBER: SE1.1 10 OF 15

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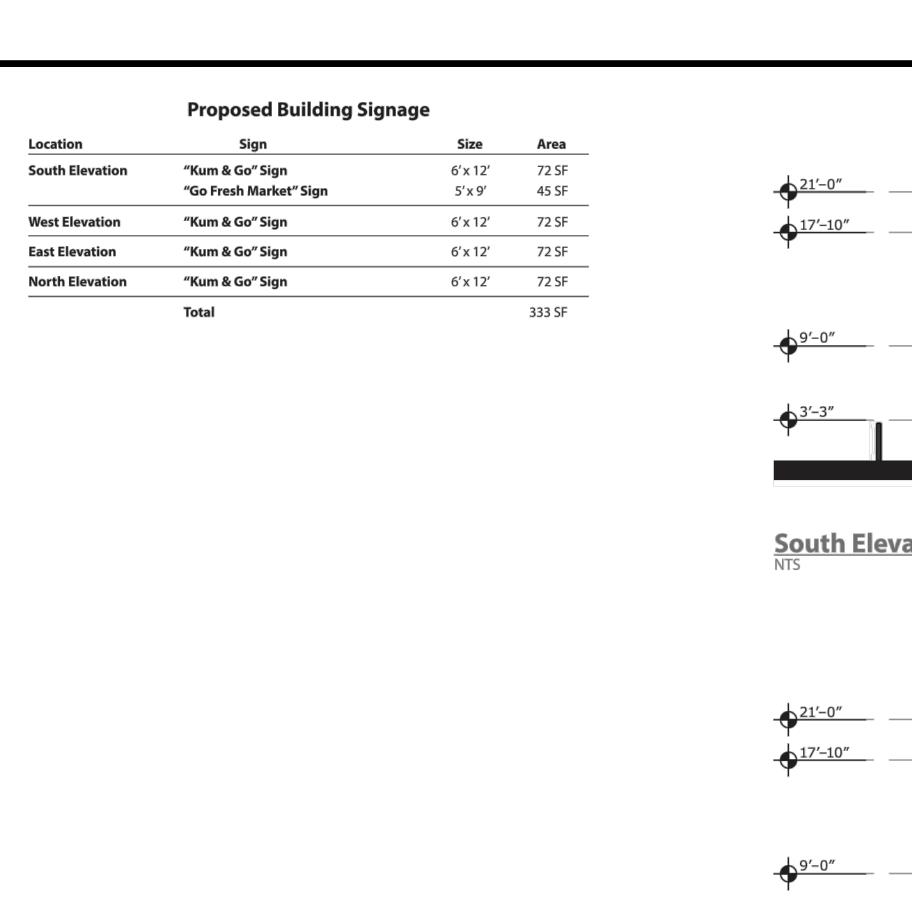



1459 Grand Avenue Des Moines, Iowa 50309 P: 515-226-0128 F: 515-223-9873


KEENESBURG, PHOTOMETRIC PLAN 240 MARKET #2906

KG PROJECT TEAM: RDM: TOM CARRICO SDM: RYAN HALDER CPM: PERRY DEPHILLIPS


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#2906 - KEENESBURG, 240 MARKET STREET EXTERIOR ELEVATIONS

KG PROJECT TEAM:
RDM: TOM CARRICO
SDM: RYAN HALDER
CPM: PERRY DEPHILLIPS

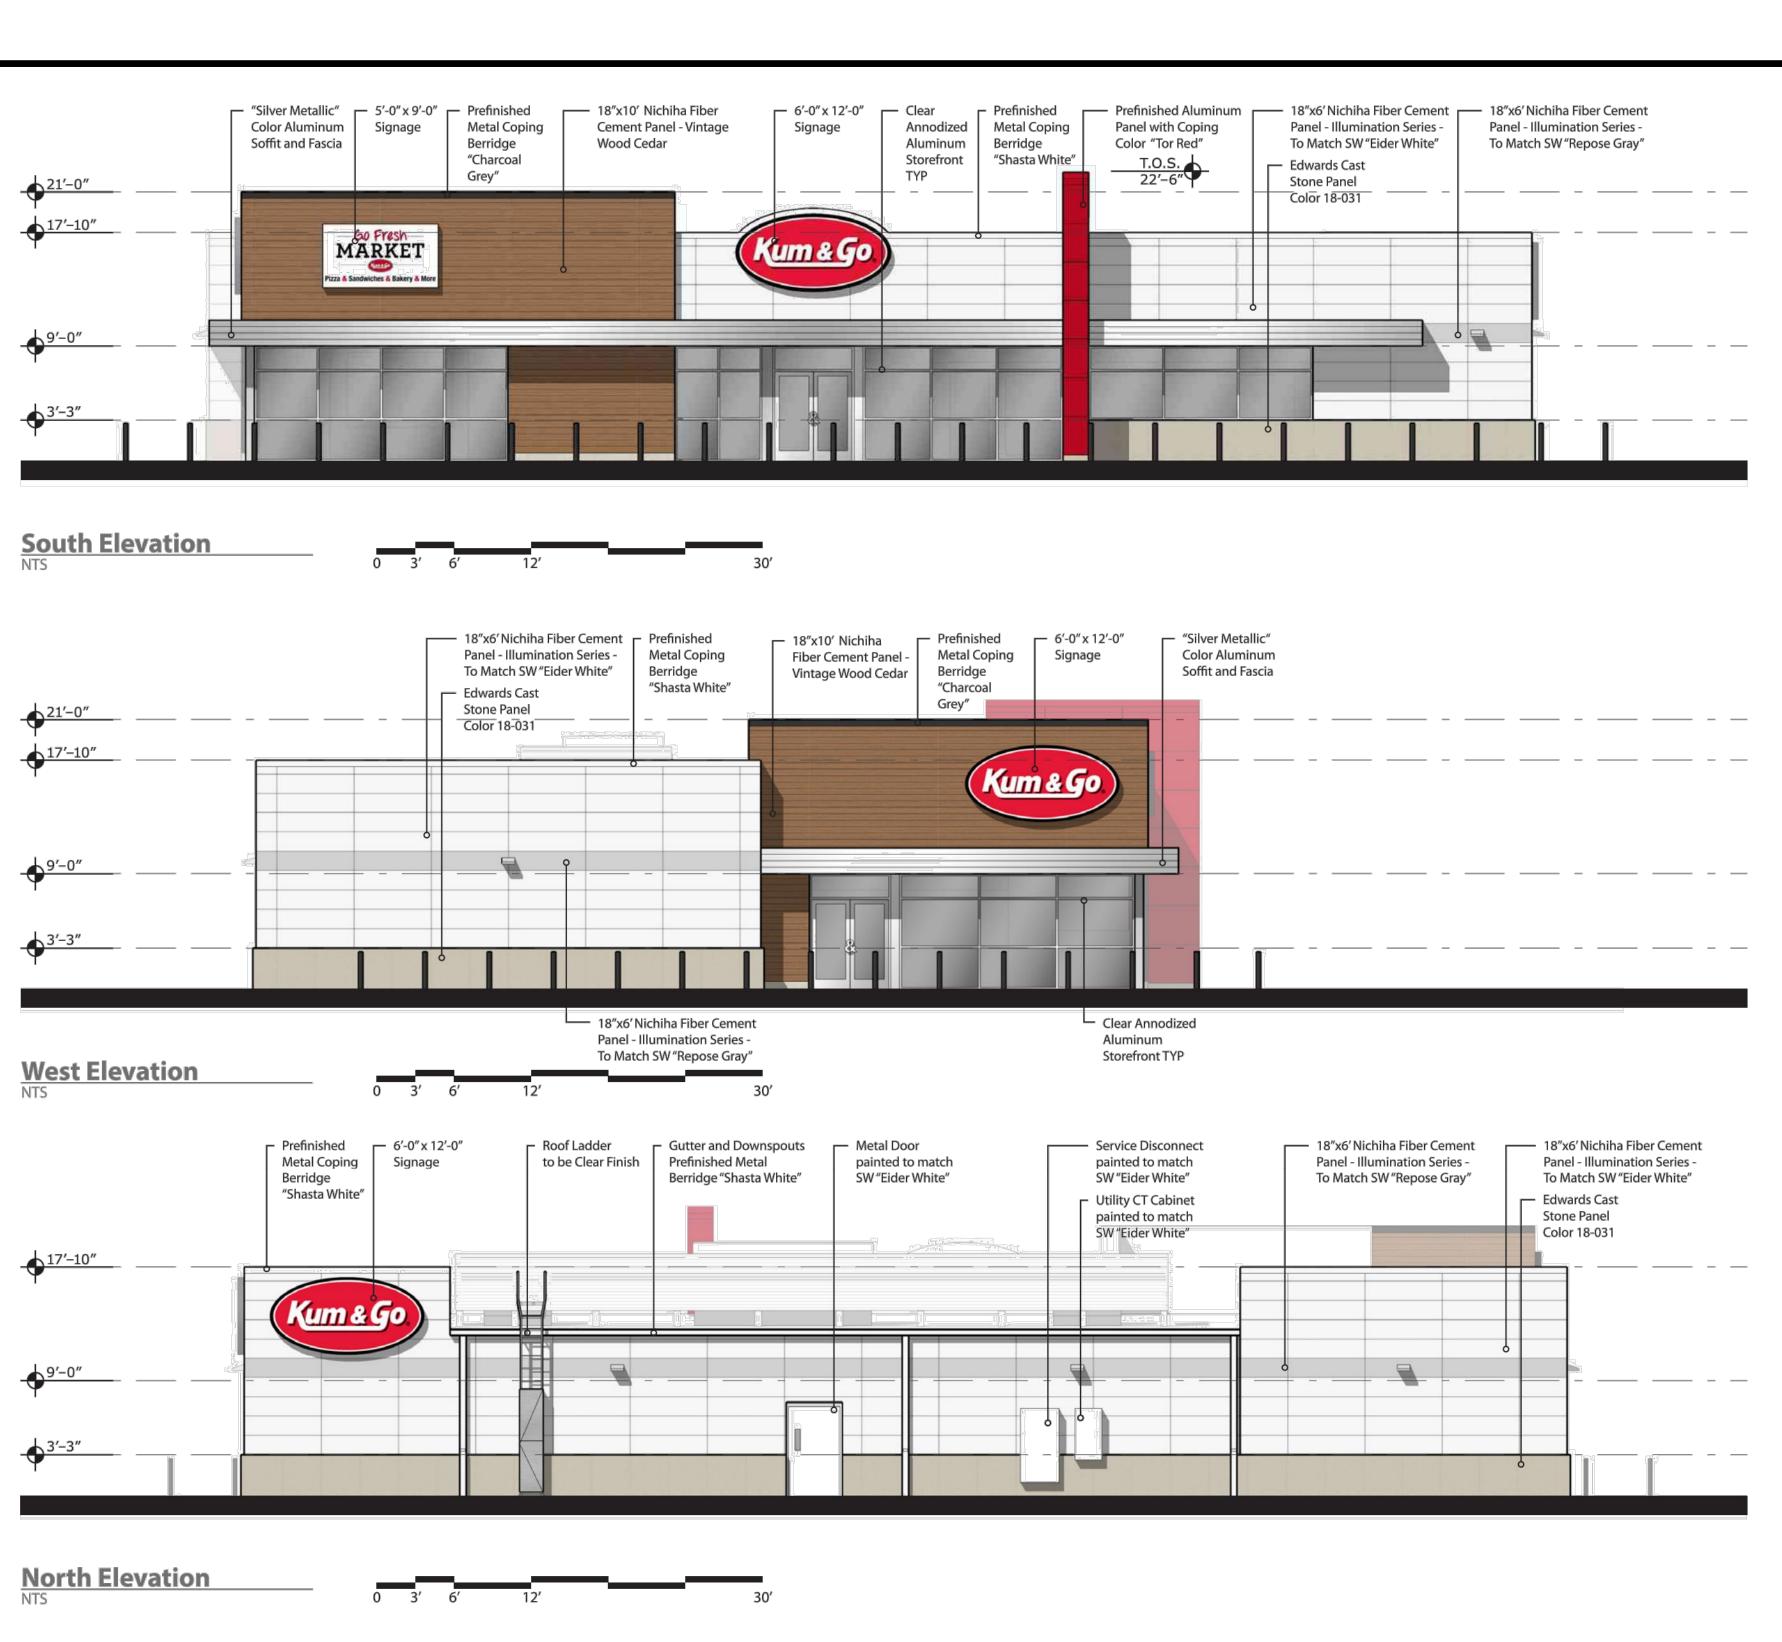REVISION DESCRIPTION

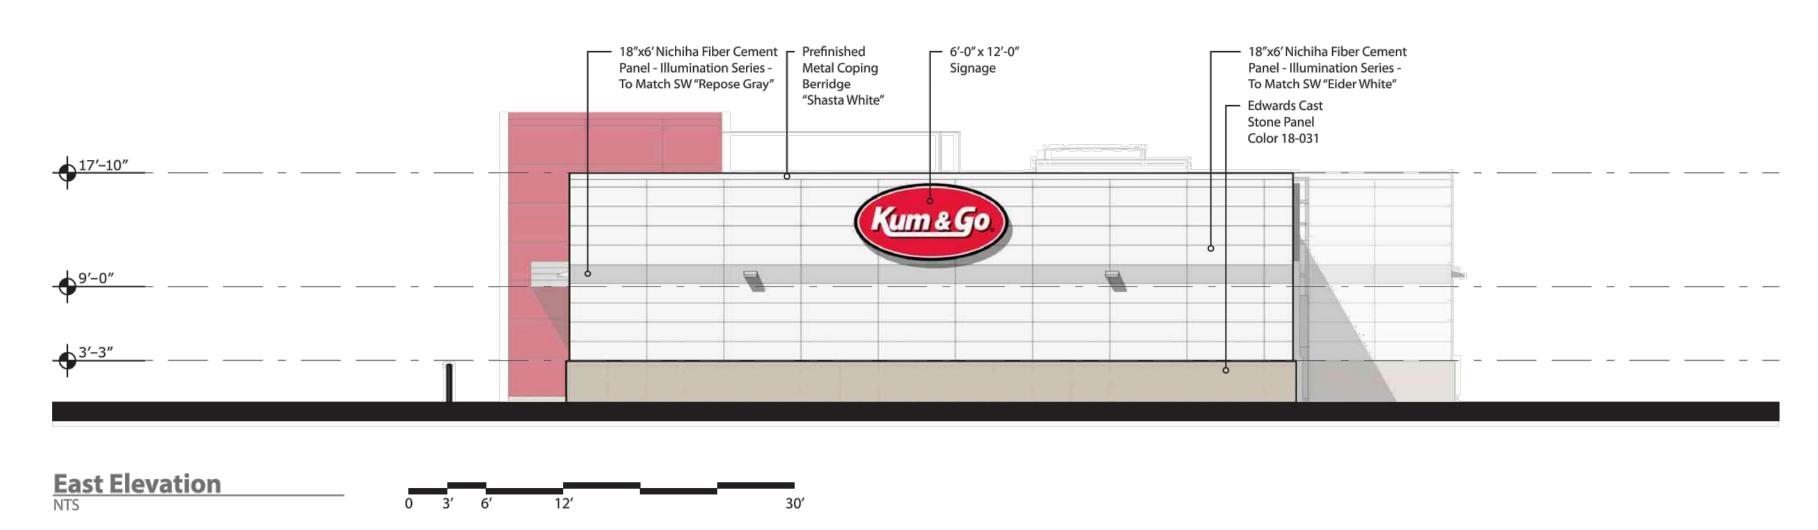
TOWN PLANNING APPROVAL

DATE

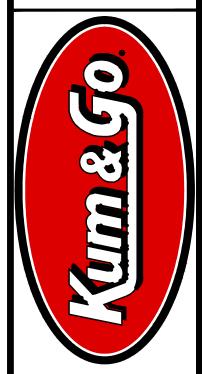
DATE: 10/23/2020


SHEET NUMBER: A1.1
11 OF 15

Location	Sign	Size	Area
South Elevation	"Kum & Go" Sign	3'x 6'	18 SF
North Elevation	No Signage	WC 200,000	0 SF
West Elevation	"Kum & Go" Sign	3'x 6'	18 SF
East Elevation	"Kum & Go" Sign	3'x 6'	18 SF
	Total		54 SF

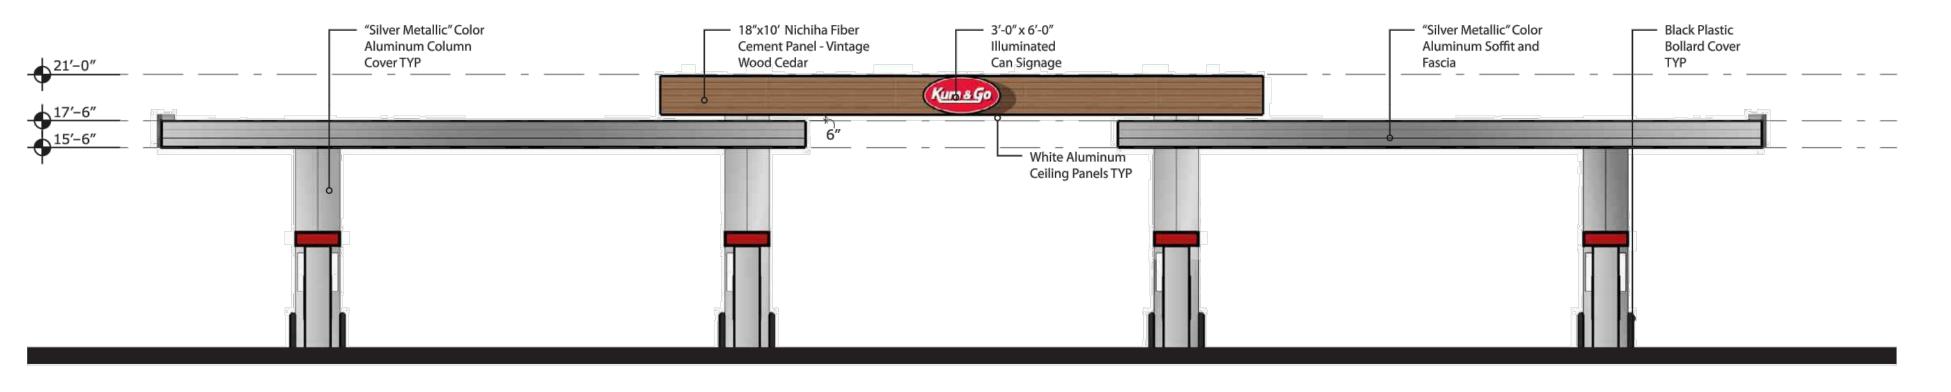




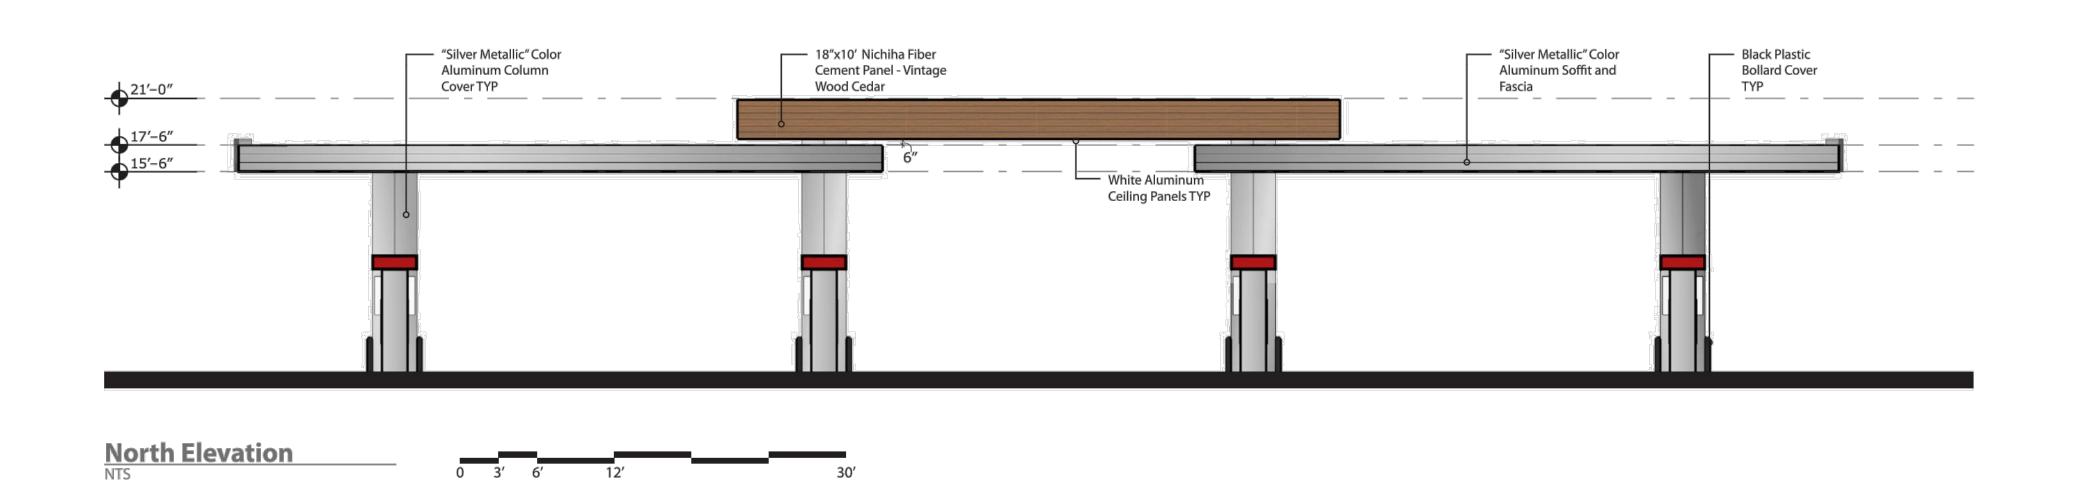

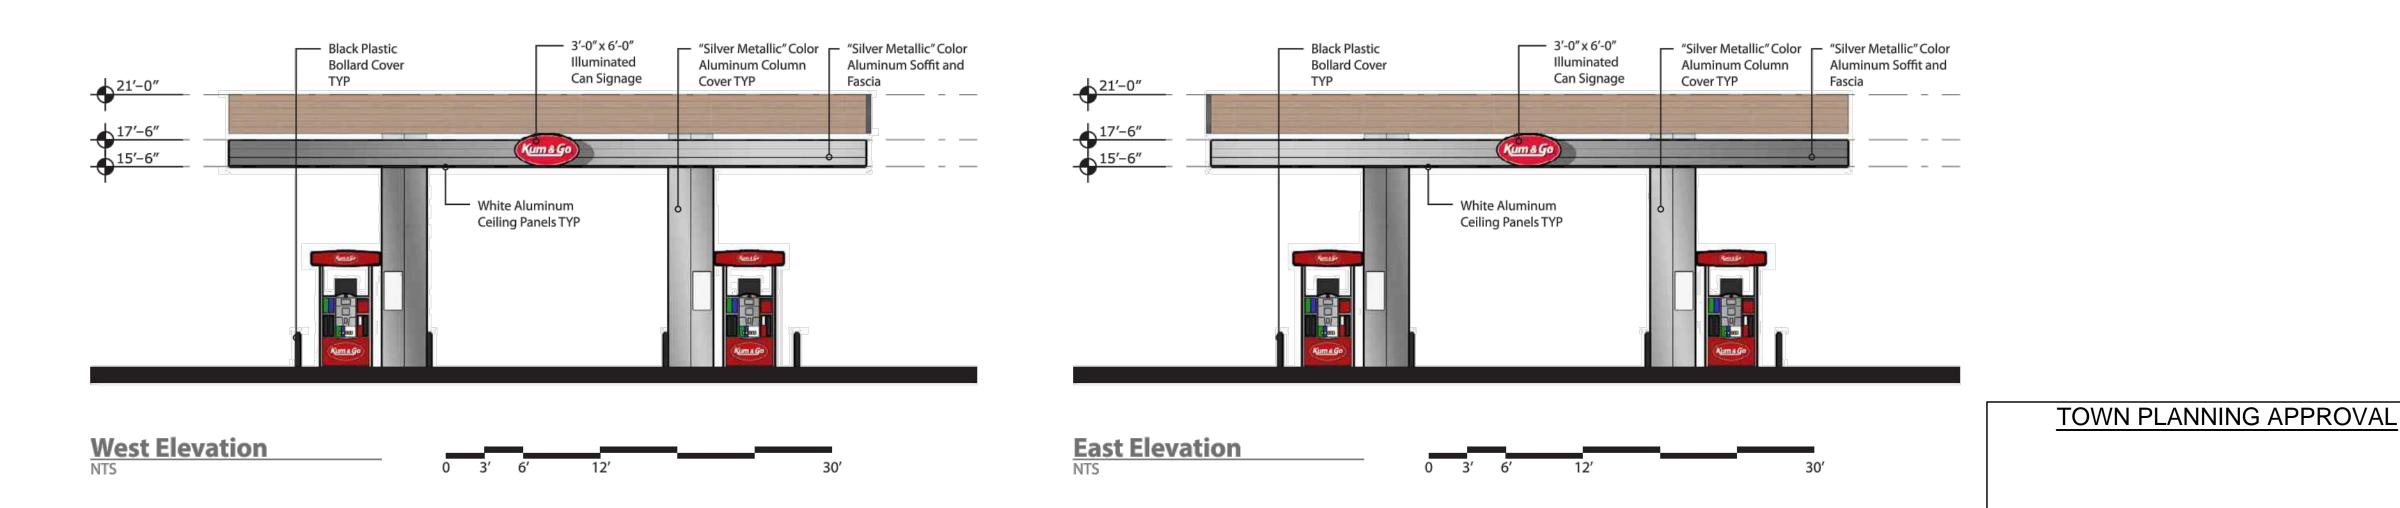

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#2906 - KEENESBURG, CO 240 MARKET STREET

CANOPY ELEVATIONS

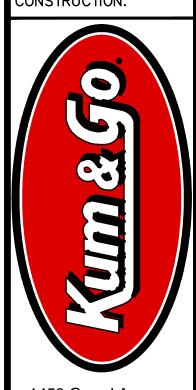KG PROJECT TEAM:
RDM: TOM CARRICO
SDM: RYAN HALDER
CPM: PERRY DEPHILLIPS

DATE

DATE: 10/23/2020

SHEET NUMBER: A1.2 12 OF 15 Location

North Elevation

South Elevation

**East Elevation** 

**West Elevation** 

"Kum & Go" Sign

"Kum & Go" Sign

"Kum & Go" Sign


0 SF


72 SF


"DEF" Sign

No Signage

Total

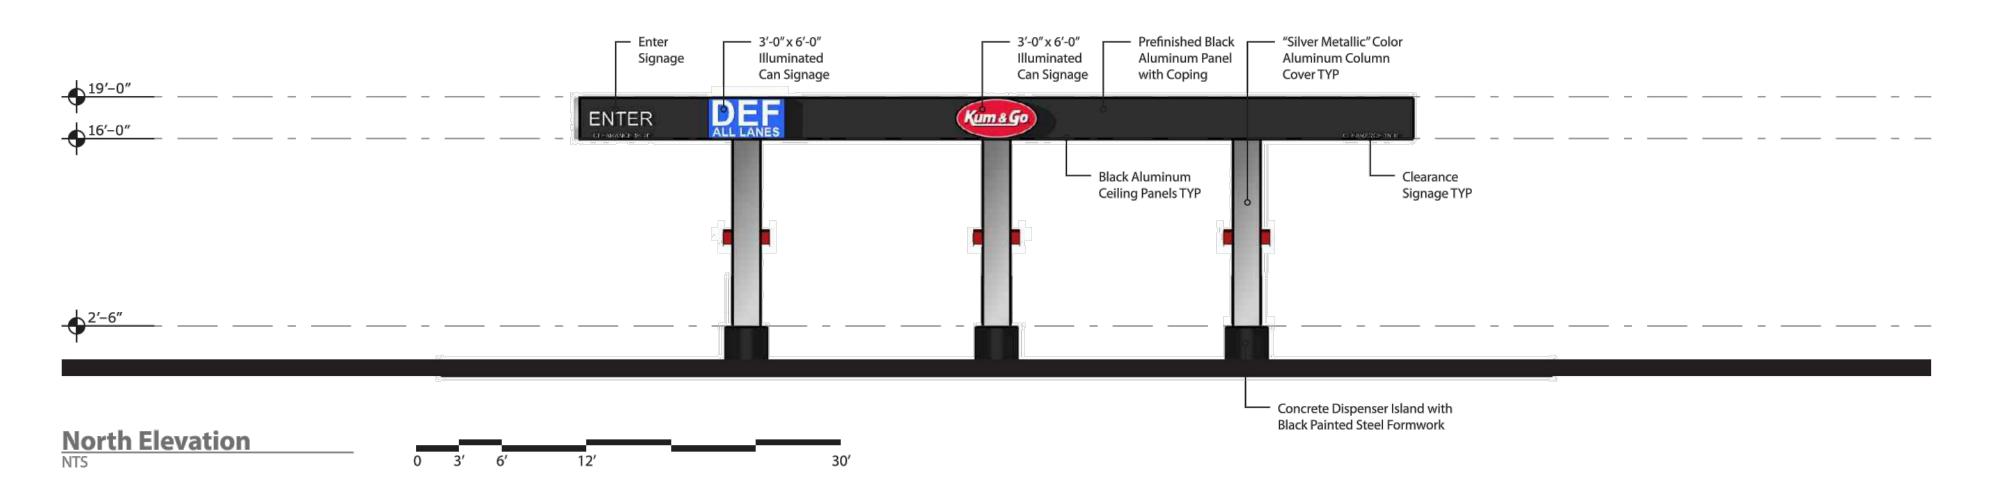

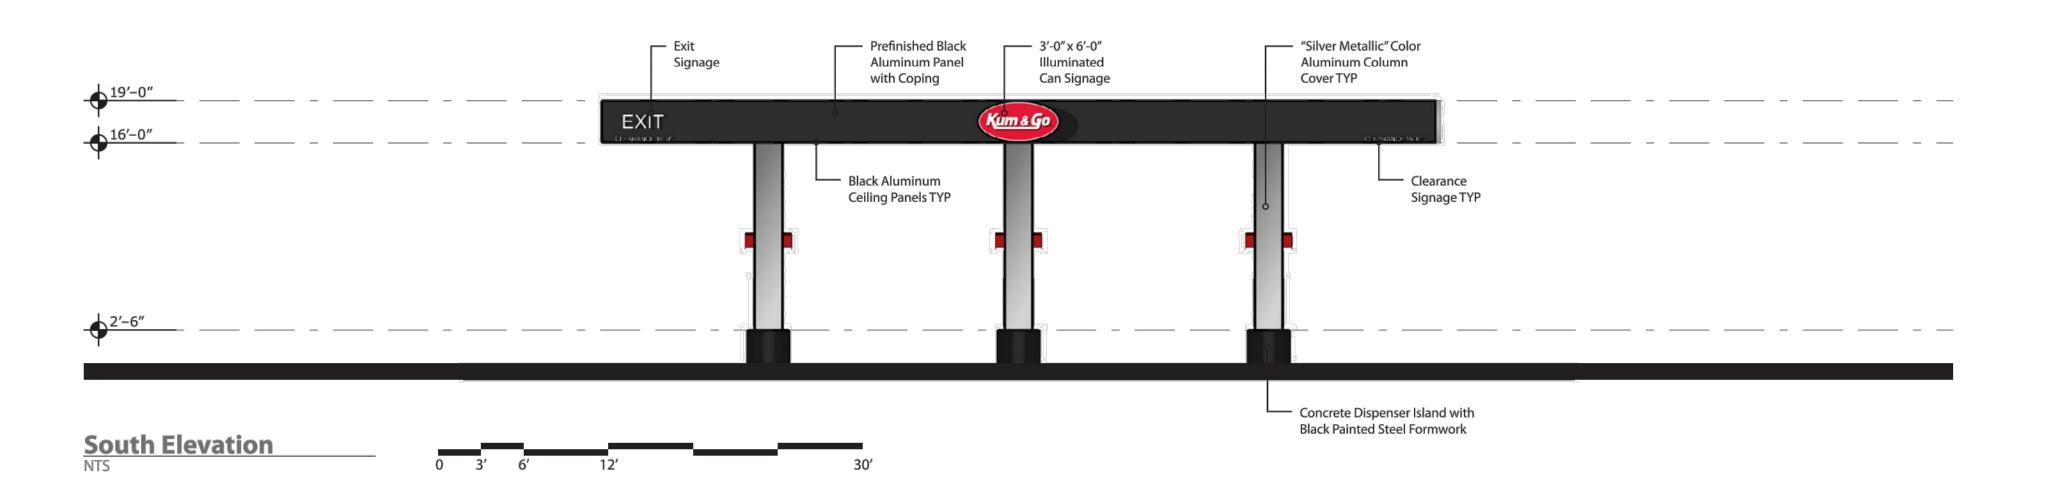

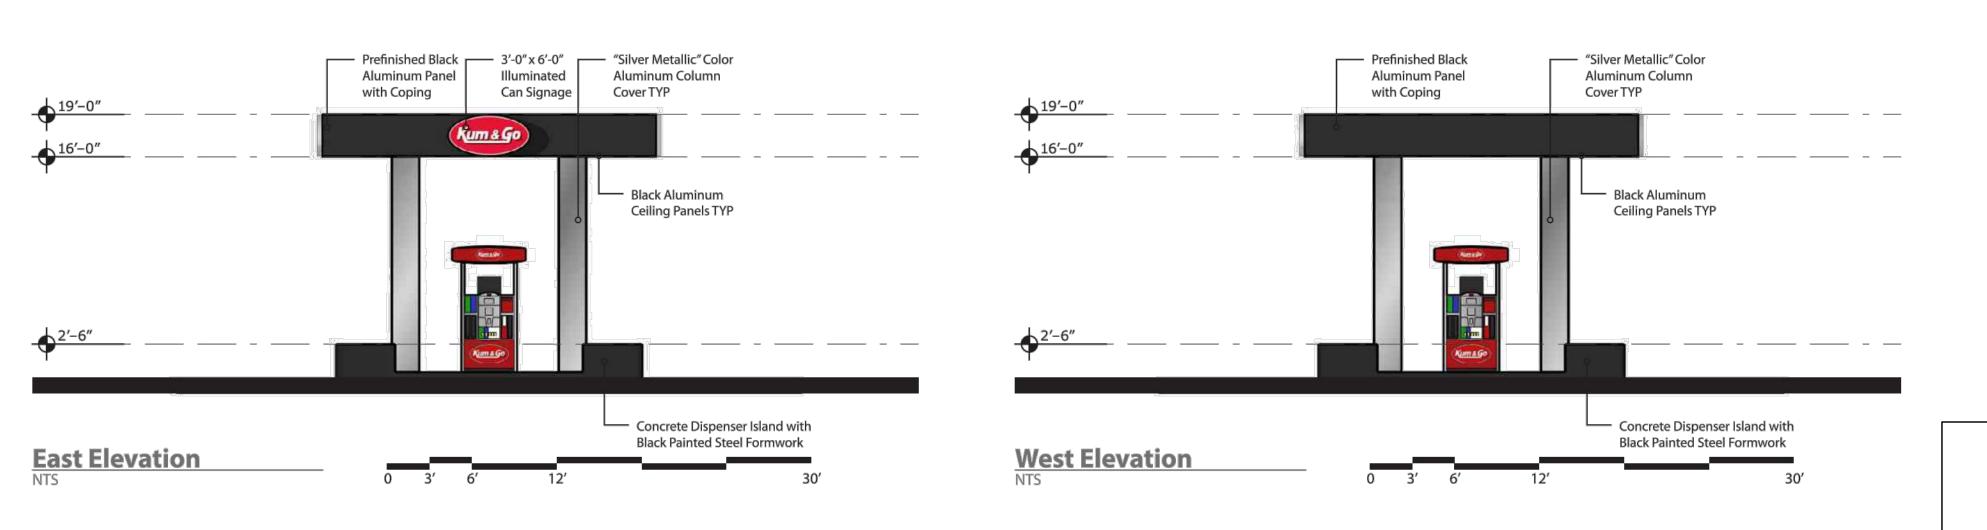

TOWN PLANNING APPROVAL

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00 - KEENESBURG, 240 MARKET STREET #2906


CANOPY ELEVATIONS

DIESEL

KG PROJECT TEAM: RDM: TOM CARRICO SDM: RYAN HALDER CPM: PERRY DEPHILLIPS

10/23/2020

SHEET NUMBER: A1.3 13 OF 15

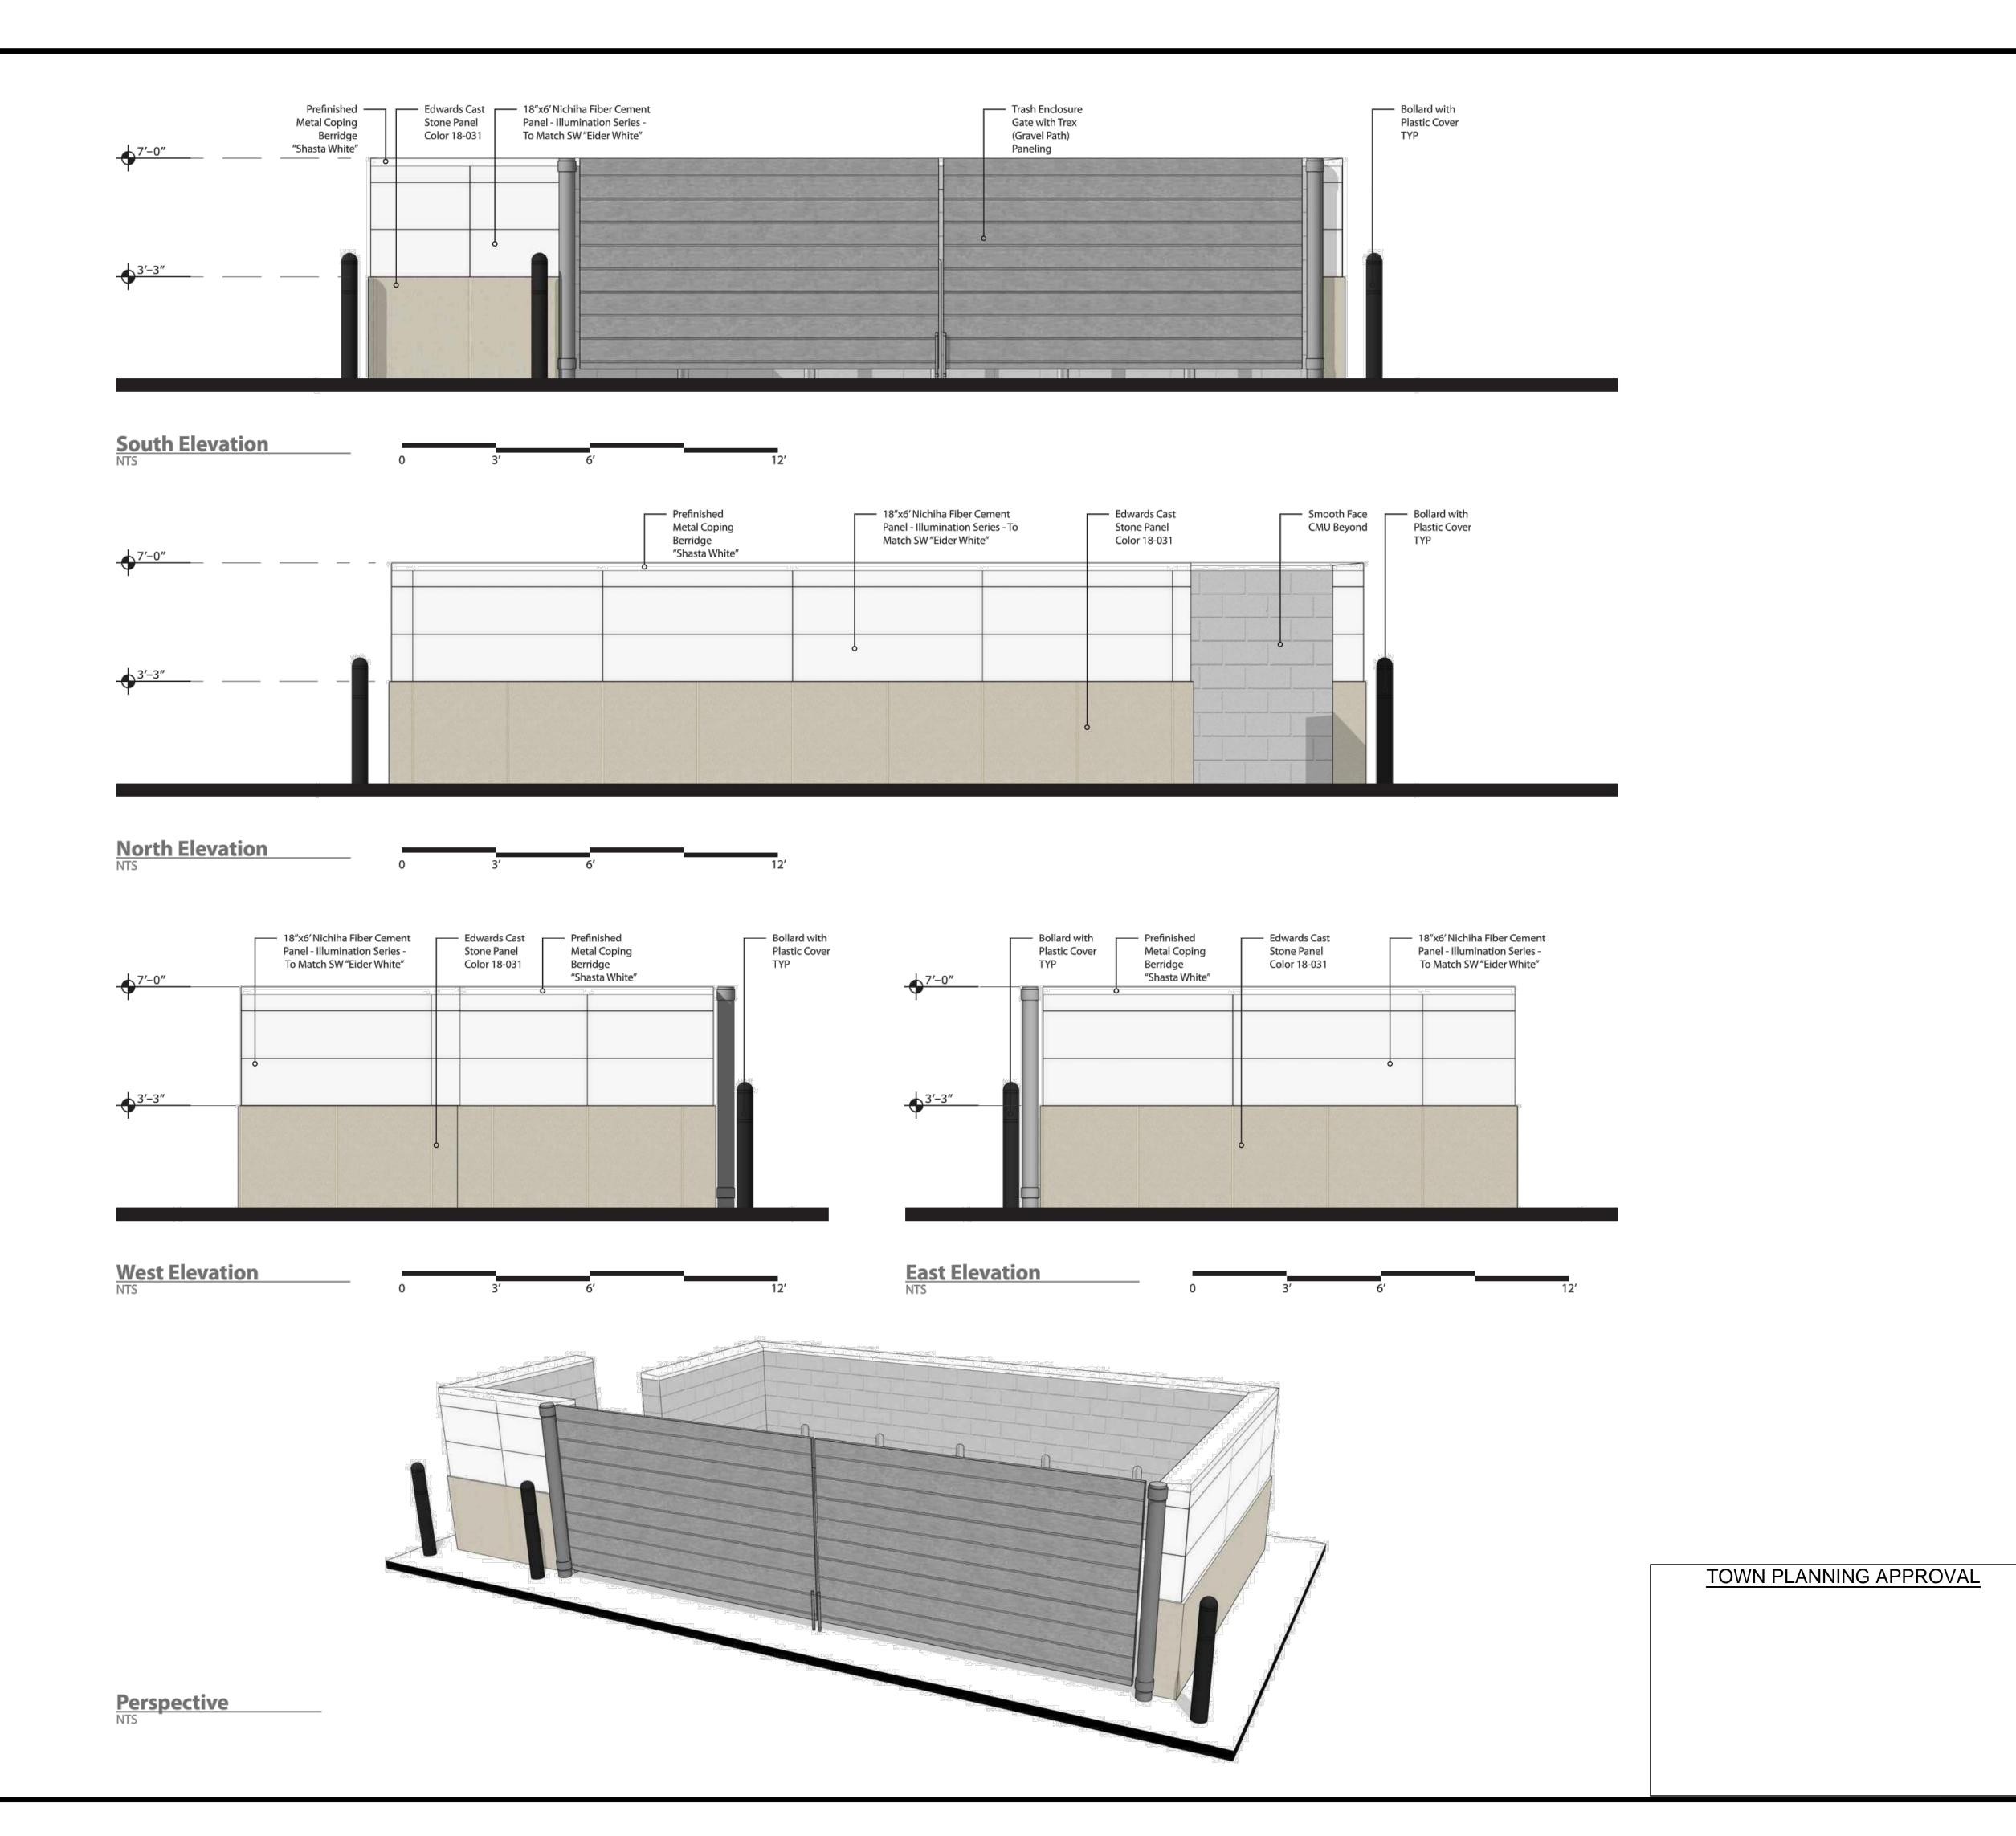

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#2906 - KEENESBURG, CO 240 MARKET STREET TRASH ENCLOSURE ELEVATIONS

KG PROJECT TEAM:
RDM: TOM CARRICO
SDM: RYAN HALDER
CPM: PERRY DEPHILLIPS

REVISION DESCRIPTION

ATE: 10/23/2020

SHEET NUMBER: A1.4 14 OF 15 18" OD x .500 (1/2") Wall Pipe x 24'

(93.45 Lbs per ft.)

Top-Middle-Bottom

plate rings
Top-Middle-Bottom

30" OD x .500 (1/2") Wall x 16' Pipe

48" OD x .500 (1/2") Wall x 38.25 Pipe

6'-9" Sleeve

(253.65 Lbs per ft.)

54" OD x .500 (1/2") Wall Pipe x 40'-0"

Side Elevation

scale: 1/8" = 1'- 0"

(285.69 Lbs per ft.)

All steel Primed and Finish is Gloss Black paint.

8 x 20' Pier Foundation

SEE STAMPED ENGINEERING FOR ACTUAL PIPE DIMENSIONS

(157.53 Lbs per ft.)

DIESEL



6' x 12' OVAL - 56.52 SQ FT PERIMETER=347.78


UNLEADED

8'-0"





A Elevation scale: 1/4" = 1'- 0"

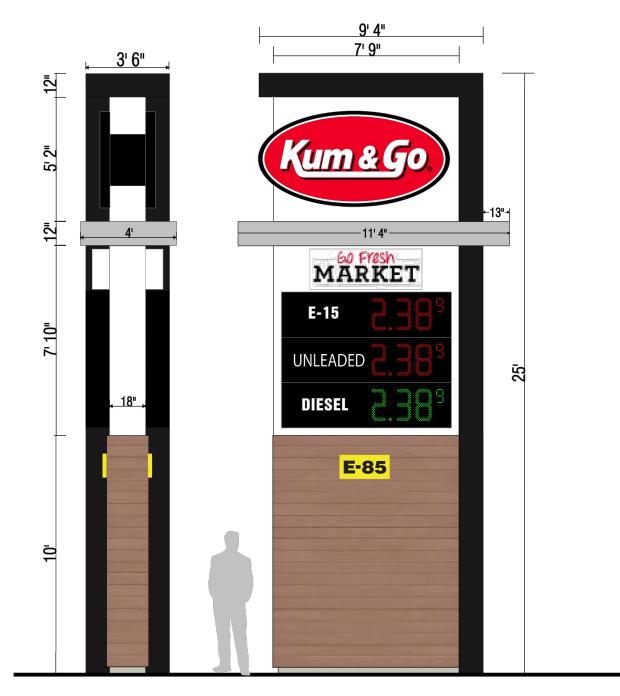

4' X 8' KUM & GO - AREA: 25.12 SQ FT 1' 8" X 4' 10" GO FRESH MARKET - AREA: 8.05 SQ FT 5' 7 5/8" X 7' 1" GAS PRICE SIGN - AREA: 39.92 SQ FT 1'x 2'-1" E-85 PANEL - AREA: 2.08 SQ FT

TOTAL - AREA: 75.17 SQ FT

-60 Fresh-**MARKET** Pizza & Sandwiches & Bakery & More

TYPICAL CONSTRUCTION OF MARKET FRESH SIGNS:

TOWN PLANNING APPROVAL

■ FLEX FACE WITH VINYL GRAPHICS ■ INTERNAL LED ILLUMINATION

■ PMS 200 (RED)



PERIMETER=174.39"

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F: 515-223-9873 00

KEENESBURG, SIGN ELEVATIONS 240 MARKET #2906

KG PROJECT TEAM: RDM: TOM CARRICO SDM: RYAN HALDER CPM: PERRY DEPHILLIPS

10/23/2020

SHEET NUMBER: A1.5 15 OF 15


FLAG POLE IS OWNER SUPPLIED - OWNER INSTALLED Alum. Ball, Gold Anodized,
Dia. to Match Pole Butt Size Stationary Truck, Heavy Duty, Cast Alum., with 1 1/4" Dia. Pulley on 1/4" Pin. Halyard, #10 (5/16" Dia.) Braided Rope, Polypropylene "D" **ECX40IH INTERNAL WITH WINCH** Taper 🖁 (Nom.) A 40 ft. Two Snaphooks, swivel, B 4 ft. bronze, chrome plated C 44 ft. Roller Sling with plastic coated Counterweight D 19′-3 in. Exposed | E | 7 in. Tapered Alum. Tube "C" Height "G" Base Wall, Alloy 6063-T6 F | 3.5 in. Total(Nom.) Satin Ground Finish Length G .156 in. Flush Access Door with Cylinder Lock, Continuous Piano Hinge, and Manually Operated Cam Cleat "E" Butt Diameter Spun Alum. Collar (Caulk collar perimeter by Installer) Concrete (by Installer)

Cement or Waterproof compound (by Installer) Dry Sand (by Installer) ➤ Ground Sleeve Assembly 16 Ga. Corrugated Galv. Steel Tube

Lighting Spike (3/4" dia., steel rod)

POLE SECTIONS: 2 QUANTITY 1 FINISH Satin Finish

CUSTOMER NAME: Kum & Go DATE: \_\_\_\_\_

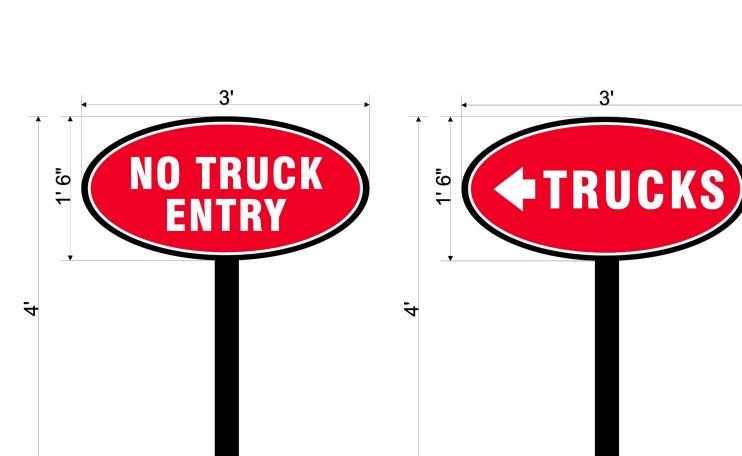

ALL LANES

SQUARE FOOTAGE OF SIGN

Elevation scale: 1/8" = 1'- 0"

17'x 34'KUM & GO SIGN 462.4 SQ. FT

 $9'-3'' \times 46'$  PRICE SIGN = 425.5 SQ. FT.

8'-8" x 12' DEF SIGN = 103.92 SQ. FT.

TOTAL SQUARE FOOTAGE = 991.82